
GEORGE JULIUS AVENUE PUBLIC DOMAIN CIVIL ENGINEERING PACKAGE

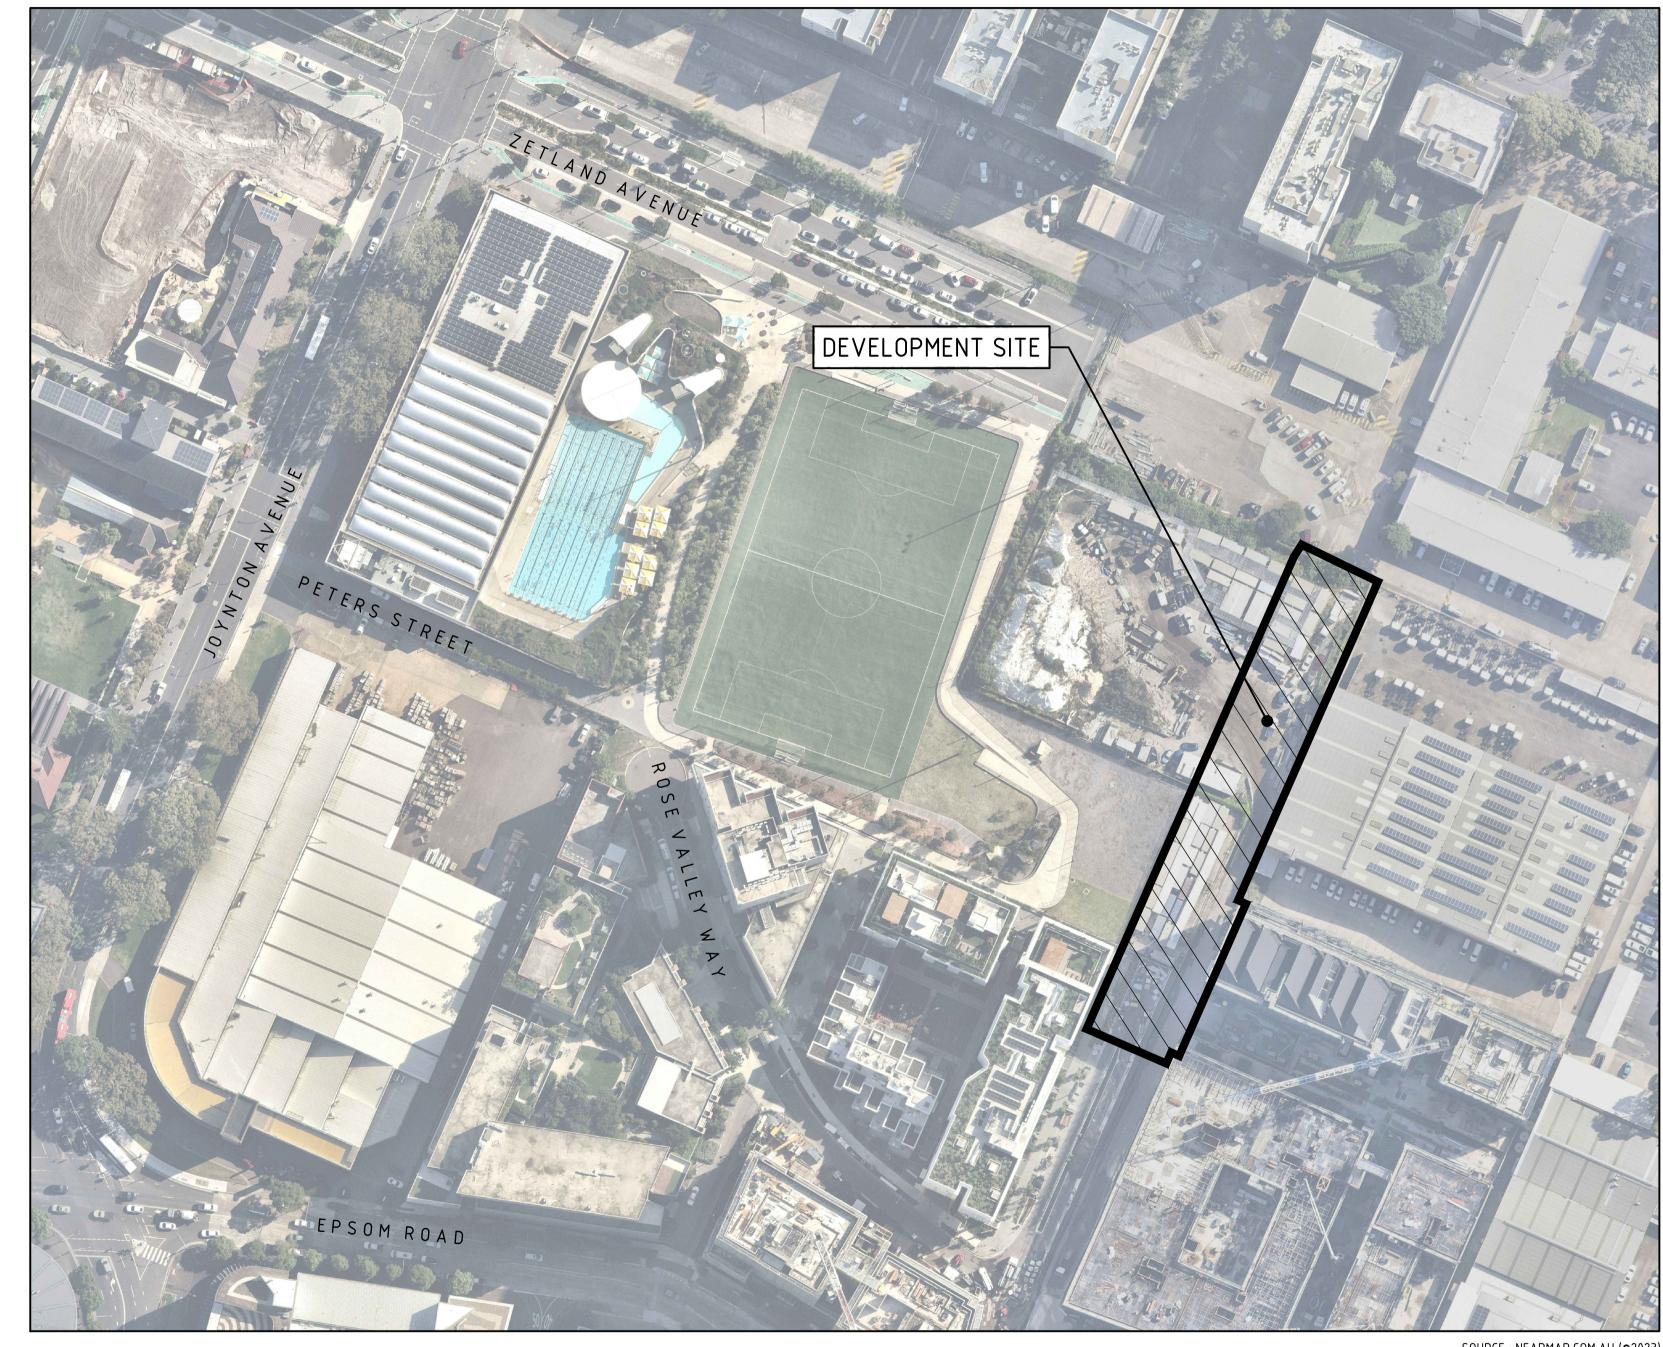


LOCALITY PLAN

REVISION	DESCRIPTION	ISSUED	VER'D	APP'D	DATE	CLIENT	ARCHITECT
01	ISSUED FOR 50% DESIGN DEVELOPMENT	BM		AR	26.05.23		
02	ISSUED FOR 50% DESIGN DEVELOPMENT	EJ		AR	20.06.23	CITYOFSYDNEY	
						DRAWING NOT TO BE USED FOR CONSTRUCTION UNLESS	THE COPYRIGHT
						VERIFICATION SIGNATURE HAS BEEN ADDED	NORTHROP CO

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DWG No.	DRAWING TITLE
C101.01	COVER SHEET, DRAWING SCHEDULE AND LOCALITY PLAN
C101.11	SPECIFICATION NOTES - SHEET 01
C101.12	SPECIFICATION NOTES - SHEET 02
C104.01	SITEWORKS AND STORMWATER MANAGEMENT PLAN - SHEET 01
C104.02	SITEWORKS AND STORMWATER MANAGEMENT PLAN - SHEET 02
C104.03	SITEWORKS AND STORMWATER MANAGEMENT PLAN - SHEET 03
C104.04	SITEWORKS AND STORMWATER MANAGEMENT PLAN - SHEET 04
C104.05	SITEWORKS AND STORMWATER MANAGEMENT PLAN - SHEET 05
C105.01	STORMWATER LONGITUDINAL SECTIONS - SHEET 01
C105.02	STORMWATER LONGITUDINAL SECTIONS - SHEET 02
C106.15	TYPICAL SECTION – SHEET 01
C106.21	ROAD LONGITUDINAL SECTIONS - SHEET 01





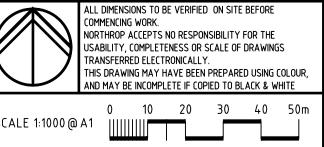

PROJECT PROJECT NAME GEORGE JULIUS AVENUE PUBLIC DOMAIN

NOT FOR CONSTRUCTION

DRAWING TITLE CIVIL ENGINEERING PACKAGE

COVER SHEET, DRAWING SCHEDULE AND LOCALITY PLAN

C101.01 02
DRAWING SHEET SIZE = A1

223309

REVISION

JOB NUMBER

DRAWING NUMBER

ALL CIVIL ENGINEERING CONSTRUCTION WORKS TO BE CARRIED OUT IN ACCORDANCE WITH CITY OF SYDNEY, SYDNEY STREETS TECHNICAL SPECIFICATION. THE AFOREMENTIONED GUIDELINES INCLUSIVE OF ALL SPECIFICATIONS TAKE PRECEDENCE OVER NOTES PROVIDED BELOW EXISTING SERVICES ACCESS AND SAFETY 1. THE CONTRACTOR SHALL COMPLY WITH ALL STATUTORY AND 1. ALL UTILITY SERVICES INDICATED ON THE DRAWINGS ORIGINATE 12. WHERE THERE IS INSUFFICIENT EXCAVATED MATERIAL SUITABLE FOR INDUSTRIAL REQUIREMENTS FOR PROVISION OF A SAFE WORKING FROM SUPPLIED DATA OR DIAL BEFORE YOU DIG SEARCHES, FILLING OR SUBGRADE REPLACEMENT, THE CONTRACTOR IS TO ALLOW TO IMPORT FILL. IMPORTED FILL SHALL COMPLY WITH THE FOLLOWING: ENVIRONMENT INCLUDING TRAFFIC CONTROL. THEREFORE THEIR ACCURACY AND COMPLETENESS IS NOT GUARANTEED. IT IS THE RESPONSIBILITY OF THE CONTRACTOR TO 12.1 BE OF VIRGIN EXCAVATED NATURAL MATERIAL OR THE CONTRACTOR SHALL PROVIDE TRAFFIC MANAGEMENT PLANS 12.2 CONTRACTOR TO PROVIDE EVIDENCE IMPORT IS SUITABLE FOR USE DETERMINE AND CONFIRM THE LOCATION AND LEVEL OF ALL EXISTING FOR THE PROPOSED WORKS COMPLETED BY A SUITABLY QUALIFIED SERVICES PRIOR TO THE COMMENCEMENT OF ANY WORK. ANY 12.3 PLASTICITY INDEX BETWEEN 2-15% AND CBR > 8 12.4 FREE FROM ORGANIC AND PERISHABLE MATTER PERSON AND APPROVED BY COUNCIL / REGULATORY AUTHORITY. DISCREPANCIES SHALL BE REPORTED TO THE SUPERINTENDENT WORK IS NOT TO COMMENCE ON SITE PRIOR TO APPROVAL OF CLEARANCES SHALL BE OBTAINED FROM THE RELEVANT SERVICE 12.5 MAXIMUM SIZE 50mm, PASSING 75 MICRON SIEVE (<25%) TRAFFIC MANAGEMENT SCHEME. AUTHORITY. NOTE SERVICE AUTHORITY REQUIREMENTS FOR 13. THE CONTRACTOR SHALL PROGRAM THE EARTHWORKS OPERATION SO LOCATING OF SERVICES PRIOR TO COMMENCEMENT OF WORKS. THE CONTRACTOR SHALL ENSURE THAT AT ALL TIMES ACCESS TO THAT THE WORKING AREAS ARE ADEQUATELY DRAINED DURING THE BUILDINGS ADJACENT THE WORKS IS NOT DISRUPTED. CARE TO BE TAKEN WHEN EXCAVATING NEAR EXISTING SERVICES. NO PERIOD OF CONSTRUCTION. THE SURFACE SHALL BE GRADED AND MECHANICAL EXCAVATIONS ARE TO BE UNDERTAKEN OVER SEALED OFF TO REMOVE DEPRESSIONS, ROLLERS MARKS AND SIMILAR WHICH WOULD ALLOW WATER TO POND AND PENETRATE THE WHERE NECESSARY THE CONTRACTOR SHALL PROVIDE SAFE COMMUNICATION, GAS OR ELECTRICAL SERVICES. HAND EXCAVATION PASSAGE OF VEHICLES AND/OR PEDESTRIANS THROUGH OR BY THE ONLY IN THESE AREAS. UNDERLYING MATERIAL. ANY DAMAGE RESULTING FROM THE SITE CONTRACTOR NOT OBSERVING THESE REQUIREMENTS SHALL BE 3. THE CONTRACTOR SHALL PROTECT AND MAINTAIN ALL EXISTING RECTIFIED AT THEIR COST. THE CONTRACTOR SHALL ENSURE PUBLIC ACCESS EXTERNAL TO THE SERVICES THAT ARE TO BE RETAINED IN THE VICINITY OF THE SITE IS IN ACCORDANCE WITH COUNCILS / AUTHORITY / SITE PROPOSED WORKS, ANY AND ALL DAMAGE TO THESE SERVICES AS A 14. IT IS THE RESPONSIBILITY OF THE CONTRACTOR TO ENSURE AND MANAGERS REQUIREMENTS. RESULT OF THESE WORKS SHALL BE REPAIRED BY THE CONTRACTOR MAINTAIN THE INTEGRITY OF ALL SERVICES, CONDUITS AND PIPES UNDER THE DIRECTION OF THE SUPERINTENDENT AT THE DURING CONSTRUCTION, SPECIFICALLY DURING THE BACKFILLING AND CONTRACTORS EXPENSE. COMPACTION PROCEDURE. ANY AND ALL DAMAGE TO NEW OR EXISTING SERVICES AS A RESULT OF THESE WORKS SHALL BE 4. THE CONTRACTOR SHALL ALLOW IN THE PROGRAM FOR THE REPAIRED BY THE CONTRACTOR AT NO ADDITIONAL COST. TREE PROTECTION ADJUSTMENT (IF REQUIRED) OF EXISTING SERVICES IN AREAS AFFECTED BY WORKS. 15. THE CONTRACTOR IS TO PROVIDE SAFETY BARRIERS, FENCING AND REFER TO LANDSCAPE / ARCHITECTS/NORTHROPS PLAN & THE CONTRACTOR SHALL ALLOW IN THE PROGRAM FOR THE CAPPING THE LIKE IN ACCORDANCE WITH OH&S AND REGULATORY AUTHORITY SPECIFICATION FOR TREES TO BE RETAINED AND PROTECTED. REQUIREMENTS AND TO ENSURE THE WORK SITE IS SAFE AT ALL OFF, EXCAVATION AND REMOVAL (IF REQUIRED) OF EXISTING SERVICES IN AREAS AFFECTED BY WORKS UNLESS DIRECTED TIMES. ANY EXISTING/PROPOSED TREES WHICH FORM PART OF THE FINAL OTHERWISE ON THE DRAWINGS OR BY THE SUPERINTENDENT. LANDSCAPING PLAN SHALL BE PROTECTED FROM CONSTRUCTION ACTIVITIES BY; 6. THE CONTRACTOR SHALL ENSURE THAT AT ALL TIMES SERVICES TO 2.1. PROTECTING THEM WITH BARRIER FENCING OR SIMILAR ALL BUILDINGS ARE NOT AFFECTED BY THE WORKS AND ARE MATERIALS INSTALLED OUTSIDE THE DRIP LINE. MAINTAINED AND NOT DISRUPTED. ENSURING THAT NOTHING IS NAILED TO ANY PART OF THE TREE GENERAL NOTES 2.3. CARE IS TAKEN NOT TO CUT ROOTS UNNECESSARILY. COUNCILS 7. PRIOR TO COMMENCEMENT OF ANY WORKS THE CONTRACTOR SHALL AND/OR INDEPENDENT ARBORISTS TO BE CONSULTED WHERE GAIN APPROVAL OF THE PROGRAM FOR THE RELOCATION AND/OR TREE ROOTS ARE TO BE REMOVED AND/OR CUT. THESE DRAWINGS SHALL BE READ IN CONJUNCTION WITH OTHER CONSTRUCTION OF TEMPORARY SERVICES AND FOR ANY ASSOCIATED CONSULTANTS' DRAWINGS AND SPECIFICATIONS AND WITH OTHER SUCH INTERRUPTION OF SUPPLY. WRITTEN INSTRUCTIONS AS MAY BE ISSUED DURING THE COURSE OF THE THE CONTRACTOR SHALL CONSTRUCT TEMPORARY SERVICES TO CONTRACT. ANY DISCREPANCY SHALL BE REFERRED TO THE ENGINEER SEDIMENT AND SOIL EROSION BEFORE PROCEEDING WITH THE WORK. MAINTAIN EXISTING SUPPLY TO BUILDINGS REMAINING IN OPERATION DURING WORKS TO THE SATISFACTION AND APPROVAL OF THE SUPERINTENDENT. ONCE DIVERSION IS COMPLETE AND COMMISSIONED ALL DIMENSIONS ARE IN MILLIMETRES & ALL LEVELS ARE IN METRES, UNO THE SEDIMENT & EROSION CONTROL PLAN PRESENTS CONCEPTS THE CONTRACTOR SHALL REMOVE ALL SUCH TEMPORARY SERVICES (UNLESS NOTED OTHERWISE). ONLY. THE CONTRACTOR SHALL AT ALL TIMES BE RESPONSIBLE FOR AND MAKE GOOD TO THE SATISFACTION OF THE SUPERINTENDENT. THE ESTABLISHMENT & MANAGEMENT OF A DETAILED SCHEME NO DIMENSION SHALL BE OBTAINED BY SCALING THE DRAWINGS. MEETING COUNCILS AND OTHER REGULATORY AUTHORITY 9. THE CONTRACTOR IS TO ALLOW TO POTHOLE ANY SERVICES WITHIN REQUIREMENTS AND MAKE PAYMENT OF ALL FEES. A PUBLIC RESERVE WITHIN THE EXTENT OF WORKS (E.G. ALL LEVELS AND SETTING OUT DIMENSIONS SHOWN ON THE DRAWINGS STORMWATER CROSSINGS). SHALL BE CHECKED ON SITE PRIOR TO THE COMMENCEMENT OF THE WORK. THE CONTRACTOR SHALL INSTIGATE ALL SEDIMENT AND EROSION CONTROL MEASURES IN ACCORDANCE WITH STATUTORY SURVEY DATA WAS SUPPLIED BY CARDNO, DRAWING DATED 29.01.2016. REQUIREMENTS AND IN PARTICULAR THE 'BLUE BOOK' (MANAGING THIS DESIGN HAS BEEN PREPARED WITHOUT ACCESS TO DETAILED URBAN STORMWATER SOILS AND CONSTRUCTION), PRODUCED BY SURVEY OF ROAD CORRIDOR LANDCOM AND COUNCILS POLICIES. THESE MEASURES ARE TO BE STANDARD DETAILS 2. FINAL DESIGN ALIGNMENT AND LEVELS SUBJECT TO CHANGE UPON INSPECTED AND MAINTAINED ON A DAILY BASIS. RECEIPT OF SURVEY THE CONTRACTOR SHALL ENSURE THAT ALL SOIL AND WATER ANY DISCREPANCIES TO BE REPORTED IMMEDIATELY TO NORTHROP MANAGEMENT WORKS ARE LOCATED AS INSTRUCTED IN THE EXISTING SERVICES WHERE SHOWN HAVE BEEN PLOTTED FROM SUPPLIED ENGINEERS FOR CLARIFICATION DRAWINGS AND ADHERE TO ALL REGULATORY AUTHORITY DATA AND SUCH THEIR ACCURACY CAN NOT BE GUARANTEED. IT IS THE REQUIREMENTS. RESPONSIBILITY OF THE CONTRACTOR TO ESTABLISH THE LEVEL OF ALL COUNCIL DETAILS - CITY OF SYDNEY EXISTING SERVICES PRIOR TO THE COMMENCEMENT OF WORK. DRAWING TITLE <u>COMPONENT</u> DWG REFERENCE THE CONTRACTOR SHALL INFORM ALL SUB CONTRACTORS OF THEIR RESPONSIBILITIES IN MINIMISING THE POTENTIAL FOR SOIL EROSION ON COMPLETION OF STORMWATER INSTALLATION, ALL DISTURBED AREAS FOOTPATH - CONCRETE 2.3.1, 2.3.4, 2.3.5, AND POLLUTION TO DOWNSTREAM LANDS AND WATERWAYS. /ARIES MUST BE RESTORED TO ORIGINAL CONDITION, INCLUDING KERBS, UNIT PAVING 2.3.8, 2.3.11 FOOTPATHS, CONCRETE AREAS, GRAVEL AND GRASSED AREAS AND ROAD WHERE PRACTICAL. THE SOIL EROSION HAZARD ON THE SITE SHALL ROAD - ASPHALT PAVEMENTS, UNLESS DIRECTED OTHERWISE. BE KEPT AS LOW AS POSSIBLE. TO THIS END, WORKS SHOULD BE 3.1.1 YPICAL PAVEMENT DETAILS PAVEMENT UNDERTAKEN IN THE FOLLOWING SEQUENCE; PARKING – CONCRETE 5.1. CONSTRUCT TEMPORARY STABILISED SITE ACCESS INCLUSIVE OF 3.1.10 CONCRETE UNIT PAVEMENT UNIT PAVING SHAKE DOWN / WASH PAD. CAST IN-SITU KERB AND 5.2. INSTALL ALL TEMPORARY SEDIMENT FENCES AND BARRIER KERBS 1.1.2 GUTTER DETAILS FENCES. WHERE FENCES ADJACENT EACH OTHER. THE SEDIMENT FENCE CAN BE INCORPORATED INTO THE BARRIER FENCE. CONCRETE UNIT PAVING ALL STORMWATER MANAGEMENT MEASURES SHOWN ON THIS DRAWING VEHICLE CROSSING 2.3.9 5.3. INSTALL SEDIMENT CONTROL MEASURES AS OUTLINED ON THE VEHICULAR CROSSING HAVE BEEN PREPARED FOR DEVELOPMENT APPLICATION PURPOSES TO APPROVED PLANS. CONCRETE UNIT PAVING DEMONSTRATE FEASIBILITY. ALL MEASURES WILL BE SUBJECT TO DETAIL KERB RAMPS 2.3.6 PEDESTRIAN RAMP DESIGN AT THE CONSTRUCTION CERTIFICATE STAGE AND MAY BE SUBJECT UNDERTAKE SITE DEVELOPMENT WORKS SO THAT LAND TO VARIATION PROVIDED THAT THE DESIGN INTENT IS MAINTAINED. DISTURBANCE IS CONFINED TO AREAS OF MINIMUM WORKABLE SIZE. DETAILS ARE PROVIDED ON THE BASIS THAT TYPICAL CITY OF SYDNEY 'SYDNEY STREETS STANDARD DRAWINGS' ARE TO BE USED. AT ALL TIMES AND IN PARTICULAR DURING WINDY AND DRY THE DEVELOPMENT MAY EXPLORE ALTERNATIVE DETAILS TO REDUCE WEATHER, LARGE UNPROTECTED AREAS WILL BE STABILISED / KEPT EMBODIED CARBON. THESE WILL BE PROVIDED TO CITY OF SYDNEY FOR APPROVAL. MOIST (NOT WET) TO KEEP DUST UNDER CONTROL ENSURING CONFORMITY TO REGULATORY AUTHORITY REQUIREMENTS. ANY SAND USED IN THE CONCRETE CURING PROCESS (SPREAD OVER THE SURFACE) SHALL BE REMOVED AS SOON AS POSSIBLE AND WITHIN 10 WORKING DAYS FROM PLACEMENT. WATER SHALL BE PREVENTED FROM ENTERING THE PERMANENT DRAINAGE SYSTEM UNLESS THE CATCHMENT AREA HAS BEEN STABILISED AND/OR ANY LIKELY SEDIMENT BEEN FILTERED OUT. 10. TEMPORARY SOIL AND WATER MANAGEMENT STRUCTURES SHALL BE REMOVED ONLY AFTER THE LANDS THEY ARE PROTECTING ARE STABILISED / REHABILITATED. 11. ALLOW FOR GRASS STABILISATION OF EXPOSED AREAS, OPEN CHANNELS AND ROCK BATTERS DURING ALL PHASES OF CONSTRUCTION. 12. EROSION AND SEDIMENT CONTROL MEASURES SHALL BE INSPECTED TO ENSURE THAT THEY OPERATE EFFECTIVELY. REPAIRS AND/OR MAINTENANCE SHALL BE UNDERTAKEN REGULARLY AND AS REQUIRED, PARTICULARLY FOLLOWING RAIN EVENTS. RECEPTORS FOR CONCRETE AND MORTAR SLURRIES, PAINTS, ACID WASHINGS, LIGHT-WEIGHT WASTE MATERIALS AND LITTER SHALL BE DISPOSED OF IN ACCORDANCE WITH REGULATORY AUTHORITY REQUIREMENTS. CONTRACTOR TO PAY ALL FEES AND PROVIDE EVIDENCE OF SAFE DISPOSAL. 14. IF A TEMPORARY SEDIMENT BASIN IS REQUIRED, ENSURE SAFE BATTER SLOPES IN ACCORDANCE WITH THE GEOTECHNICAL REPORT MAINTAIN ADEQUATE STORAGE VOLUME IN ACCORDANCE WITH PLANS. TEMPORARY PUMP 'CLEAN FLOCCULATED' WATER TO AUTHORITIES STORMWATER SYSTEM. ENSURE WHOLE DISTURBED SITE RUN-OFF IS DIRECTED TO TEMPORARY SEDIMENT BASIN. L DIMENSIONS TO BE VERIFIED ON SITE BEFORE EVISION DESCRIPTION ISSUED VER'D APP'D DATE CLIENT PROJECT ARCHITECT place OMMENCING WORK. NORTHROP PROJECT NAME 01 ISSUED FOR 50% DESIGN DEVELOPMENT AR 20.06.23 ЕJ NORTHROP ACCEPTS NO RESPONSIBILITY FOR THE JSABILITY, COMPLETENESS OR SCALE OF DRAWINGS design **CITYOFSYDNEY GEORGE JULIUS AVENUE** TRANSFERRED ELECTRONICALLY THIS DRAWING MAY HAVE BEEN PREPARED USING COLOUR PUBLIC DOMAIN

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RAWING TITLE

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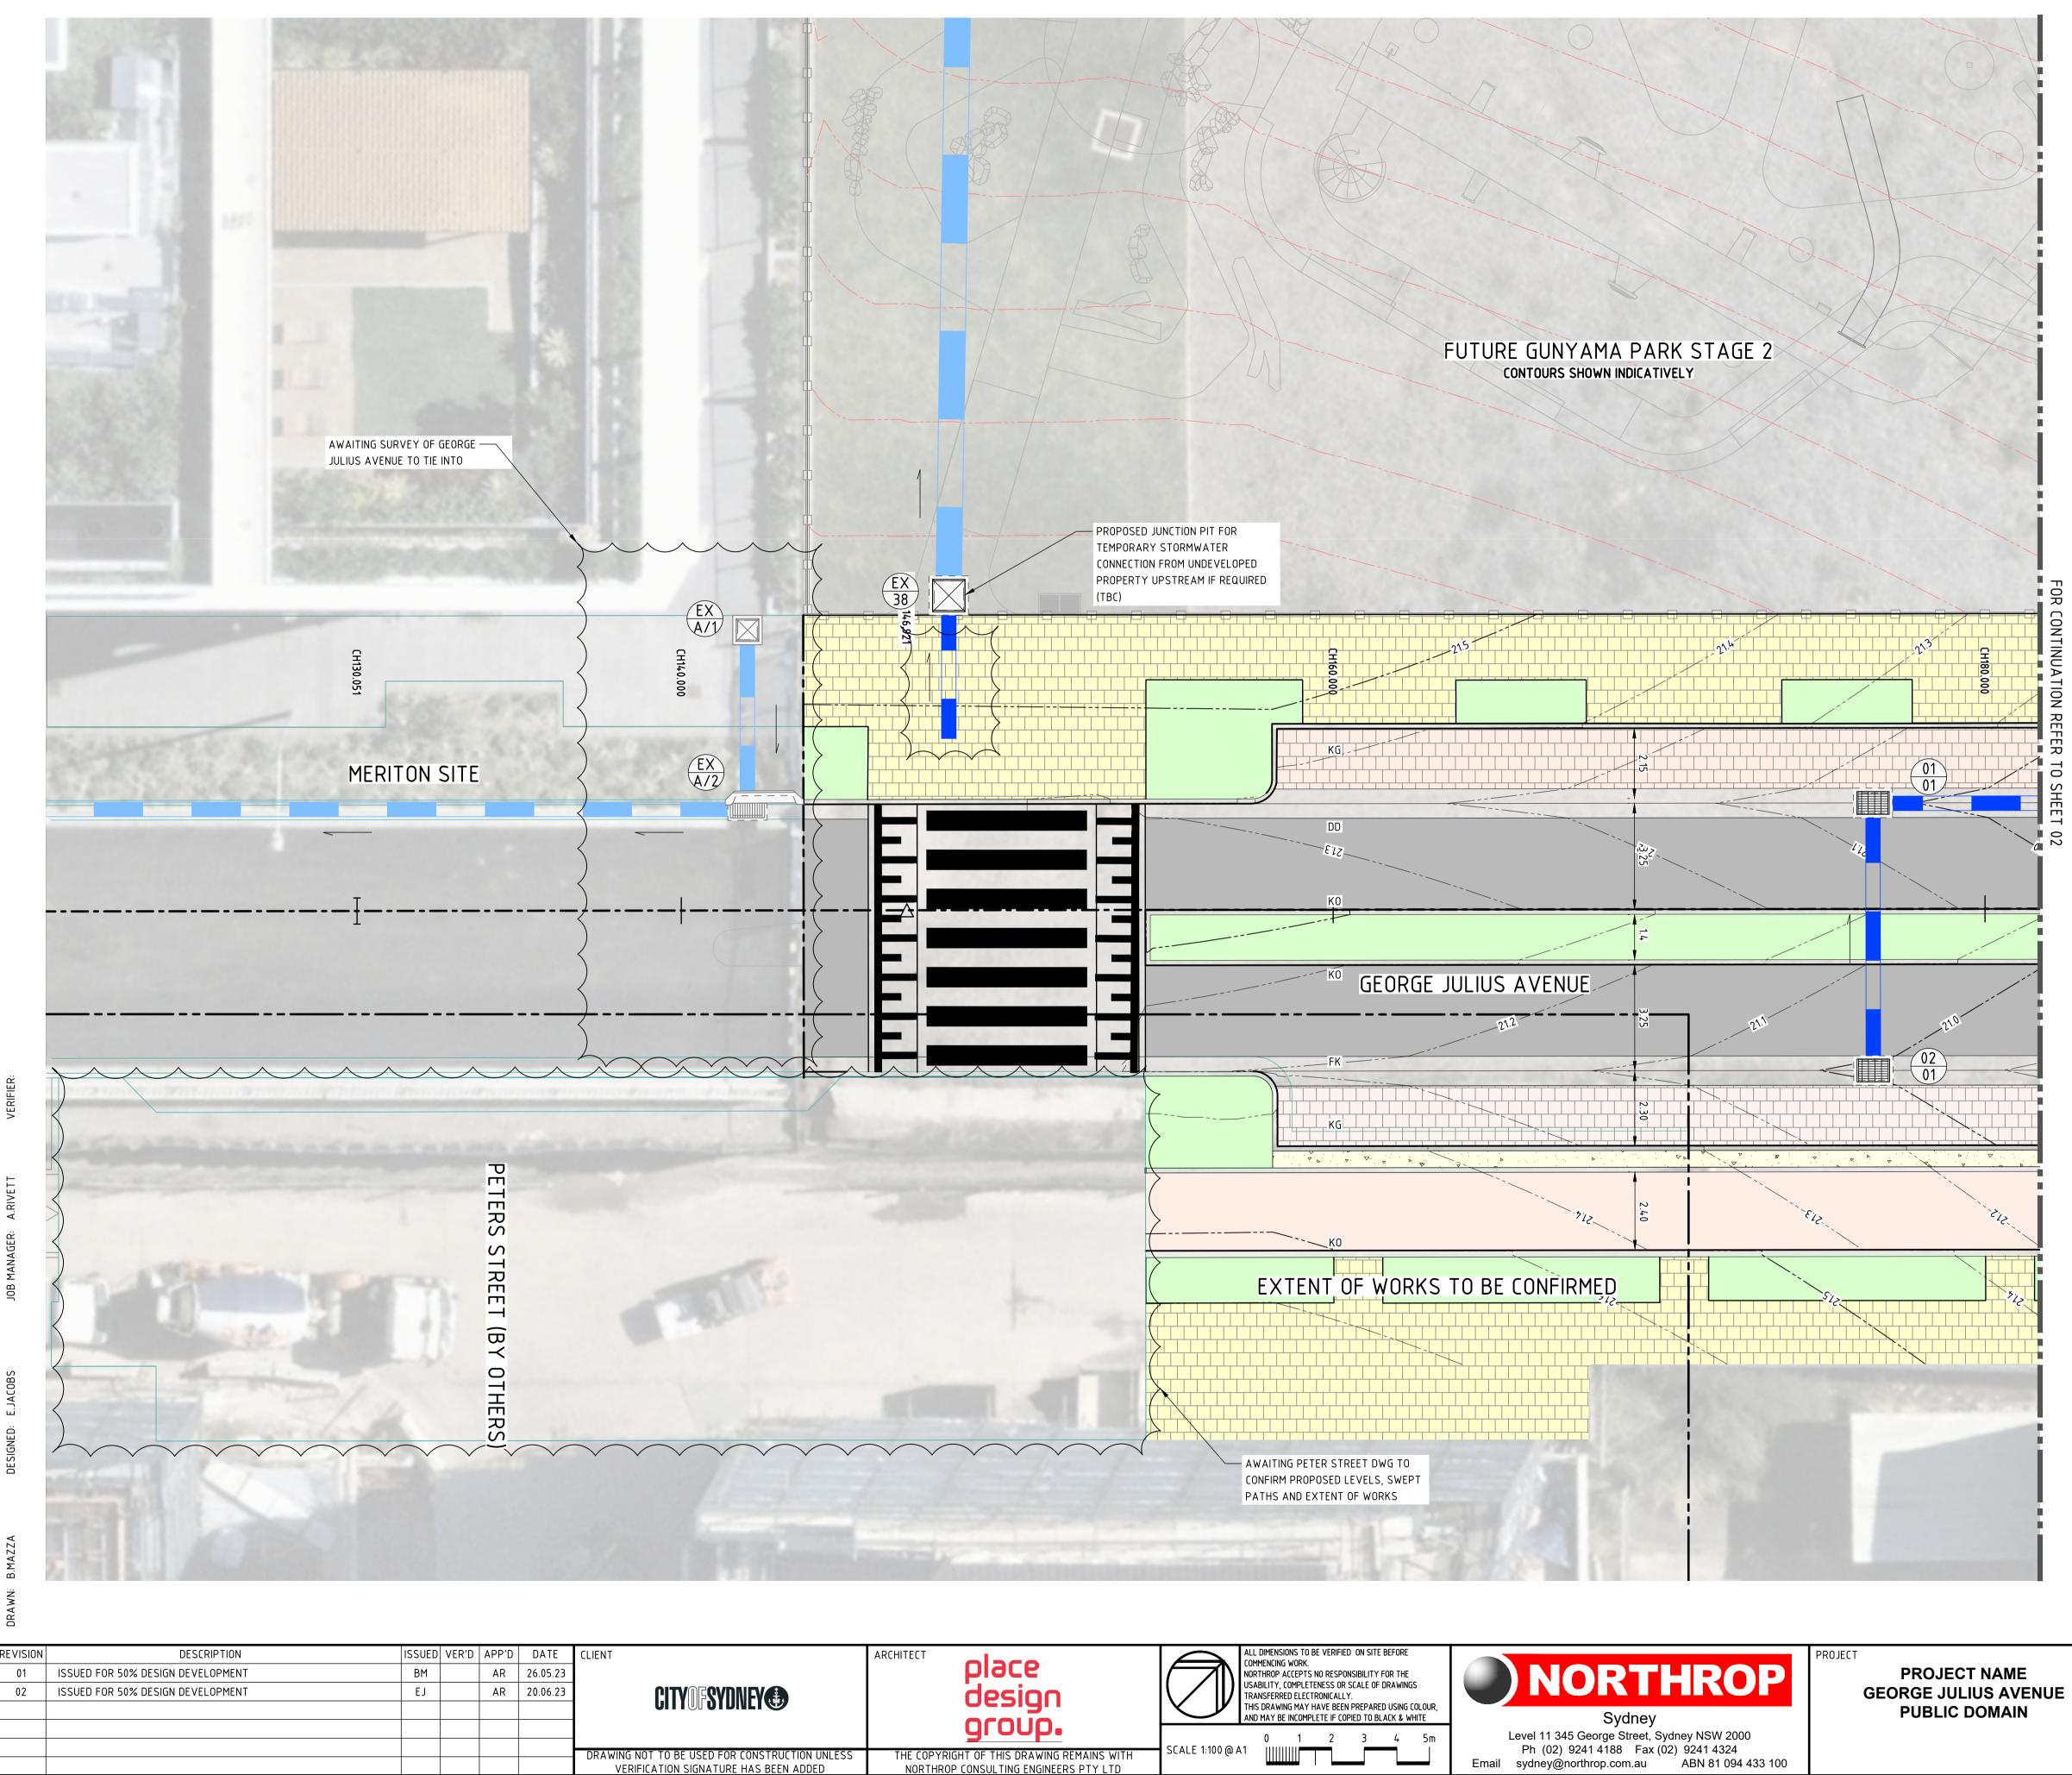
C101.11 01 DRAWING SHEET SIZE = A1

223309


REVISION

JOB NUMBER

DRAWING NUMBER



PUBLIC DOMAIN

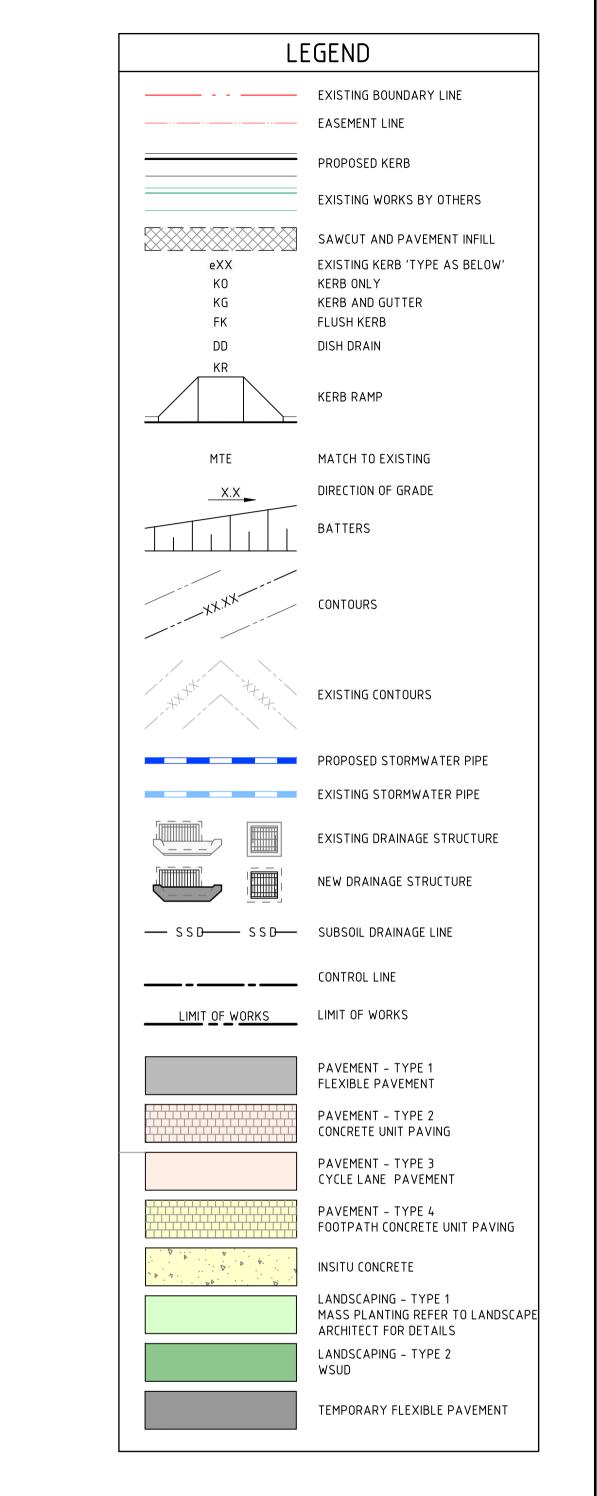

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REVISION

02


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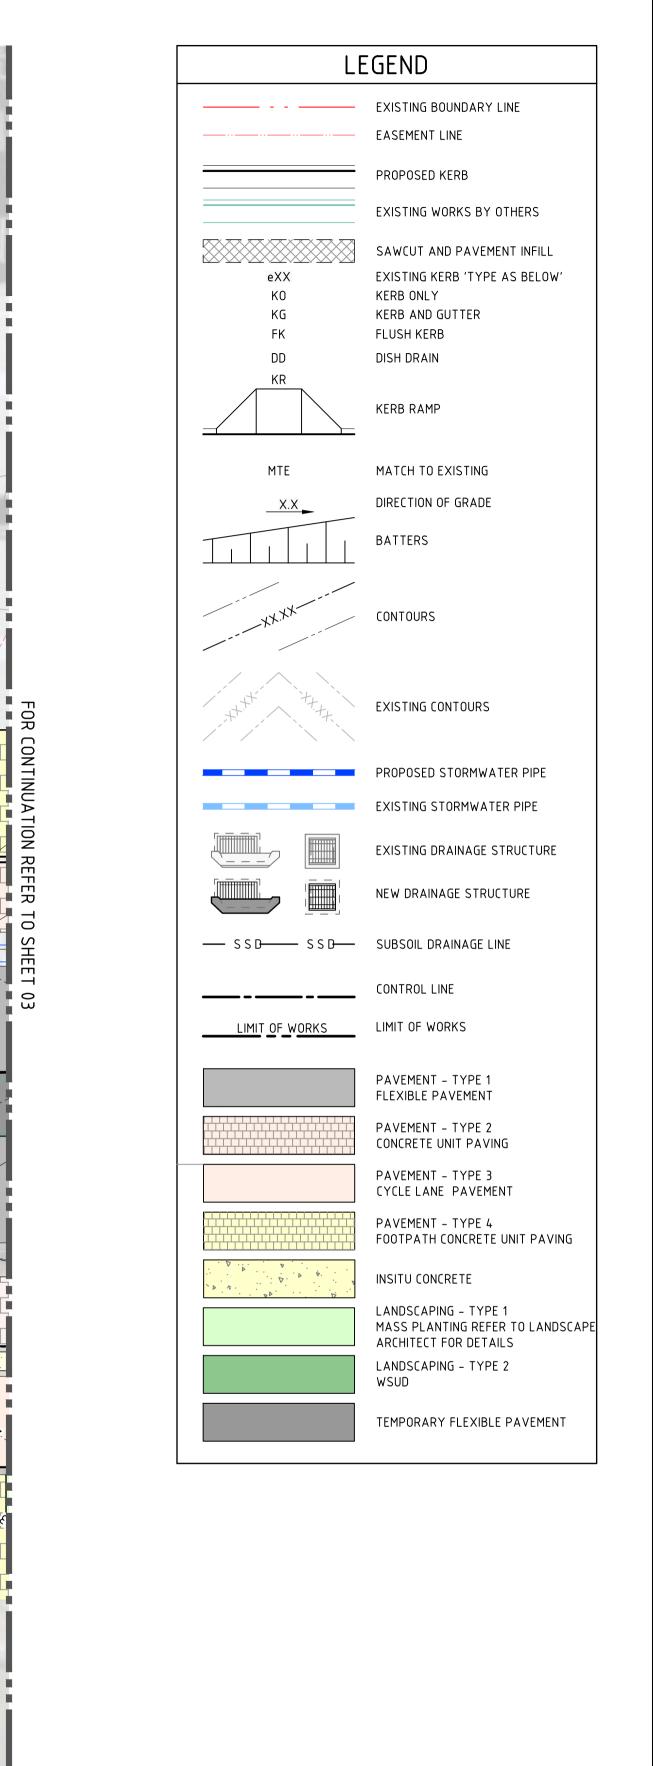
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PROJECT NAME GEORGE JULIUS AVENUE PUBLIC DOMAIN





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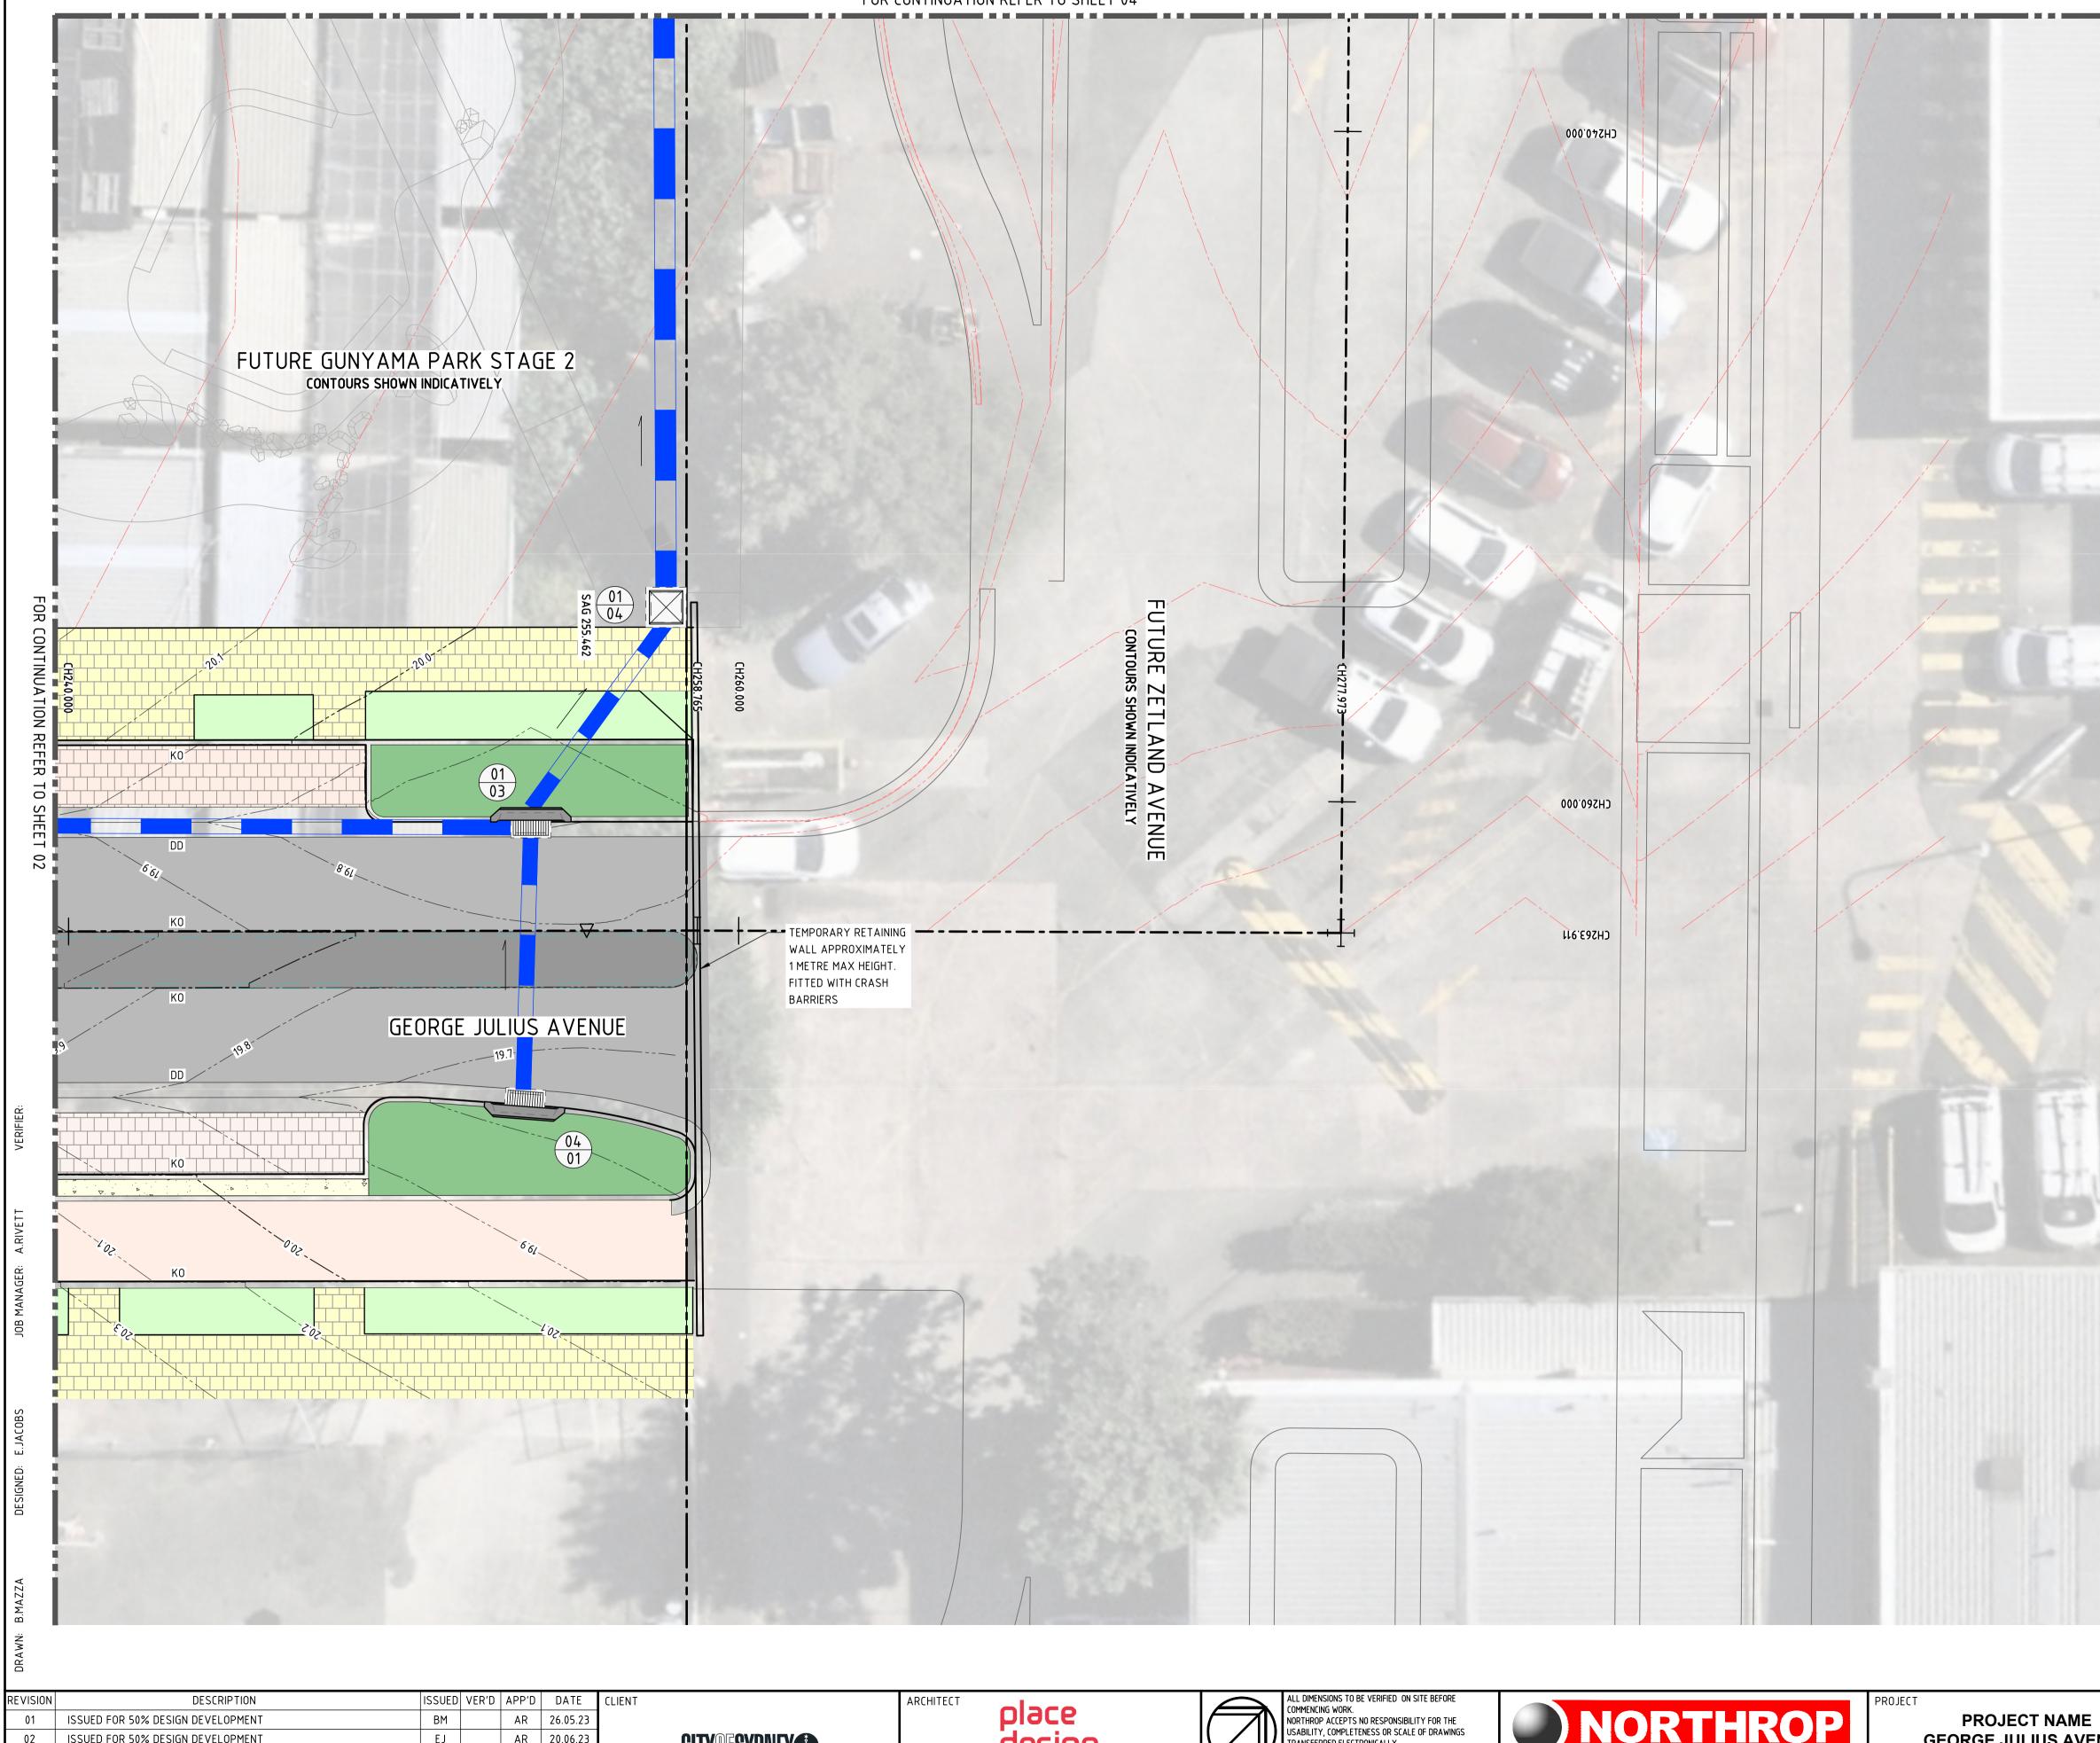
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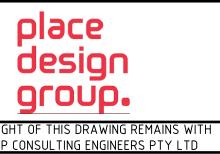
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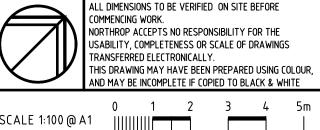
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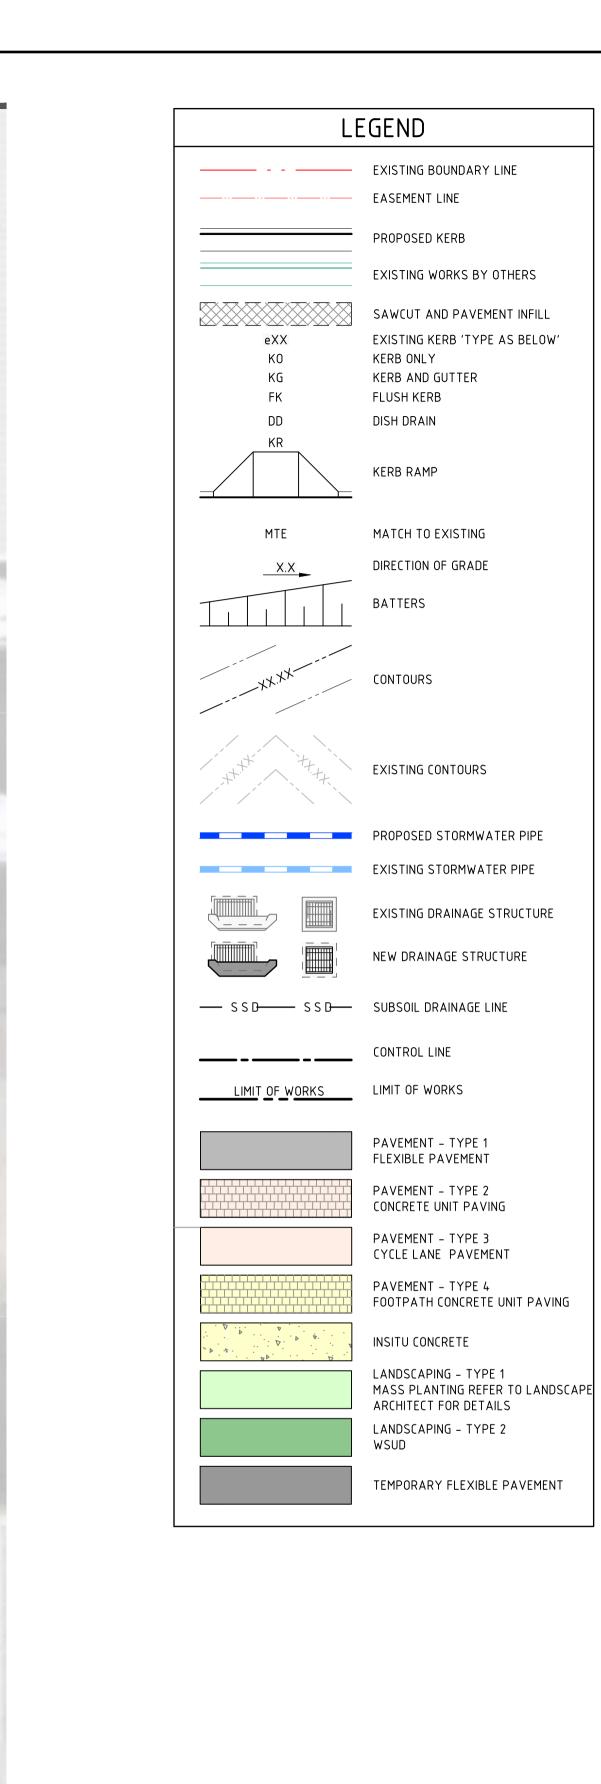




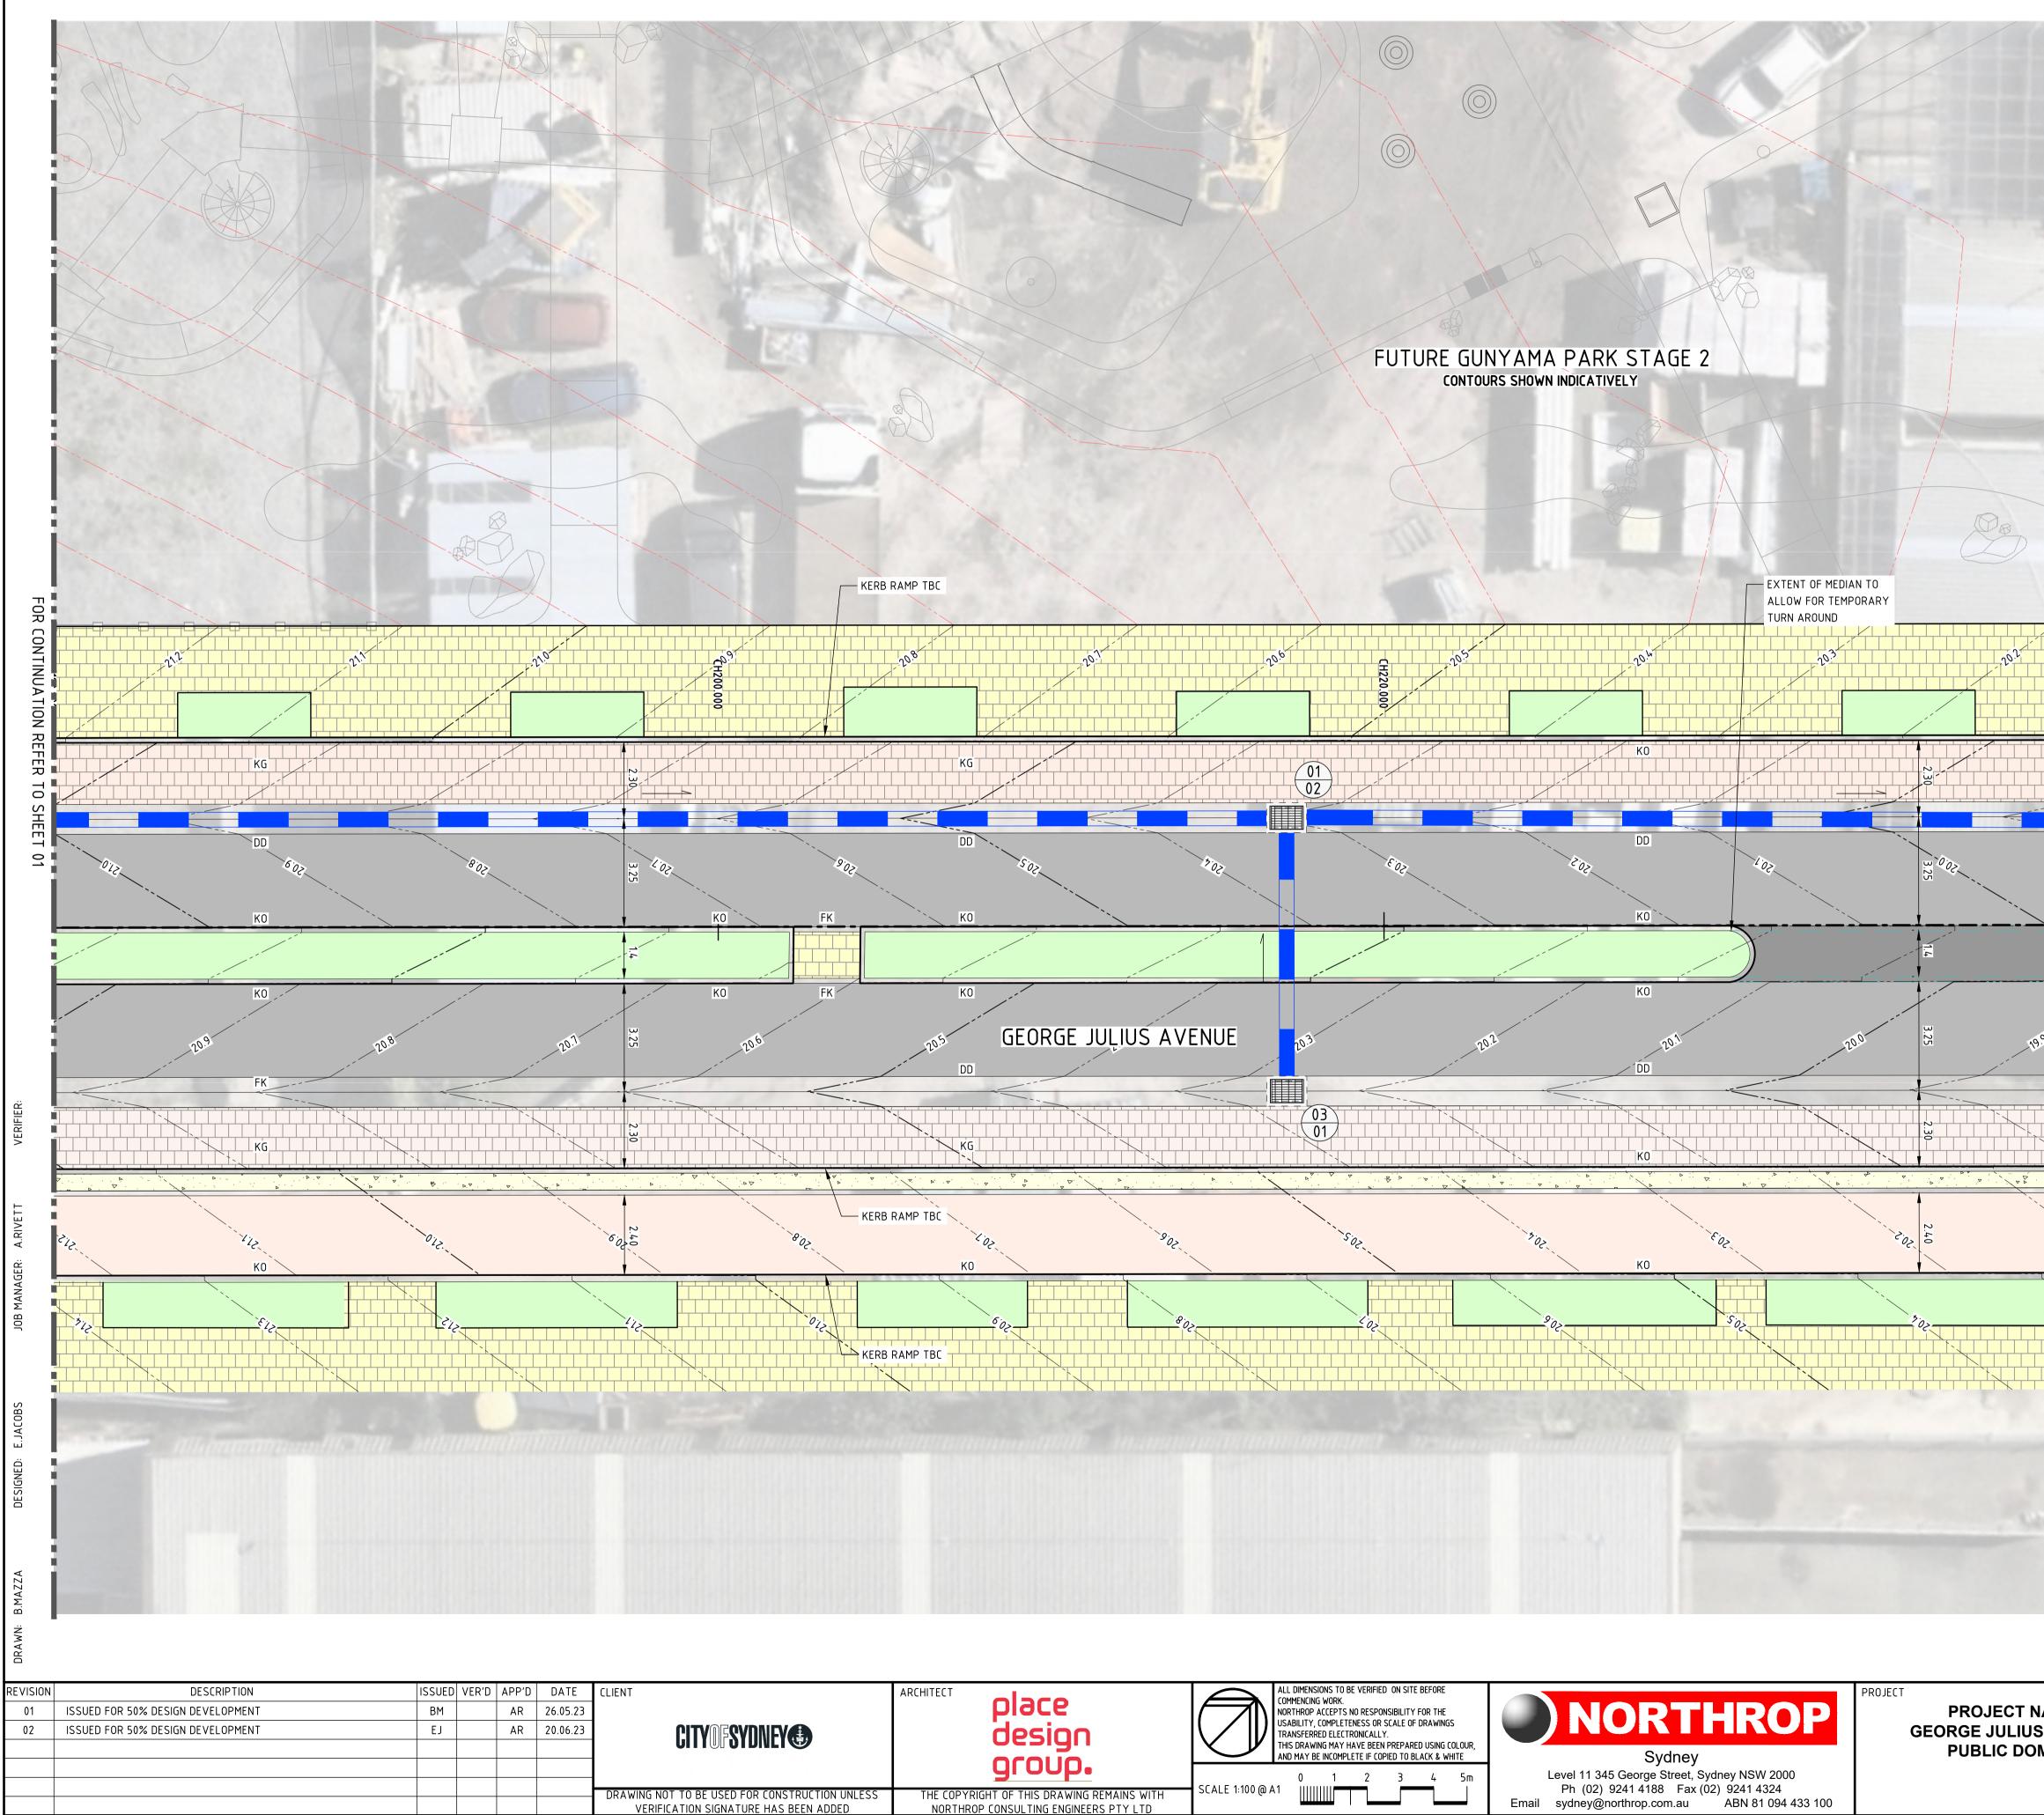



GEORGE JULIUS AVENUE PUBLIC DOMAIN





223309

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REVISION

02

JOB NUMBER

DRAWING NUMBER

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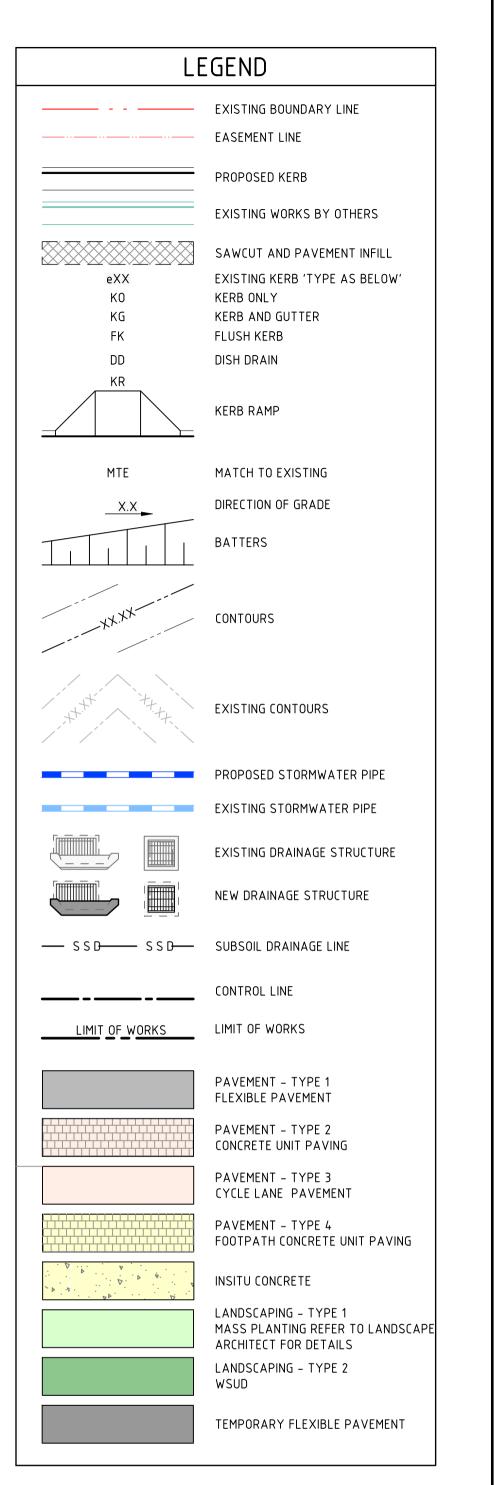
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						DRAWING NOT TO BE USED FOR CONSTRUCTION UNLESS	
						VERIFICATION SIGNATURE HAS BEEN ADDED	NORTHROP COL







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REVISION

01


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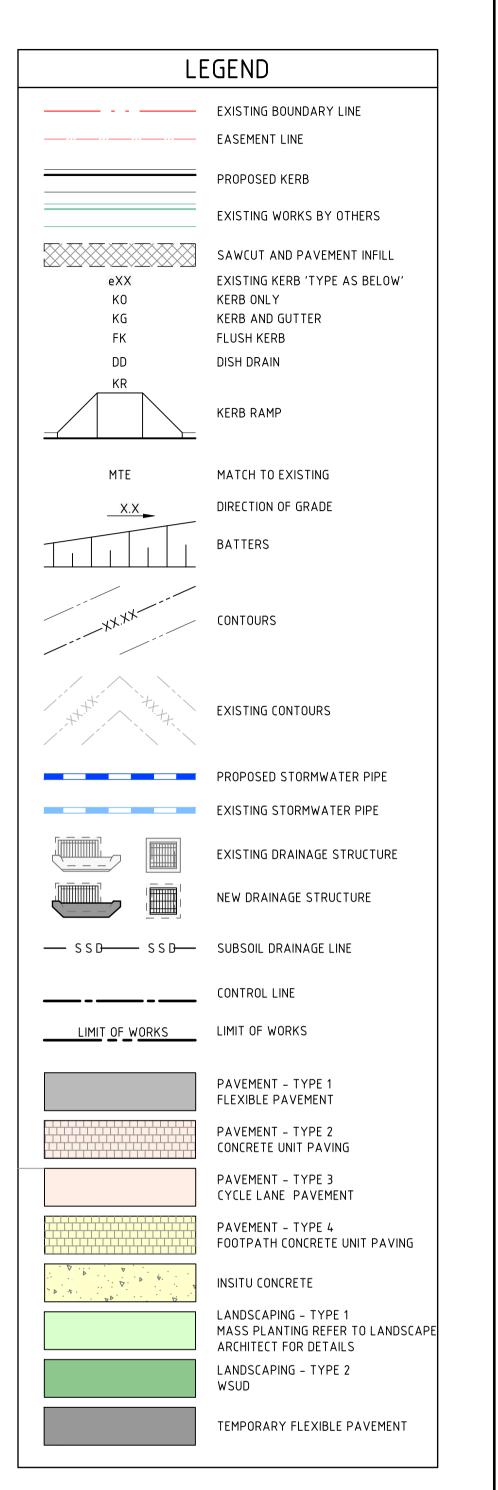
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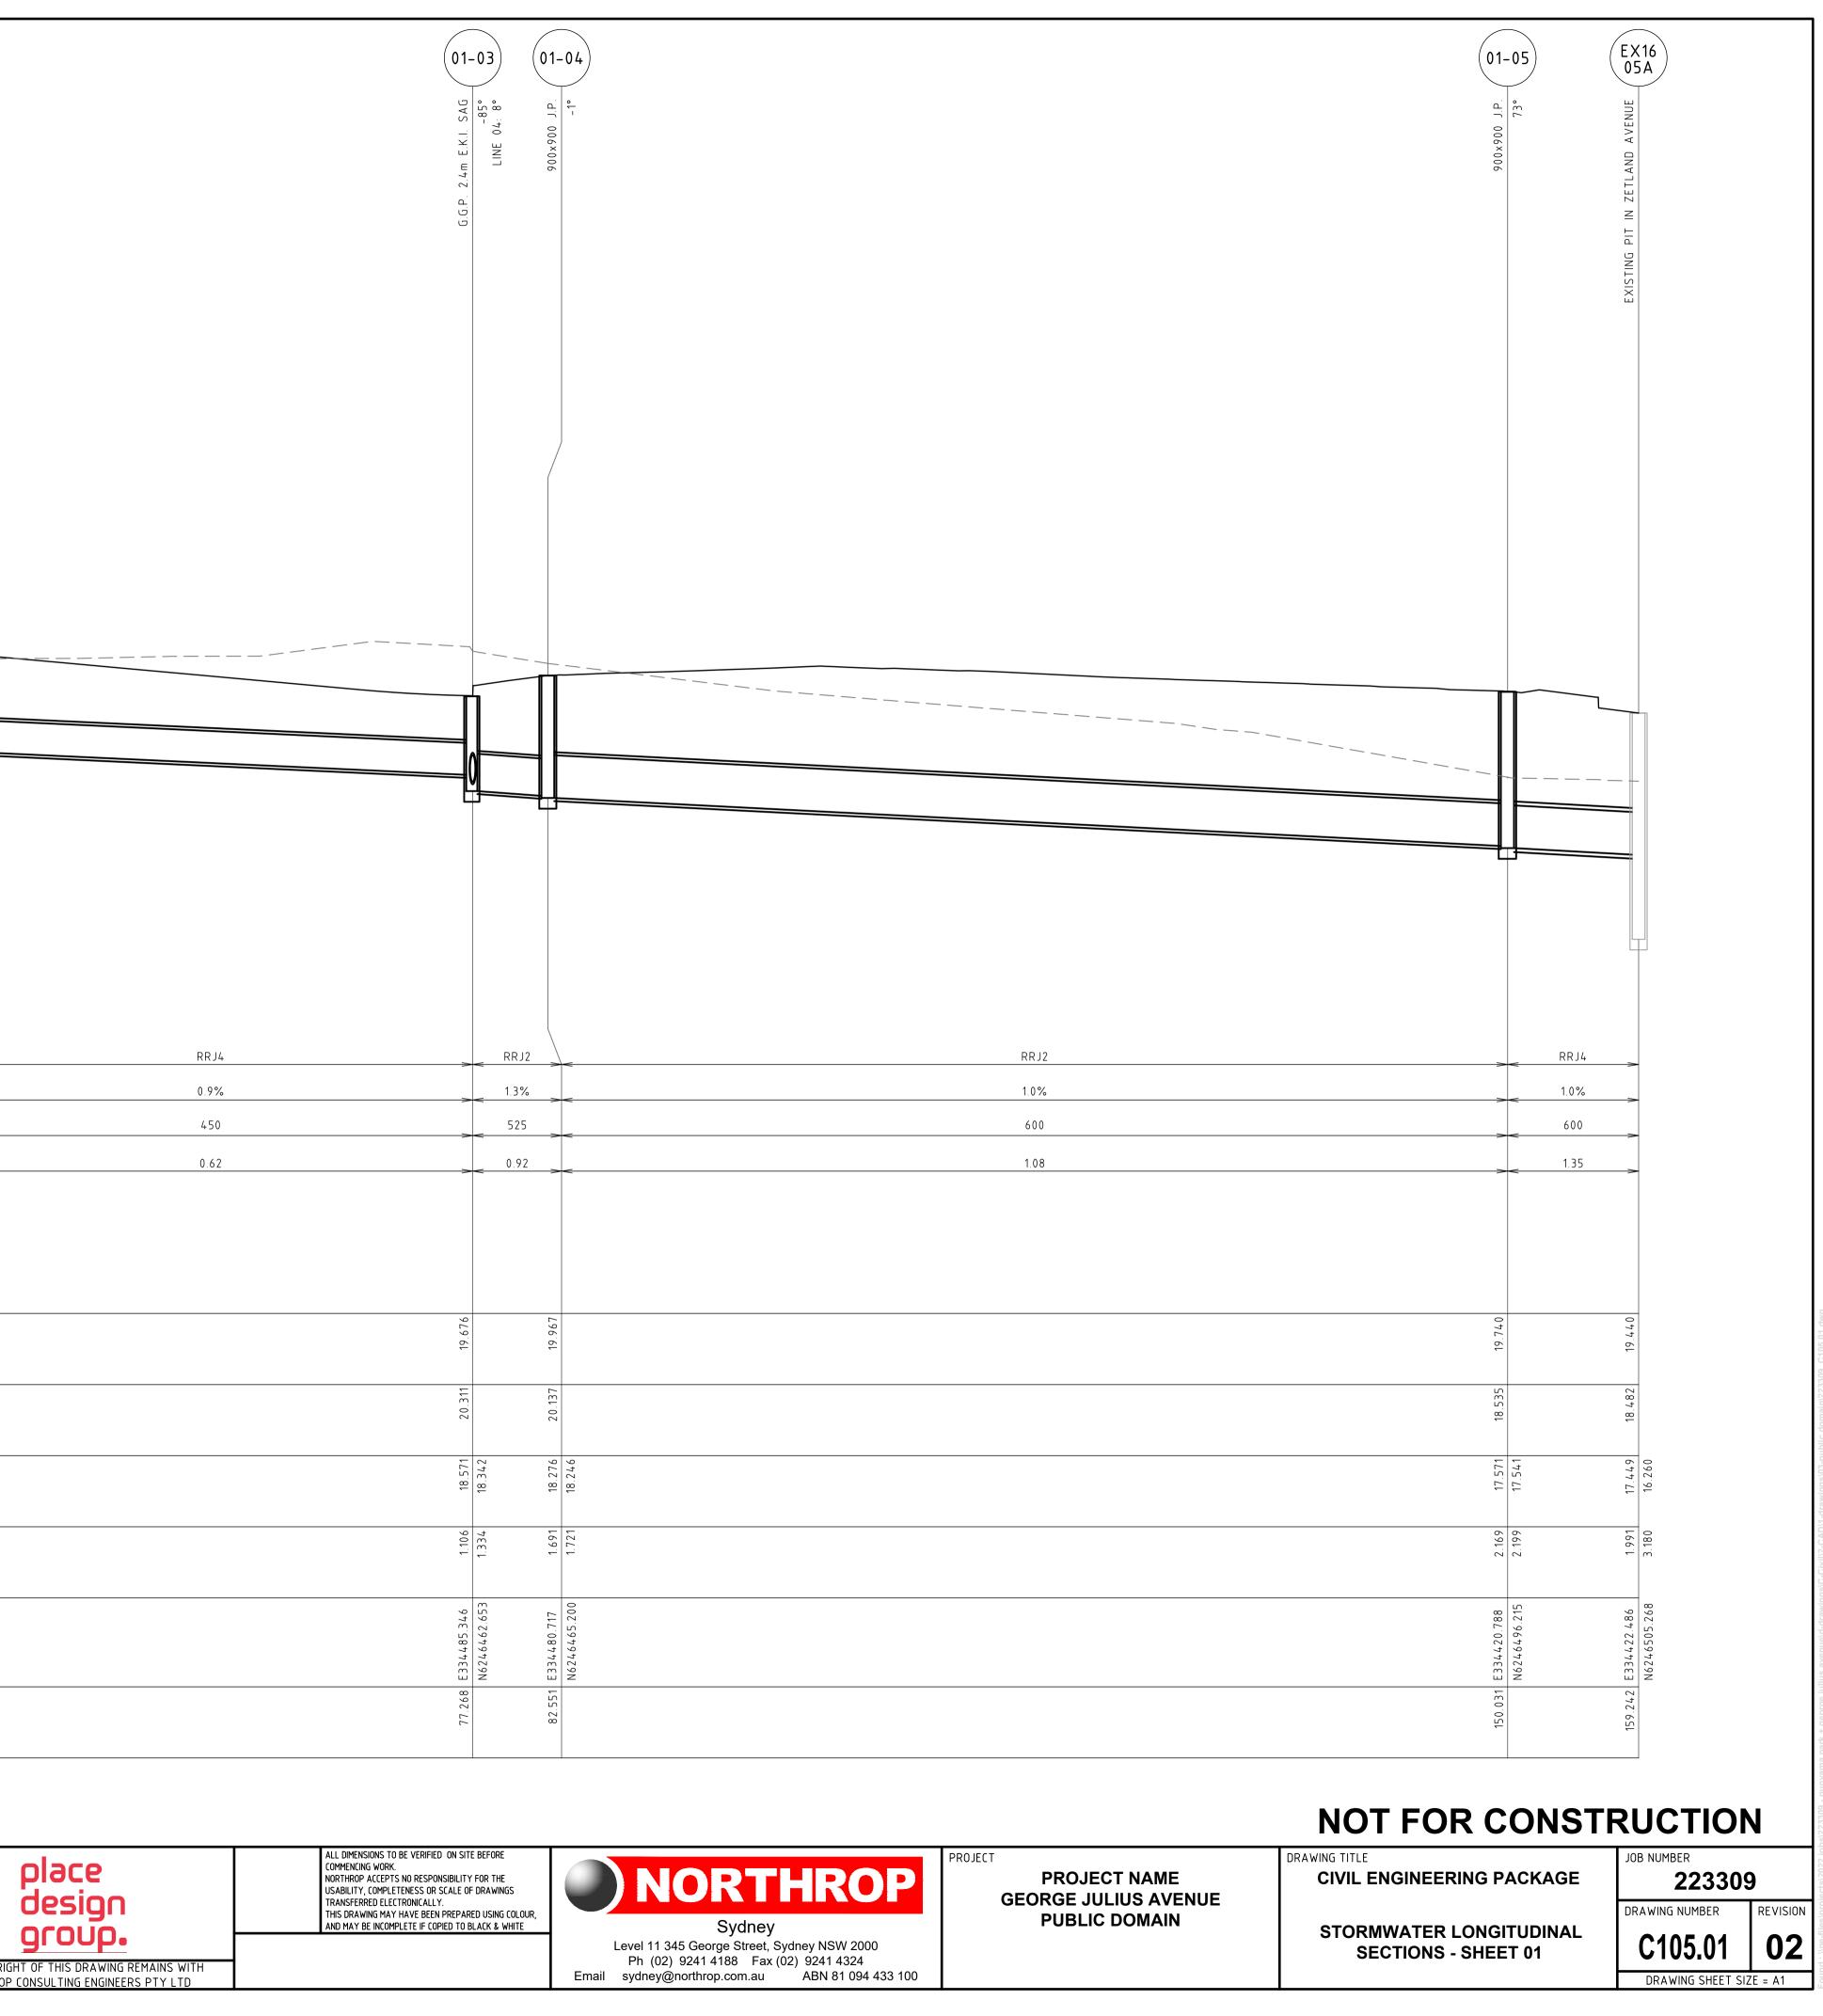
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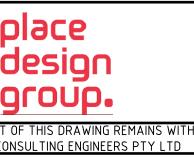
C104.05

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DRAWING TITLE CIVIL ENGINEERING PACKAGE

		01-01 MEIDLOK 900400 DG660 MEIDLOK 900400 MEIDLOK 9004000 MEIDLOK 90040000000000000000000000000000000000	01-02 NELDLOK 900×600 DCG96D
VERIFIER:	PIPE CLASS PIPE GRADE (%) PIPE SIZE (mm) MINIMUM COVER (m)	RRJ4 1.0% 375 0.67	
	DATUM RL	51-02 <i>t</i>	20.292
ier: A.rivett	FINISHED SURFACE	18.135	20.192 20.
JOB MANAGER:	NATURAL SURFACE	19.636	19.221 20 18.904
ω Δ	PIPE INVERT LEVEL	1.388	1.072 19 1.388 18.
ED: E.JACOBS	DEPTH TO INVERT		
DESIGNED:	CO-ORDINATED SETOUT	E334454.263 N6246391.913	E334470.523 N6246428.917
DRAWN: B.MAZZA			
REVISION 01 02	DESCRIPTION ISSUED FOR 50% DESIGN DEVELOPMENT ISSUED FOR 50% DESIGN DEVELOPMENT	ISSUED VER'D APP'D DATE CLIENT BM AR 26.05.23 Image: Comparison of the compa	ARCHITECT ESS THE COPYRIGH NORTHROP C





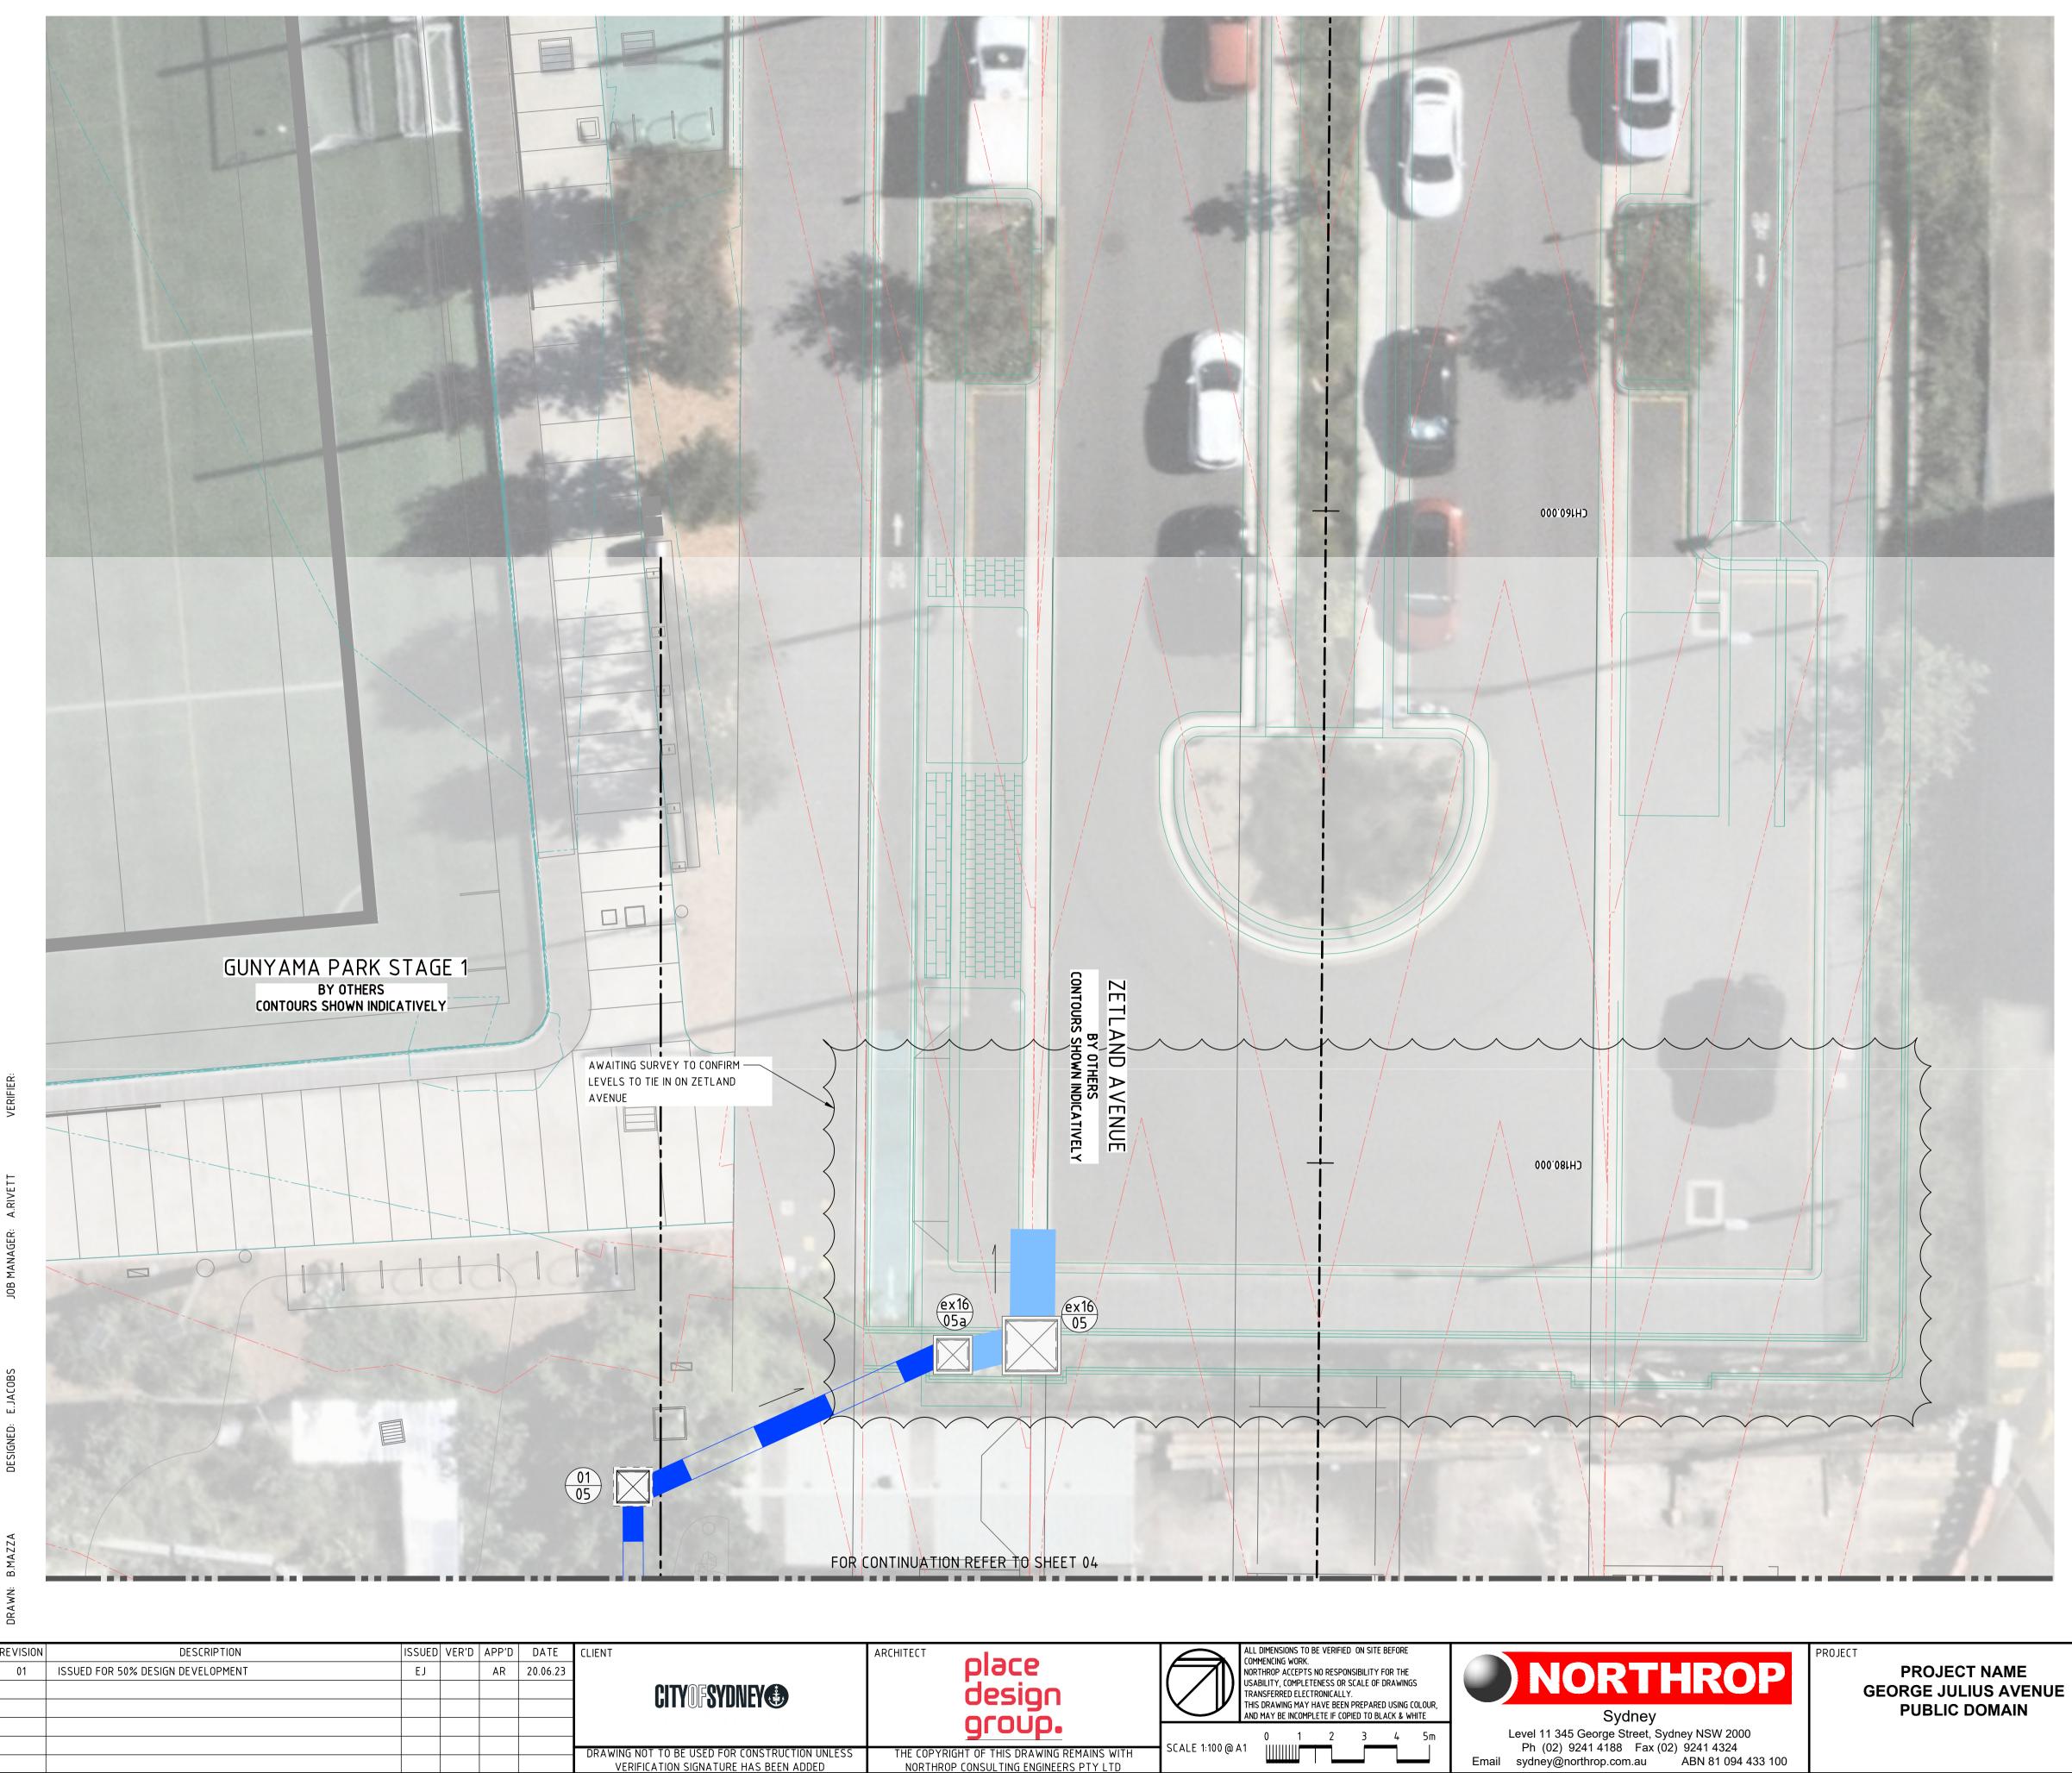

		02-01 MELDLOK 900x600 DCG96D	MELDLOK 900x600 DCG96D	03-01 MELDLOK 900x600 DCG96D	01-02 MELDLOK 900x600 DCG96D	04-01) 9'C' 5'f'' E'K'I SAG	01-03 LINE 01
IER:	PIPE CLASS PIPE GRADE (%) PIPE SIZE (mm) MINIMUM COVER (m)	< <u>3.</u>	2 J4 > 1% > 75 > 67 >	<u> </u>	<u>8 J4</u> 1% 75 67	< RR < 2.0 < 37 < 0.1	0% 75
JOB MANAGER: A.RIVETT VERIFIER:	DATUM RL FINISHED SURFACE NATURAL SURFACE PIPE INVERT LEVEL	18.175 20.971 19.922 13.175	19.636 18.135 21.024	19.190 20.074 20.241 0	18.934 20.192 20.292 18.904	19.64.2 19.623 18.64.2 19.623	18.472 20.311 19.676 18.342
DESIGNED: E.JACOBS	DEPTH TO INVERT	E334461.806 N6246388.696 1.049	E334454.263 1.358 1.388 1.388	E334478.037 N6246425.634 1.051	E334470.523 1.358 N6246428.917 1.388	E334493.268 N6246459.609 0.981	E334485.346 1.204 N6246462.653 1.334
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PROJECT **PROJECT NAME** GEORGE JULIUS AVENUE PUBLIC DOMAIN

NOT FOR CONSTRUCTION

DRAWING TITLE CIVIL ENGINEERING PACKAGE

STORMWATER LONGITUDINAL **SECTIONS - SHEET 02**

223309 REVISION DRAWING NUMBER C105.02 02 DRAWING SHEET SIZE = A1

JOB NUMBER

DRAWN: B.MAZZA							
REVISION	DESCRIPTION	ISSUED	VER'D	APP'D	DATE	CLIENT	ARCHITECT
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						DRAWING NOT TO BE USED FOR CONSTRUCTION UNLESS VERIFICATION SIGNATURE HAS BEEN ADDED	THE COPYRIGH NORTHROP C

	·	2.5%	KO	35	%			-3% K	0 <u>-3%</u> KO	-3%			3%	КО		2.5%	KO		2.5%	
FINISHED SURFACE	0.205		0.120		-0.085	-0.125	-0.080	0.000			-0.135	-0.135	-0.080	0.070	0.070	L	C +1 . V	0 295		0.380
OFFSET	-9.050		-5.575	-5.550	-3.700	-3.250	-2.800	0.00			4.500	5.400	7 250	7.275	7.400		DC + 01	c / + 01 10 600		13.950



TYPICAL SECTION GEORGE JULIUS AVENUE

NOT FOR CONSTRUCTION DRAWING TITLE


CIVIL ENGINEERING PACKAGE

TYPICAL SECTIONS - SHEET 01


JOB NUMBER 223309 REVISION DRAWING NUMBER C106.15 02 DRAWING SHEET SIZE = A1

	÷				VIP R.L. 21.043		-				VIP R.L. 20.298		∕_c CH 46.817m							
DESIGN GRADELINE		1.6%	2.8%	<u>2</u> .8	8%				-2.979%											
VERTICAL GEOMETRY Horizontal geometry	-		Nr V			< V.(-			40.0	<u>00</u> m	< 1 V	.C.		36	⊃ .68m F	- - -			
FINISHED SURFACE	21.351	21.292	21.189	21.183	21.117	21.041	20.894	20.877	20.604		20.502	20.483	20.46	20.463	20.465	20.52	20 546	20.558	20.656	
EXISTING SURFACE												-								
CHAINAGE	0.000	3.801	7.465	7.655	10.000	12.655	<u>حده. ۱۲</u>	20 000	000°08		37.667	40.000	4.6.817	49.513	50.000	57.667	60.000	61.116	70.000	

EXISTING WORKS

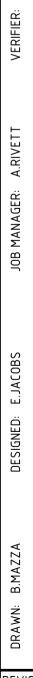

REVISION	DESCRIPTION	ISSUED	VER'D	APP'D	DATE	CLIENT	ARCHITECT
01	ISSUED FOR 50% DESIGN DEVELOPMENT	BM		AR	26.05.23		
02	ISSUED FOR 50% DESIGN DEVELOPMENT	EJ		AR	20.06.23	CITYOFSYDNEY	
						DRAWING NOT TO BE USED FOR CONSTRUCTION UNLESS	THE COPYRIGHT
						VERIFICATION SIGNATURE HAS BEEN ADDED	NORTHROP CO

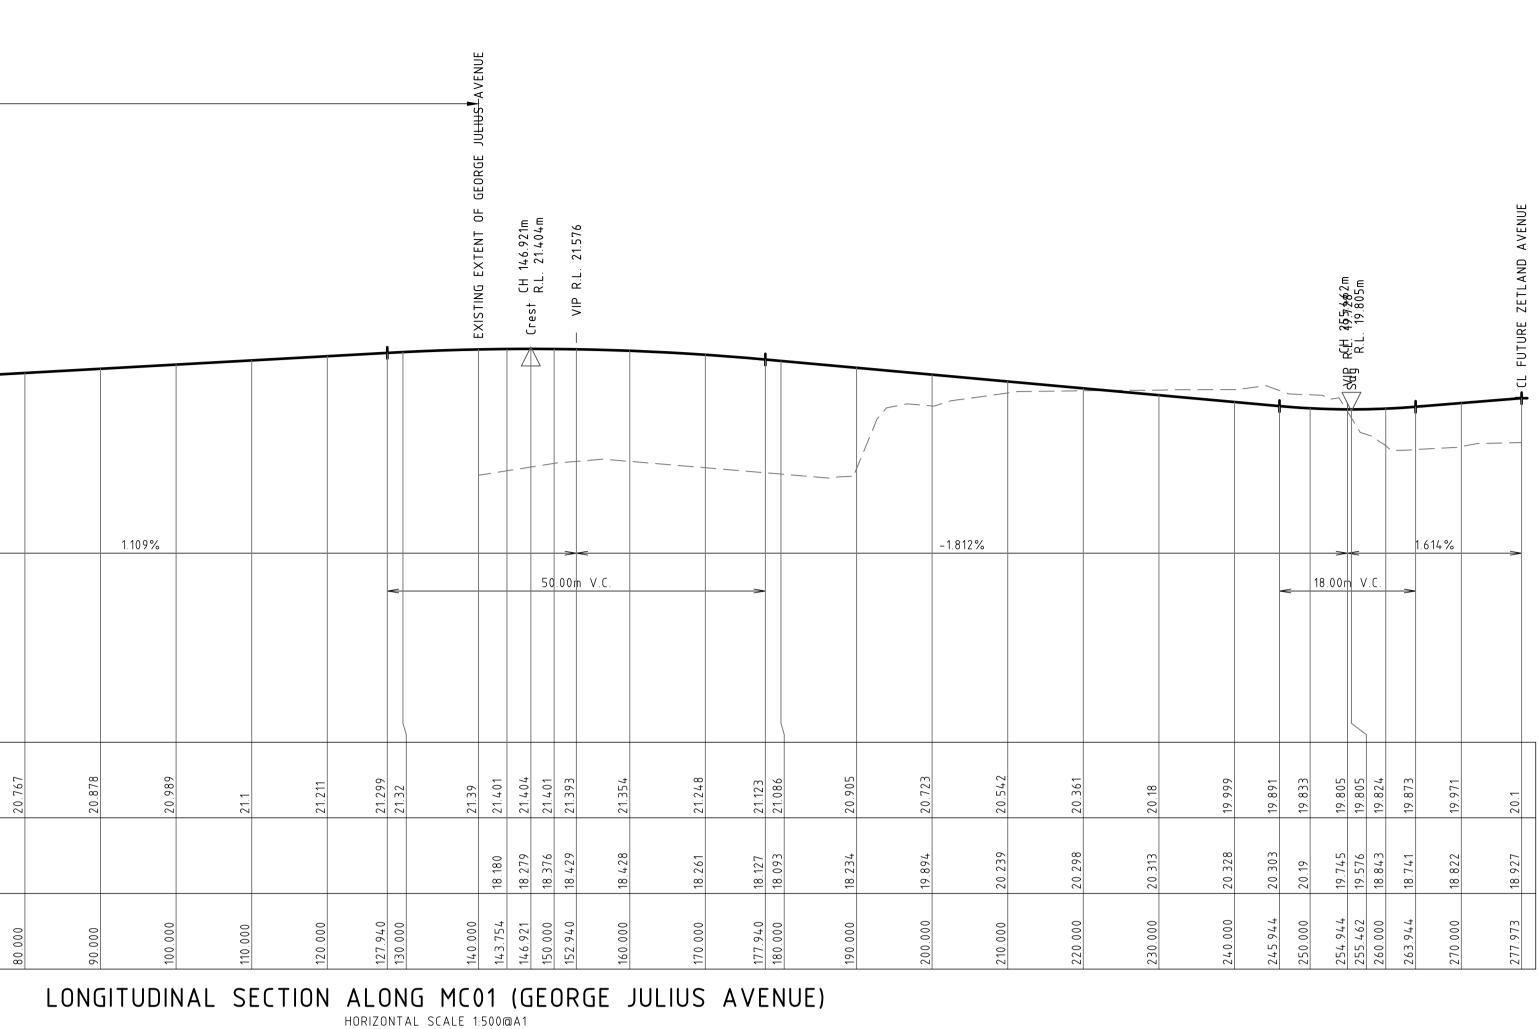

VERTICAL SCALE 1:100@A1

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PROJECT **PROJECT NAME** GEORGE JULIUS AVENUE PUBLIC DOMAIN

NOT FOR CONSTRUCTION


DRAWING TITLE CIVIL ENGINEERING PACKAGE

ROAD LONGITUDINAL SECTIONS -SHEET 01

JOB NUMBER 223309 DRAWING NUMBER REVISION C106.21 02 DRAWING SHEET SIZE = A1

GEORGE JULIUS AVENUE - ROAD PACKAGE GUNYAMA PARK - STAGE 2

50% DESIGN DEVELOPMENT

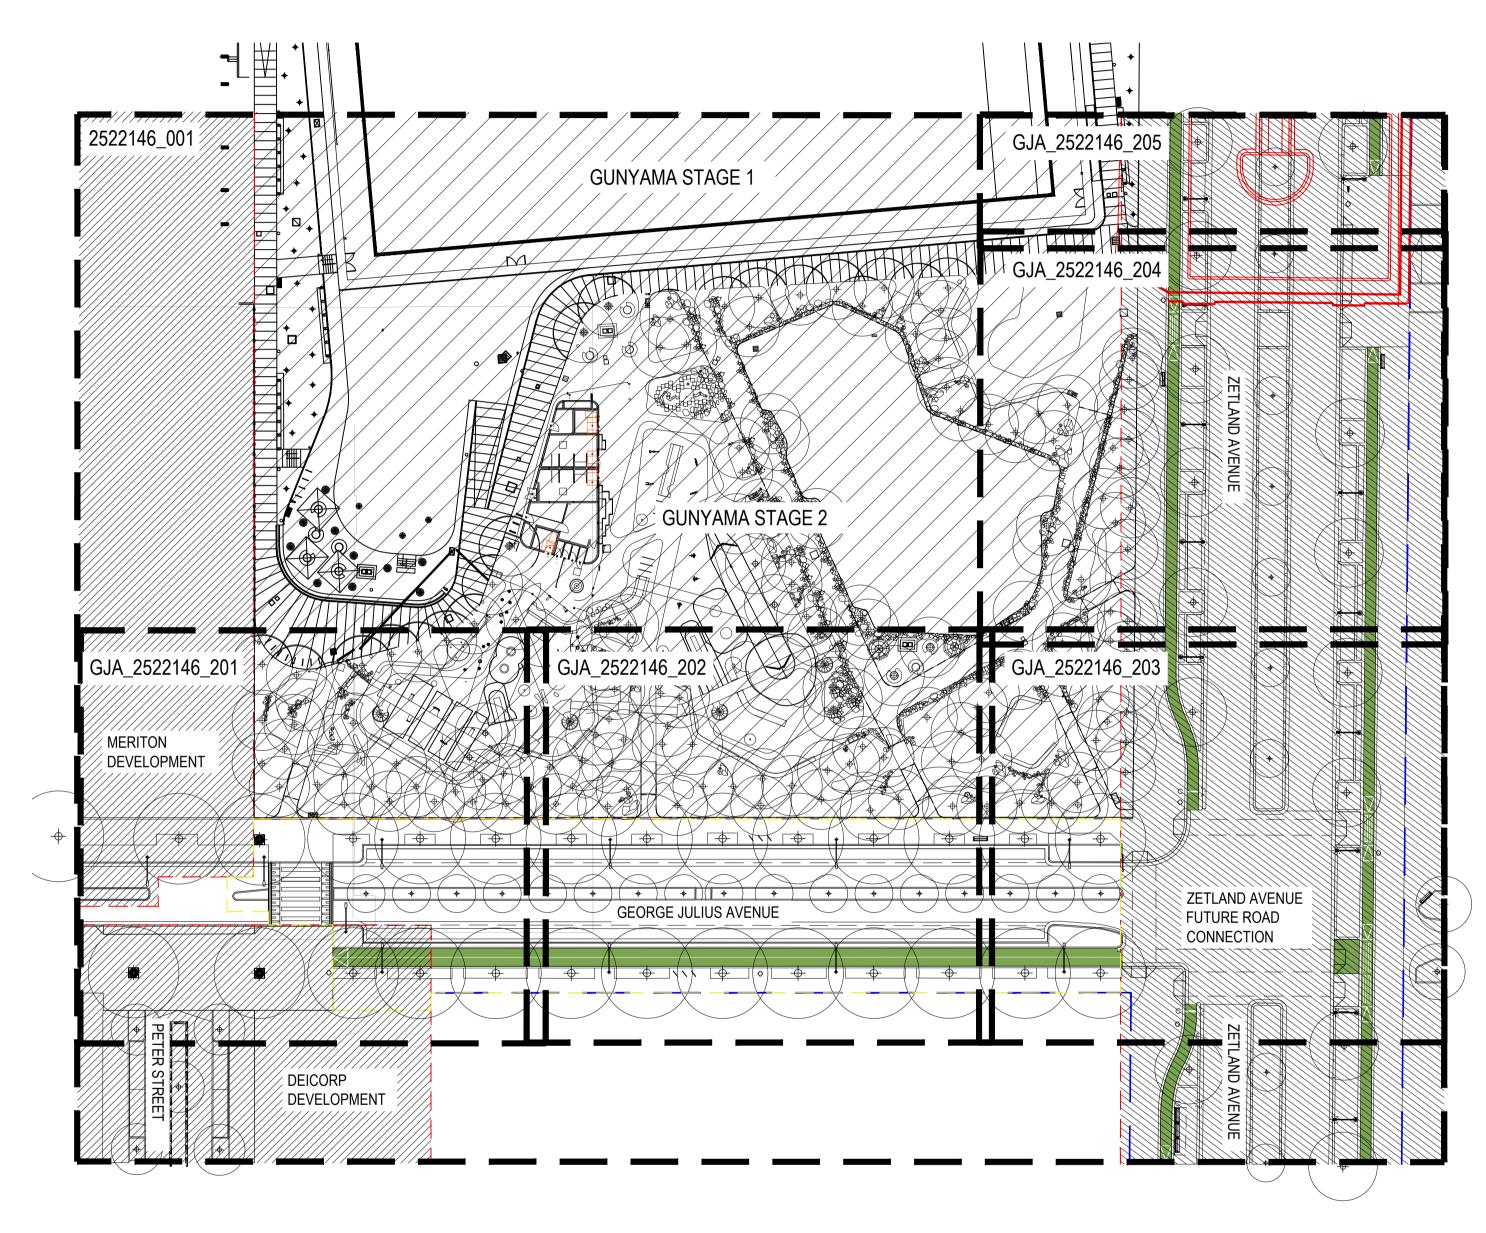

SCHEDULE OF DRAWINGS

COVER SHEET
SITE PLAN
SITE PLAN - CARBON STREET
SITE PLAN - BOUNDARY
SITE PREPARATION PLAN
SITE PREPARATION PLAN
SITE PREPARATION PLAN
MATERIALS SCHEDULE
GENERAL ARRANGEMENT PLAN
GENERAL ARRANGEMENT PLAN
GENERAL ARRANGEMENT PLAN
GENERAL ARRANGEMENT PLAN - CONCEPT ONLY
GENERAL ARRANGEMENT PLAN - CONCEPT ONLY
GENERAL ARRANGEMENT PLAN - INTERIM 1
GENERAL ARRANGEMENT PLAN - INTERIM 2
GENERAL ARRANGEMENT PLAN - INTERIM 3
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PLANTING SCHEDULE PLANTING PLAN PLANTING PLAN PLANTING PLAN PLANTING PLAN - CONCEPT ONLY PLANTING PLAN - CONCEPT ONLY

SECTIONS

SECTIONS

SECTIONS

DETAILS LIST

NO.

GJA_2522146-000
GJA_2522146-001
GJA_2522146-002
GJA_2522146-003
GJA_2522146-101
GJA_2522146-102
GJA_2522146-103
GJA_2522146-200
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PROJECT

GUNYAMA PARK STAGE 2

CLIENT

CITY OF SYDNEY

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ISSUE	CODE	ISSUE DESCRIPTION	BY	СНК	DATE
01	PRE	50% DESIGN DEVELOPMENT	RH	LI	21.06.2023
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PRE - P	relimina	ry CA - Council Approval T - T	ender	' I CON	N - Construction

DRAWING TITLE


COVER SHEET

DESIGN : BP DOCUMENT : RH PROJECT : 2522146




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DRAWING NUMBER	REVIS
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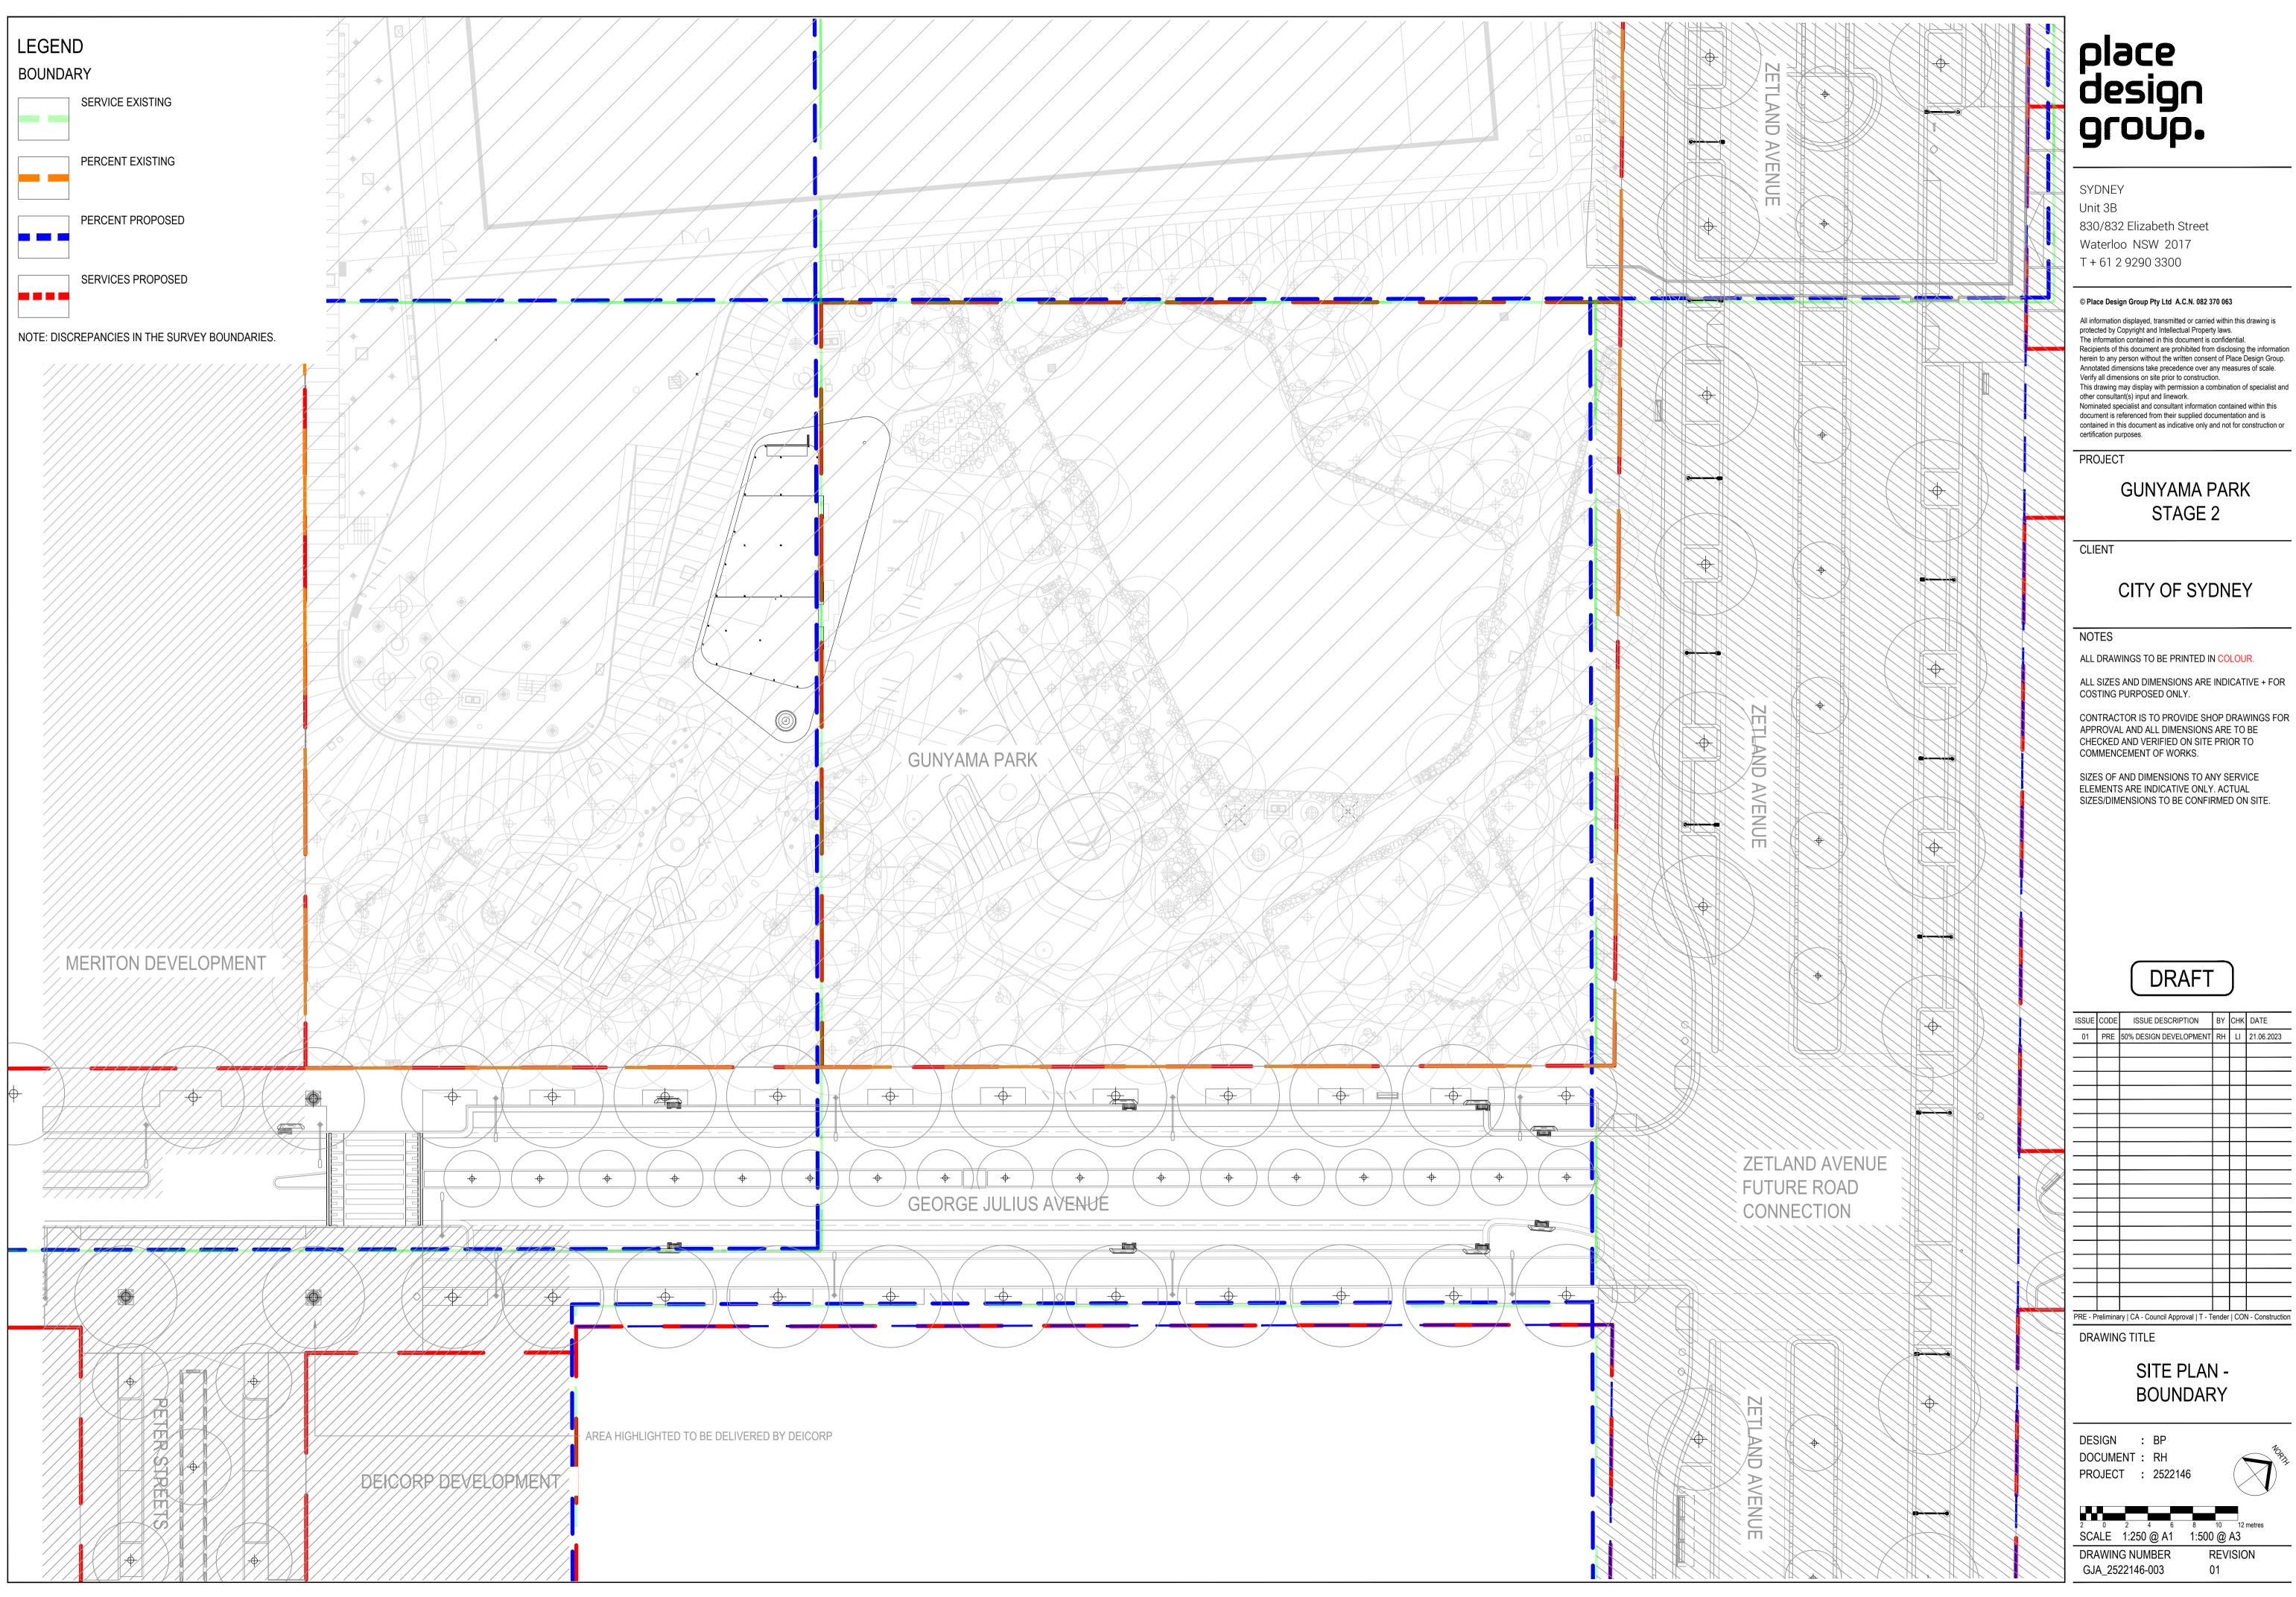


ISSUE	CODE	ISSUE DESCRIPTION	BY	СНК	DATE	
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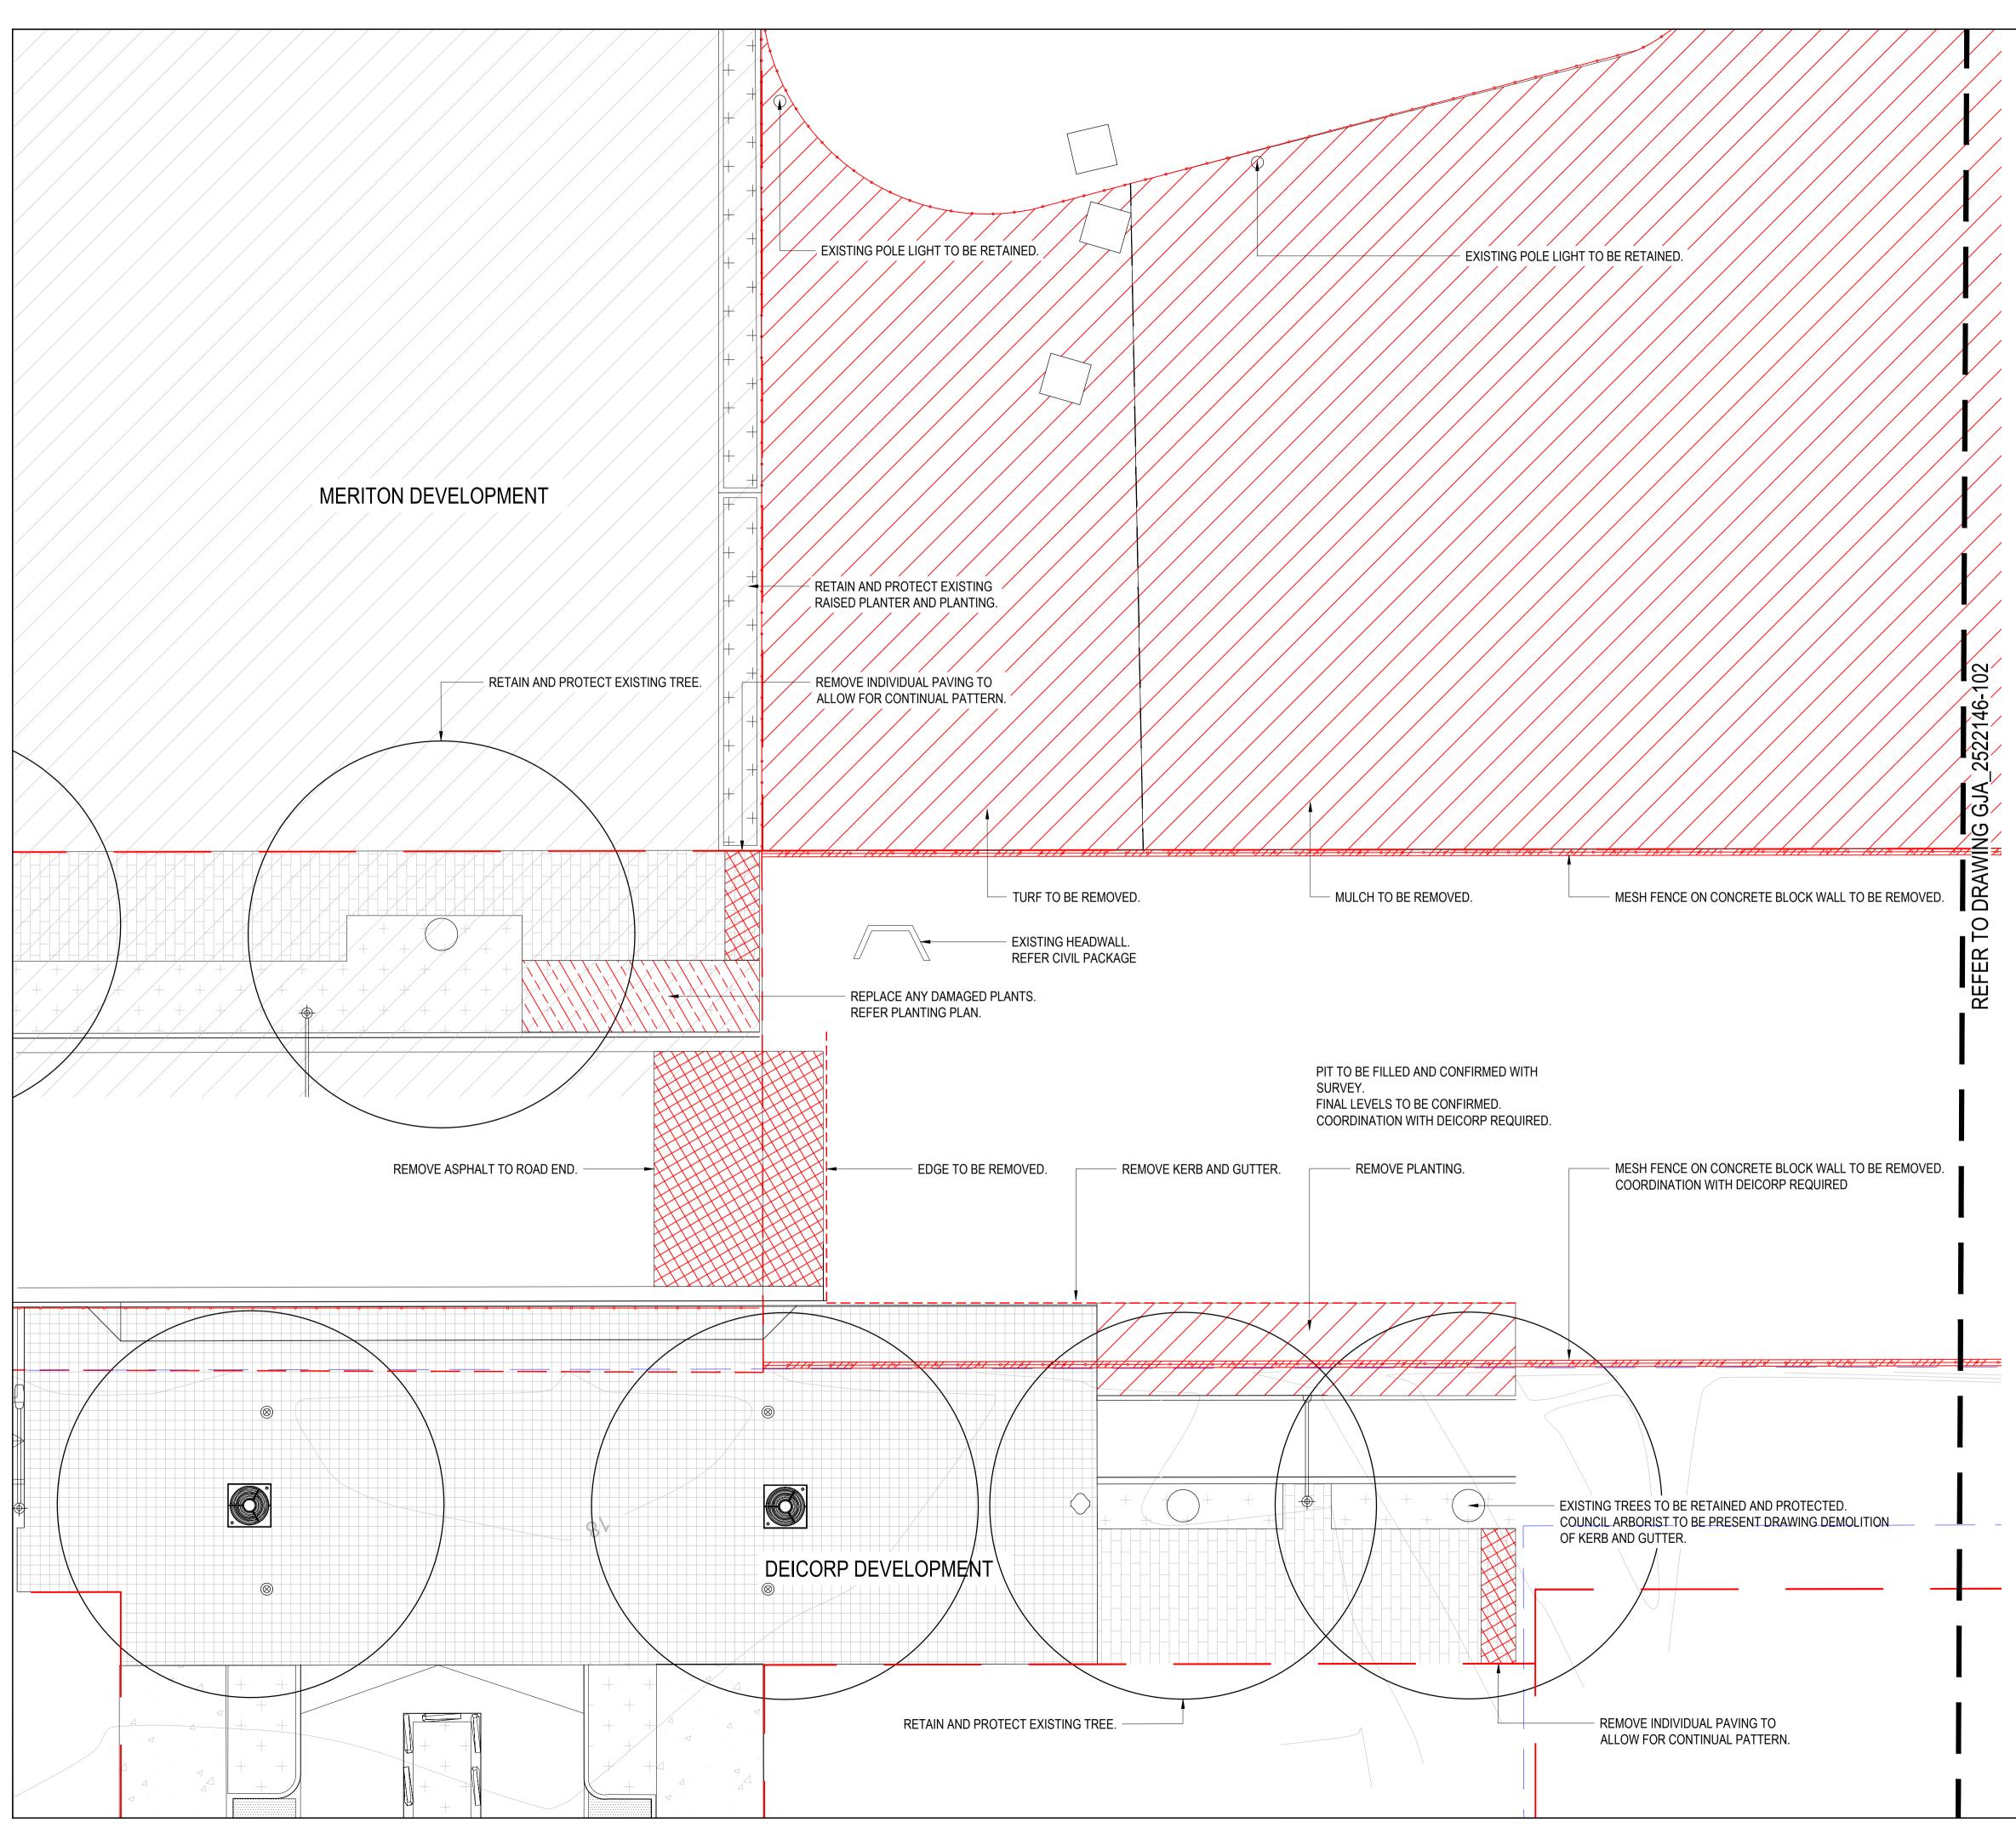


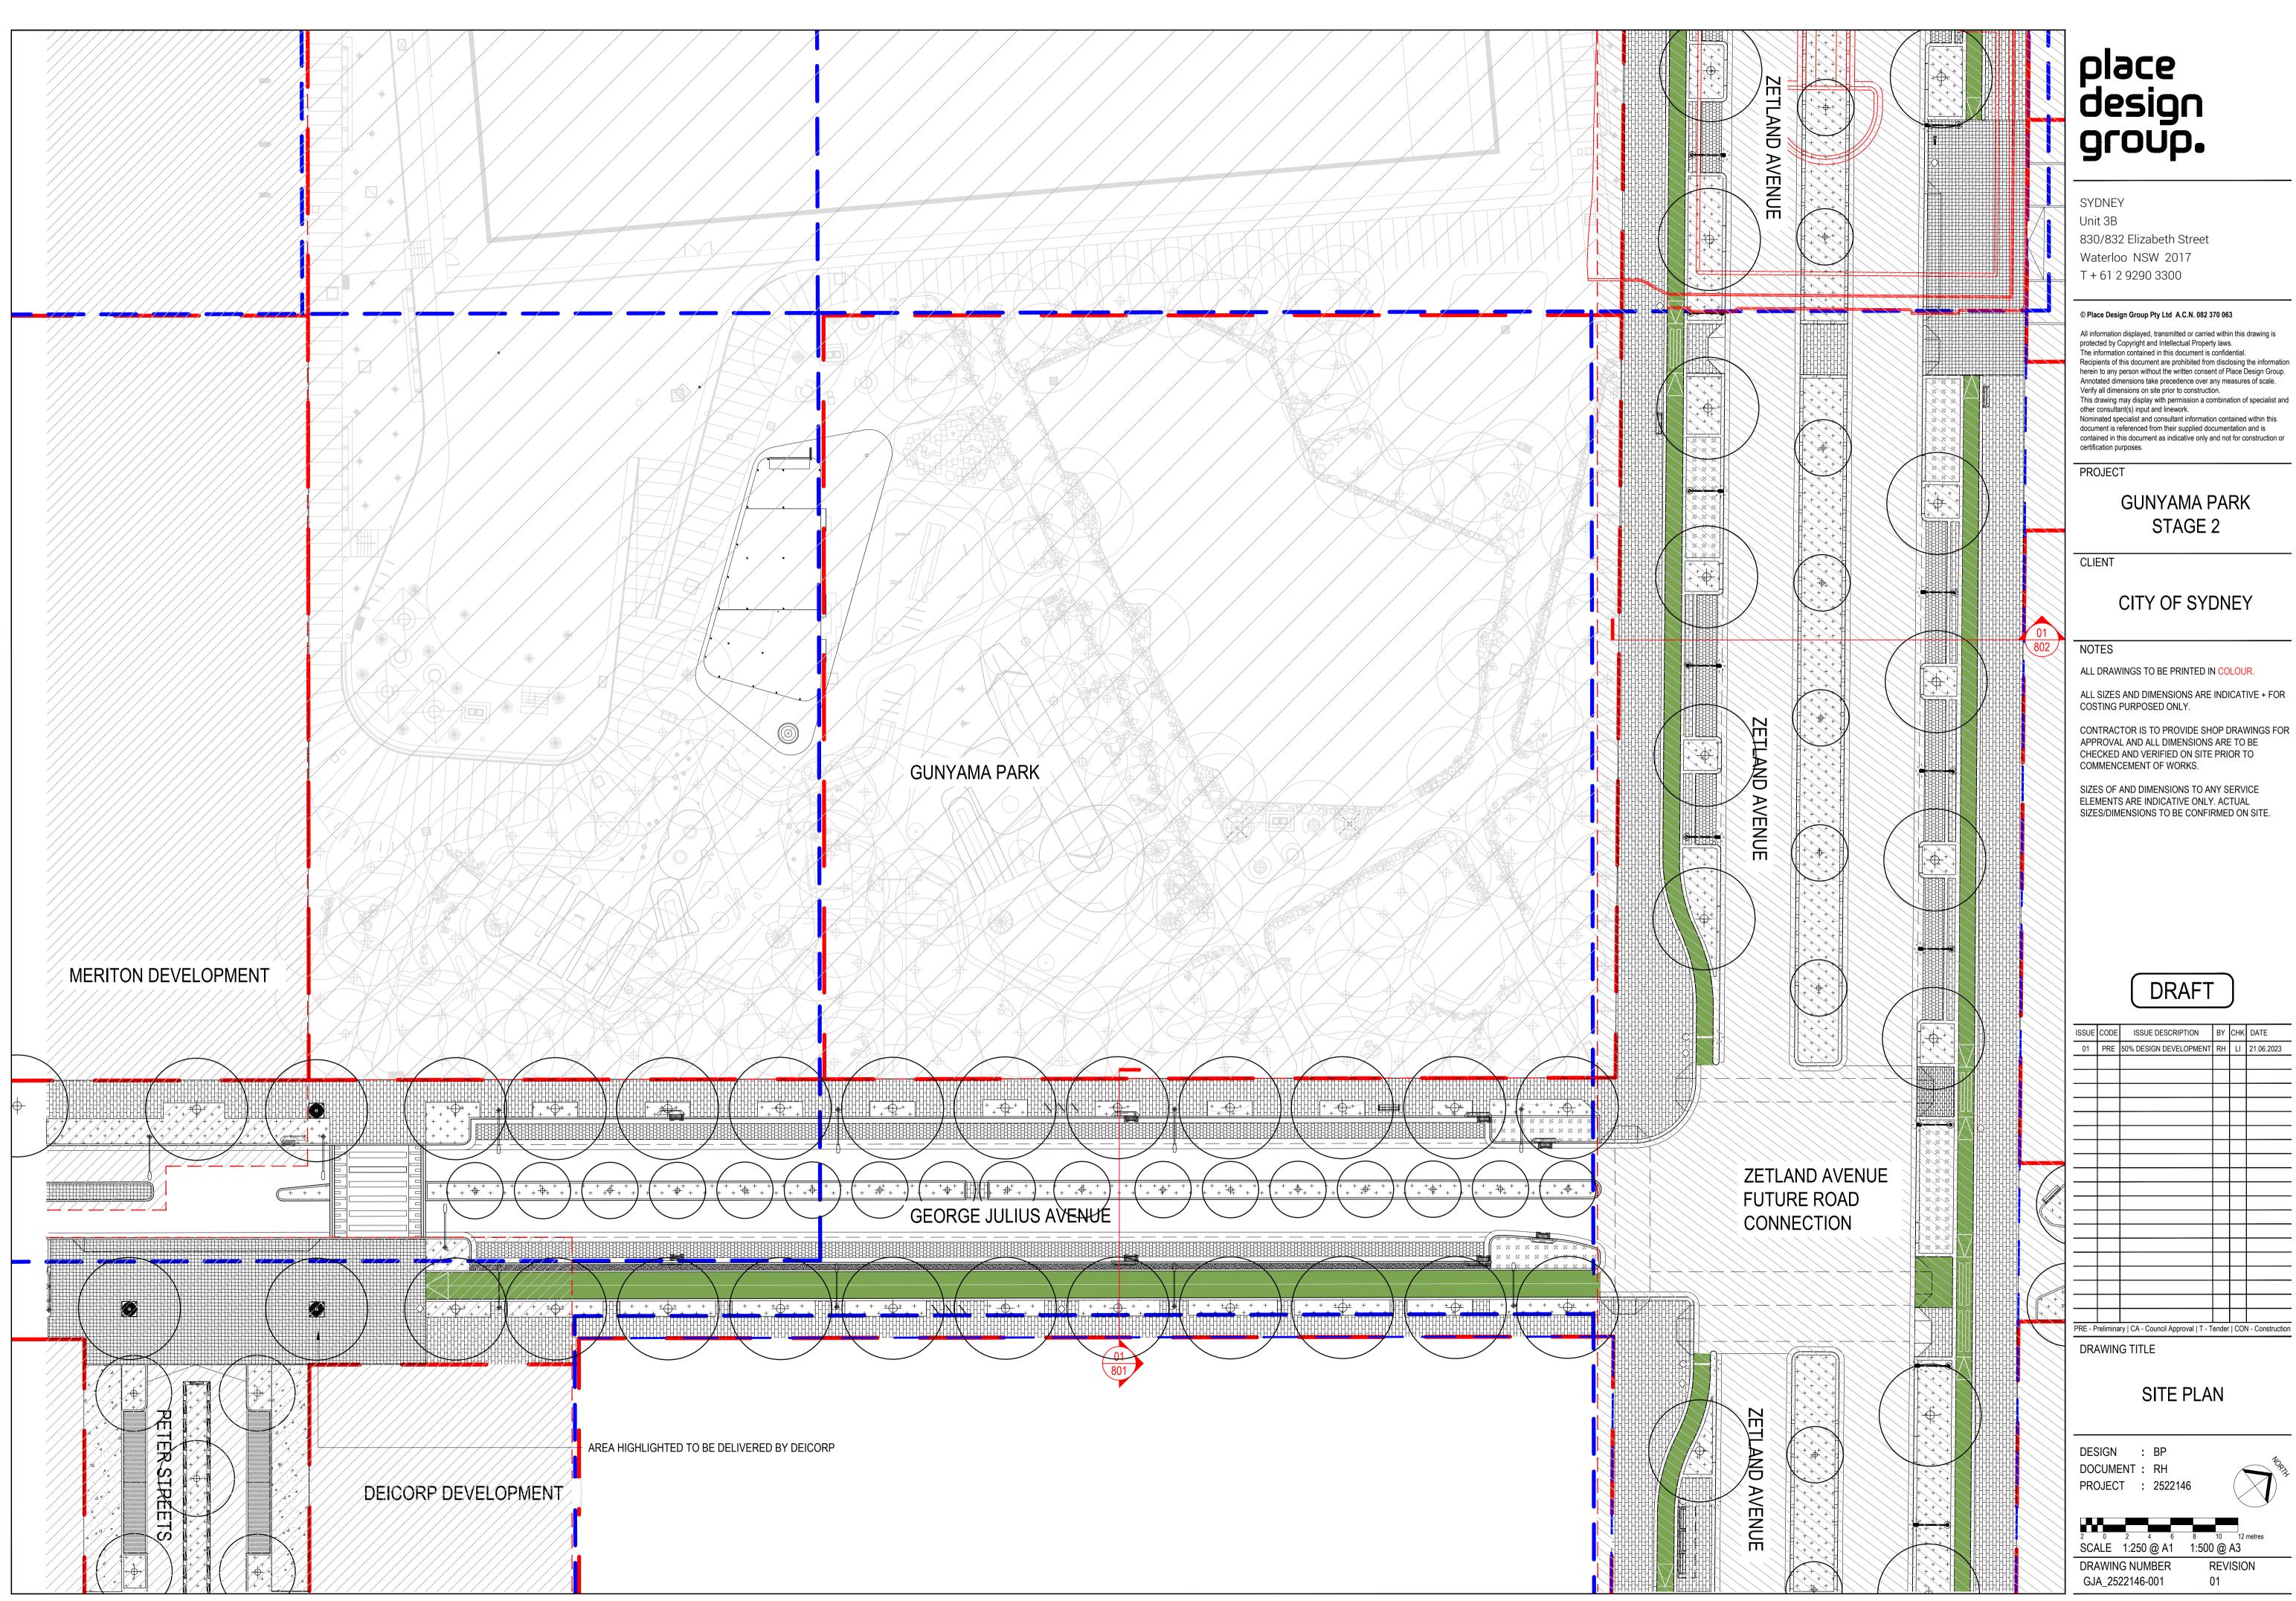ISSUE	CODE	ISSUE DESCRIPTION	BY	СНК	DATE
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ISSUE	CODE	ISSUE DESCRIPTION	BY	СНК	DATE	
01	PRE	50% DESIGN DEVELOPMENT	RH	LI	21.06.2023	
PRE - P	relimina	ry CA - Council Approval T - T	ender		N - Construction	



LEGEND SITE PREPARATION

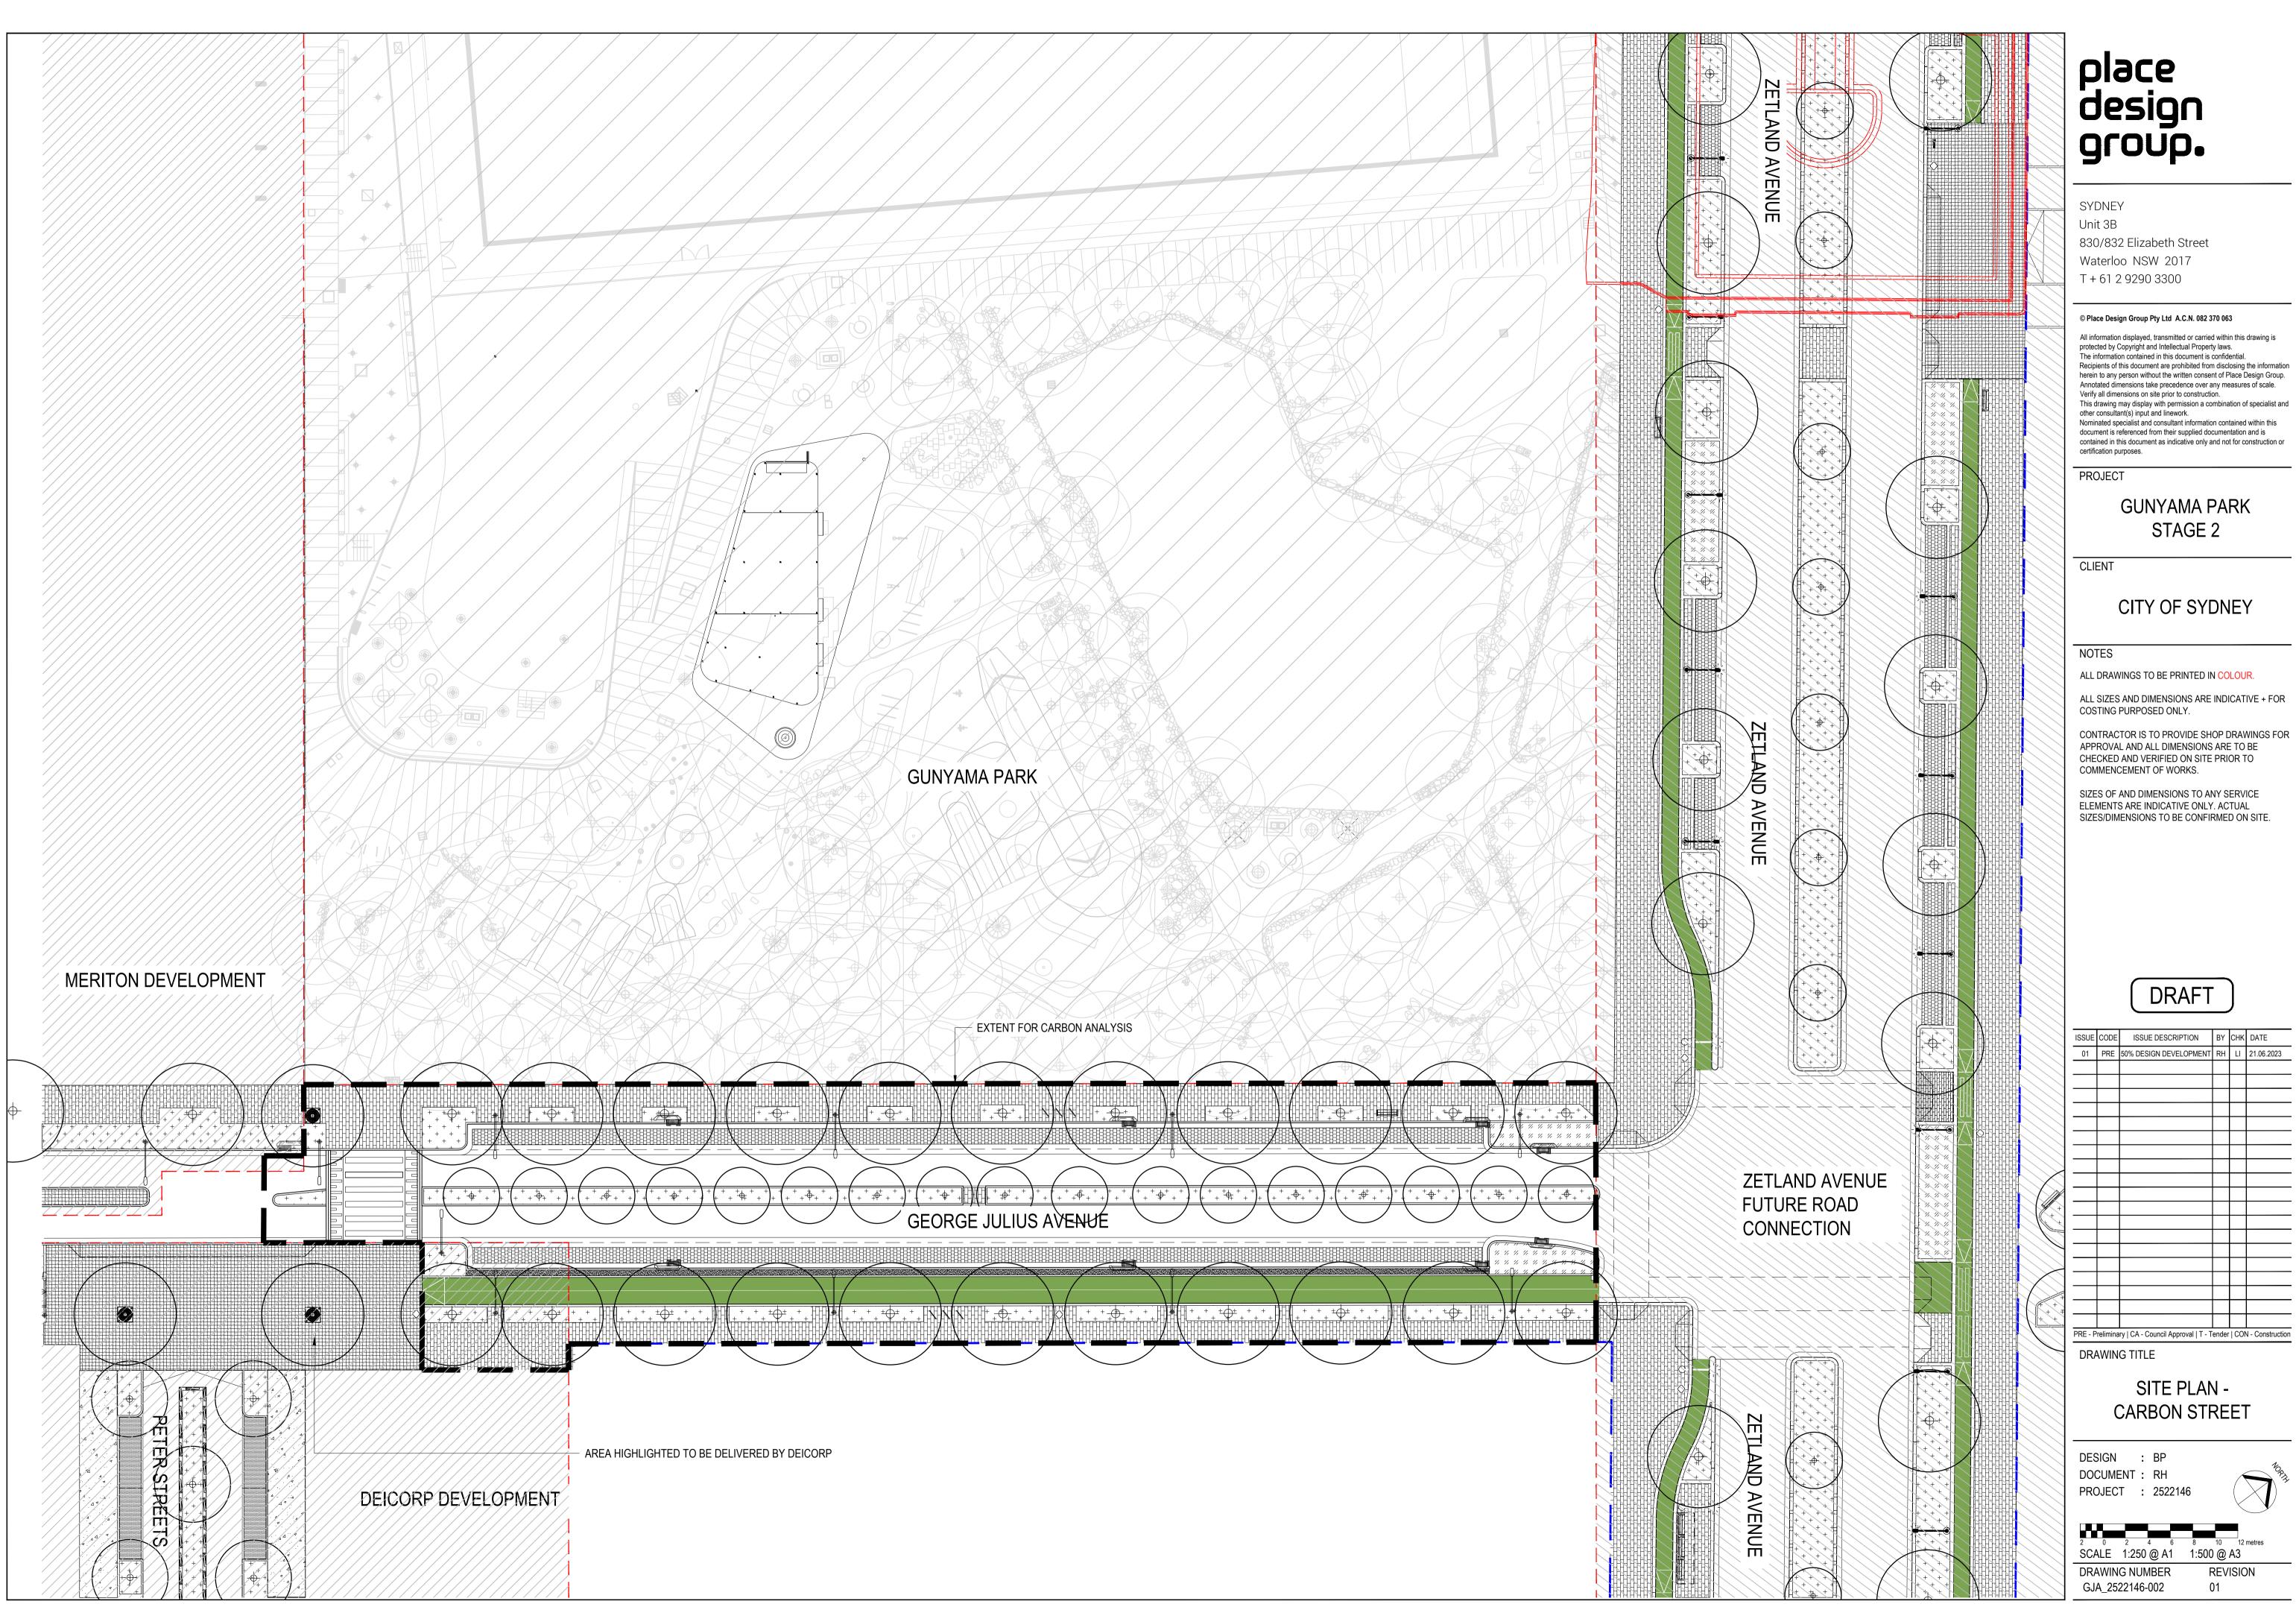	HARDSCAPE TO BE DEMOLISHED REFER TO SITE PREPARATION PLAN
	SOFTSCAPE TO BE DEMOLISHED REFER TO SITE PREPARATION PLAN
	SOFTSCAPE TO MAKE GOOD REFER TO SITE PREPARATION PLAN
	EDGE TO BE DEMOLISHED REFER TO SITE PREPARATION PLAN
•	EXISTING TREE TO BE RETAINED REFER TO SITE PREPARATION PLAN
0	EXISTING LIGHT POLE TO BE RETAINED REFER TO SITE PREPARATION PLAN
<u> </u>	EXISTING PLANTING TO BE RETAINED

REFER TO SITE PREPARATION PLAN

+

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PROJECT

GUNYAMA PARK STAGE 2

CLIENT

CITY OF SYDNEY

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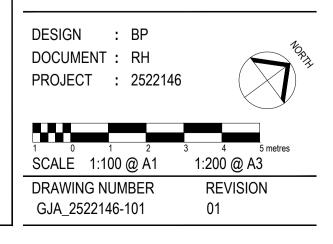
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01	PRE	50% DESIGN DEVELOPMENT	RH	LI	21.06.2023				
PRE - F	PRE - Preliminary CA - Council Approval T - Tender CON - Construction								

DRAWING TITLE

SITE PREPARATION PLAN





EXTENT OF ASPHALT TO BE REMOVED

SHEET-PILED WALL

"DEICORP TO CONFIRM EXISTING EXTENT OF SHEET-PILED RETAINING WALL. REFER TO DEICORP DESIGN & DOCUMENTATION FOR DETAILS OF PERMANENT RETENTION SYSTEM."

<u>,</u>

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ⁱ 0.

BLOCK WALL

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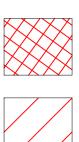
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"EXISTING REINFORCED BLOCKWORK RETAINING WALL TO REMAIN IN PLACE DURING BULK EARTHWORKS. ONCE SITE FILL WORKS HAVE REACHED 500MM BELOW EXISTING RETAINED LEVEL, BREAK DOWN TOP PORTION OF EXISTING WALL AND PROVIDE CORROSION PROTECTION COATING TO EXPOSED BLOCKWORK REINFORCEMENT. REMAINDER OF SITE FILL WORKS TO PROGRESS OVER THE EXISTING WALL WHICH IS TO REMAIN IN PLACE BELOW FINISHED BULK FILL LEVELS. EXISTING WALL LOCATION AND DEPTH TO STRUCTURE TO BE CAPTURED ON FUTURE PLANS TO ENSURE KNOWLEDGE OF BURIED STRUCTURE IS RETAINED."

LEGEND SITE PREPARATION



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HARDSCAPE TO BE DEMOLISHED REFER TO SITE PREPARATION PLAN

SOFTSCAPE TO BE DEMOLISHED REFER TO SITE PREPARATION PLAN

SOFTSCAPE TO MAKE GOOD REFER TO SITE PREPARATION PLAN

EDGE TO BE DEMOLISHED REFER TO SITE PREPARATION PLAN

EXISTING TREE TO BE RETAINED REFER TO SITE PREPARATION PLAN

EXISTING LIGHT POLE TO BE RETAINED REFER TO SITE PREPARATION PLAN

EXISTING PLANTING TO BE RETAINED REFER TO SITE PREPARATION PLAN

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PROJECT

GUNYAMA PARK STAGE 2

CLIENT

CITY OF SYDNEY

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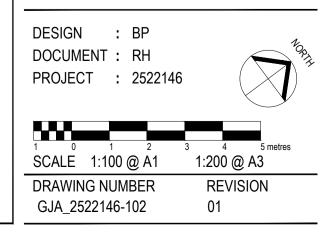
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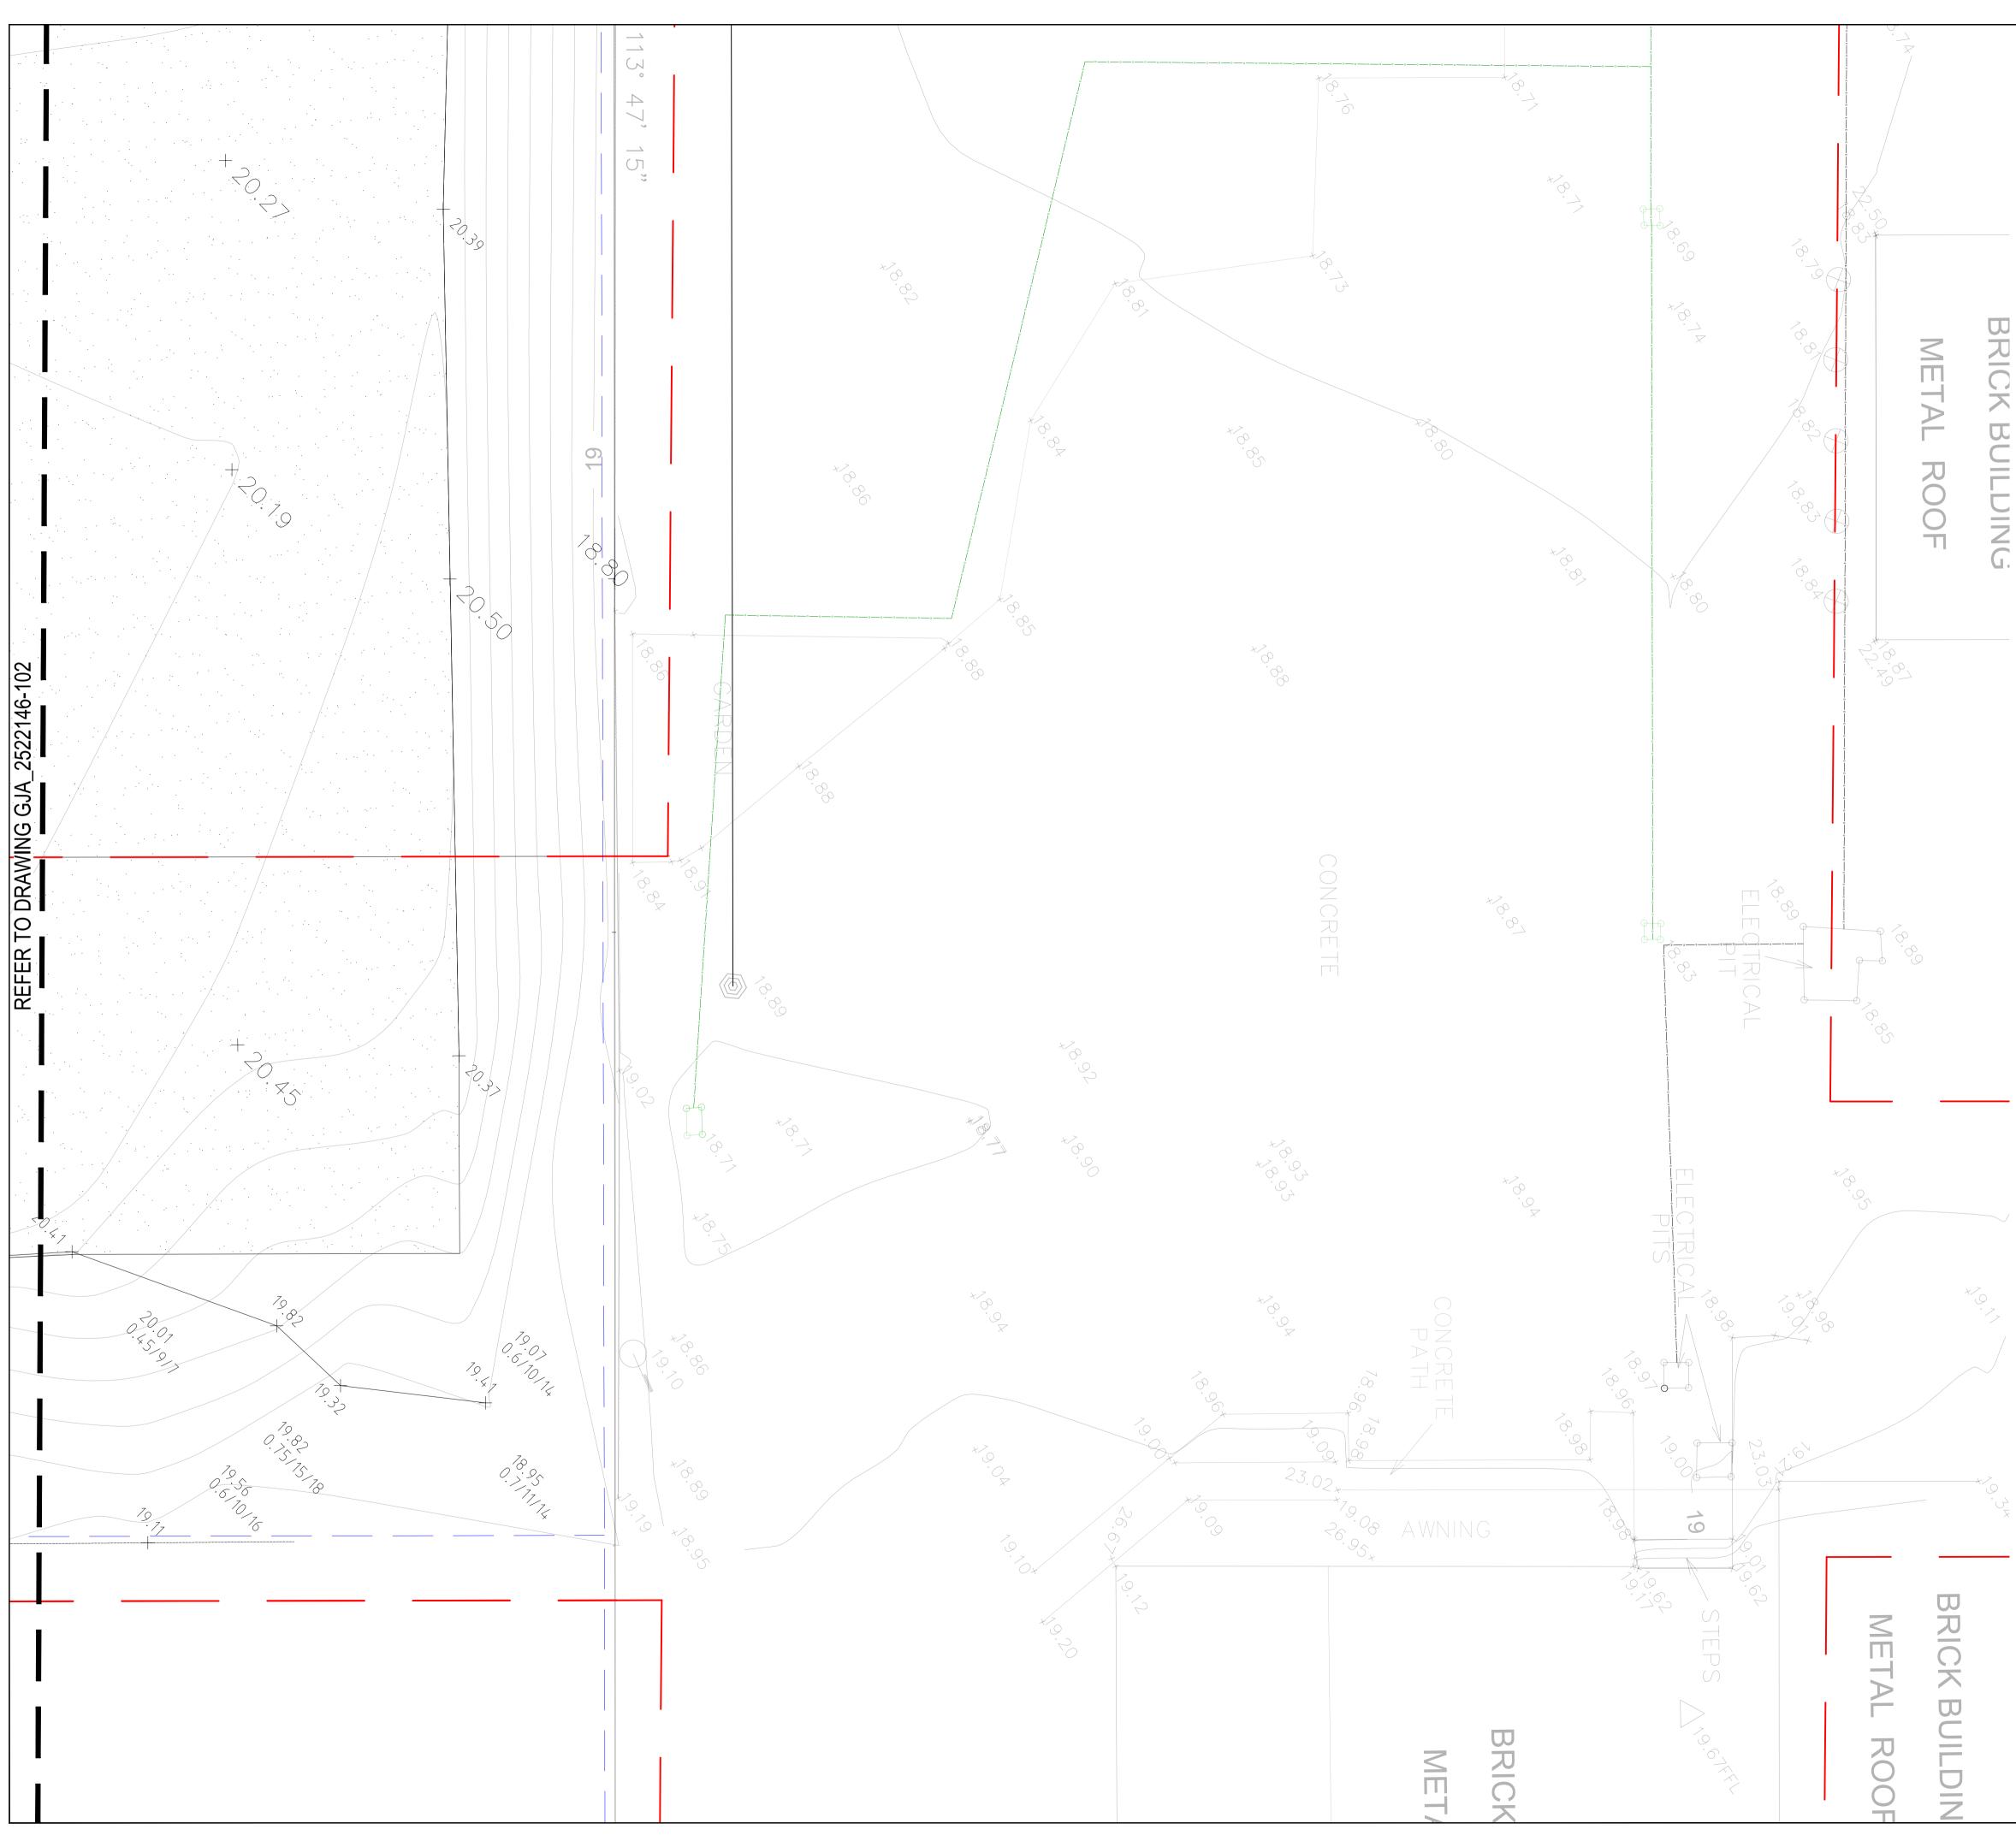


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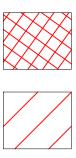
DRAWING TITLE

SITE PREPARATION PLAN





LEGEND SITE PREPARATION



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SOFTSCAPE TO BE DEMOLISHED REFER TO SITE PREPARATION PLAN

SOFTSCAPE TO MAKE GOOD REFER TO SITE PREPARATION PLAN

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PROJECT

GUNYAMA PARK STAGE 2

CLIENT

CITY OF SYDNEY

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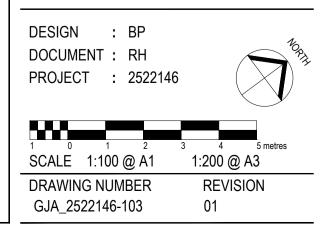
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SSUE	CODE	ISSUE DESCRIPTION	BY	СНК	DATE
01	PRE	50% DESIGN DEVELOPMENT	RH	LI	21.06.2023
	rolimir -	ry CA - Council Approval T - T	ander		Construct

DRAWING TITLE

SITE PREPARATION PLAN



				2522146_GJA_Gunyama Park_ Finishes and	Selection Schedule			PAVING TYPE 1 -	C2.3.1	Product: Concrete Pavers		https://www.cityofsydney.nsw.gov.au/design-codes-technica
DE	SCRIPTION	COS DETAIL	DESCRIPTION	RECOMMENDED SUPPLIER	ШИК	IMAGE			C2.3.5	Colour: ppx254:400 Finish: Honed	238 Woodpark Road, Smithfield NSW 2164 Phone: (02) 9604 3100	
KS	EE PIT BLISTER	C2.3.12	Tree grate with structural soil	Contractor	https://www.cityofsydney.nsw.gov.au/strategies-action-plans/street-tree-master-plan-2011	44			C2.3.8 C2.3.11	Size: 600mm x 400mm x 60mm thick	https://www.pebblecrete.com.au/concret e-pavers/	
	ROKEN KERB)	C2.3.12	nee grate with structural soli	Contractor	https://www.utyorsyuney.nsw.gov.au/strategies-action-plans/street-tree-master-plan-2011				C2.1.2 C2.1.4			
									C2.1.5 C2.1.8			
							P2	PAVING TYPE 2 - CAR		Product: Ecotrihex	Adbri Masonry - Moorebank ł	https://www.cityofsydney.nsw.gov.au/design-codes-technical-
								PARKING BAYS HIGH ORDER		Colour: Silver Finish: Standard	Address: 20 Kelso Cres, Moorebank NSW 2170	
TR	EE PIT IN PAVING	C2.3.12	Concrete unit paving Treepit arrangment	Contractor	https://www.cityofsydney.nsw.gov.au/strategies-action-plans/street-tree-master-plan-2011						Phone: (02) 9822 6822	
								PAVING TYPE 3 - SHARED ENVIRONMENT	C3.1.9	Product: Bipave80 Colour: Natural	Adbri Masonry - Moorebank Address: 20 Kelso Cres, Moorebank NSW	https://www.cityofsydney.nsw.gov.au/design-codes-technical-
TR	EE IN MASS PLANTING	Refer mass planting	g Refer mass planting	Contractor	https://www.cityofsydney.nsw.gov.au/strategies-action-plans/street-tree-master-plan-2011					Finish: Steel Honed Size: 230mm x 115mm x 80mm thick	2170 Phone: (02) 9822 6822	
			Is structural soil required as per C2.1.7								https://www.adbrimasonry.com.au/produc ts/bipave-80-professional/	
											ts/ bipave-80-professional/	
						- AND		PAVING TYPE 4 - INSITU CONCRETE			ł	https://www.cityofsydney.nsw.gov.au/design-codes-technical-
		Type 4 - Street tree master plan		Contractor	https://www.citvofsvdnev.nsw.gov.au/strategies-action-plans/street-tree-master-plan-2011			CONCRETE				
	NGE	master plan										
						SVAL Street						
						A BARANCE						
							P5		C3.1.1	Civil to confirm		https://www.cityofsydney.nsw.gov.au/design-codes-technical-
			Indicative detail in road median planting	Contractor	https://www.cityofsydney.nsw.gov.au/strategies-action-plans/street-tree-master-plan-2011			ASPHALT				
E	EDIAN	plan										
							FURNITURE A	AND FIXTURES				
	ALES/ RAIN GARDEN			Contractor	https://www.cityofsydney.nsw.gov.au/strategies-action-plans/street-tree-master-plan-2011			OUTDOOR BENCH TYPE 1	C4.2.1 & C4.2.2	Product: Tzannes 'Village Suite' Bench	ABUD (Australian Built Urban Designs)	https://www.cityofsydney.nsw.gov.au/design-codes-technical-
	TING	7.2.3 - LINED: SUBMERGED ZONE								Part Number: PN0120PC Cast Aluminium Body: Primed and powder coated	Address: 82 Oak Road, Kirrawee NSW 2232 Phone: (+61) 02 9710 9501	
		7.2.4 - UNLINED Civil to confirm				A THINK PARTY				bronze Fixing: To manufacturers specification		
		CIVIL CO CONTINU										
D F	ENCES						B1	BIN TYPE 1	C4.3.1		ABUD (Australian Built Urban Designs) Address: 82 Oak Road, Kirrawee NSW 2232	https://www.cityofsydney.nsw.gov.au/design-codes-technical-
	TONE KERB			Contractor	https://www.cityofsydney.nsw.gov.au/design-codes-technical-specifications/sydney-streets					and legs: 316SS Cast Aluminium doors: Powder coated Metropolis Bronze	Phone: (+61) 02 9710 9501	
										Aluminium doors: Powder coated Metropolis Bronze Ash Tray: 316 SS		
UE S	TONE FLUSH KERB			Contractor	https://www.cityofsydney.nsw.gov.au/design-codes-technical-specifications/sydney-streets		BL1	BOLLARD TYPE 1	C4.4.2	Product: Tzannes 'Village Suite' Bollard		https://www.cityofsydney.nsw.gov.au/design-codes-technical-
										Part Number: PN0127 Cast Aluminium Body: Primed and powder coated	Address: 82 Oak Road, Kirrawee NSW 2232 Phone: (+61) 02 9710 9501	
										bronze Fixing: To manufacturers specification		
NCR	TE KERB (Only)	C1.1.2		Contractor	https://www.cityofsydney.nsw.gov.au/design-codes-technical-specifications/sydney-streets							
	,		Expansion joints to be placed at 15m intevals and the interface with other fixed structures.				BK1	BIKERAIL TYPE 1	C5.1.1- C5.1.8 (TBC)	Product: City of Syndey Standard Parks Bikerail		https://www.cityofsydney.nsw.gov.au/design-codes-technical-
			Height: 150mm Width: 150mm							Part Number: PN00143 Material: To manufacturers specification	Address: 82 Oak Road, Kirrawee NSW 2232 Phone: (+61) 02 9710 9501	
										Fixing: Below ground		
USH (CONCRETE KERB	C1.1.2	25MPa Concrete Kerb	Contractor	https://www.cityofsydney.nsw.gov.au/design-codes-technical-specifications/sydney-streets							
50mm)			Expansion joints to be placed at 15m intevals and the interface with other fixed structures.									
			Height: 150mm									
			Width: 150mm									
24				Contractor	https://www.dtj.afa.dta.com.com.dla-ta-a-d-a-d-d-d-d-d-d-d-d-d-d-d-d-d-d-d							
OKENK	KEKB			Contractor	https://www.cityofsydney.nsw.gov.au/design-codes-technical-specifications/sydney-streets							
-												
	NCRETE KERB AND		25MPa Concrete Kerb Expansion joints to be placed at 15m intevals and the	Contractor	https://www.cityofsydney.nsw.gov.au/design-codes-technical-specifications/sydney-streets							
Лы			interface with other fixed structures. (Refer items for dimensions)									
			nerer items for dimensions)									
ONCR	ETE GUTTER	C1.1.2		Contractor	https://www.cityofsydney.nsw.gov.au/design-codes-technical-specifications/sydney-streets							
			Expansion joints to be placed at 15m intevals and the interface with other fixed structures.									
			Width: 450mm									
	RAIN	C1.1.2	25MPa Concrete dish crossing on 150mm thick	Contractor	https://www.cityofsydney.nsw.gov.au/design-codes-technical-specifications/sydney-streets							
снD			compacted DGB20 Width: 900mm		,, e.e, e.e, e.e,							
SH D		1	wian: 900mm									
SH DR4												
SH DRAII												
SH DRA												



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PROJECT

GUNYAMA PARK STAGE 2

CLIENT

CITY OF SYDNEY

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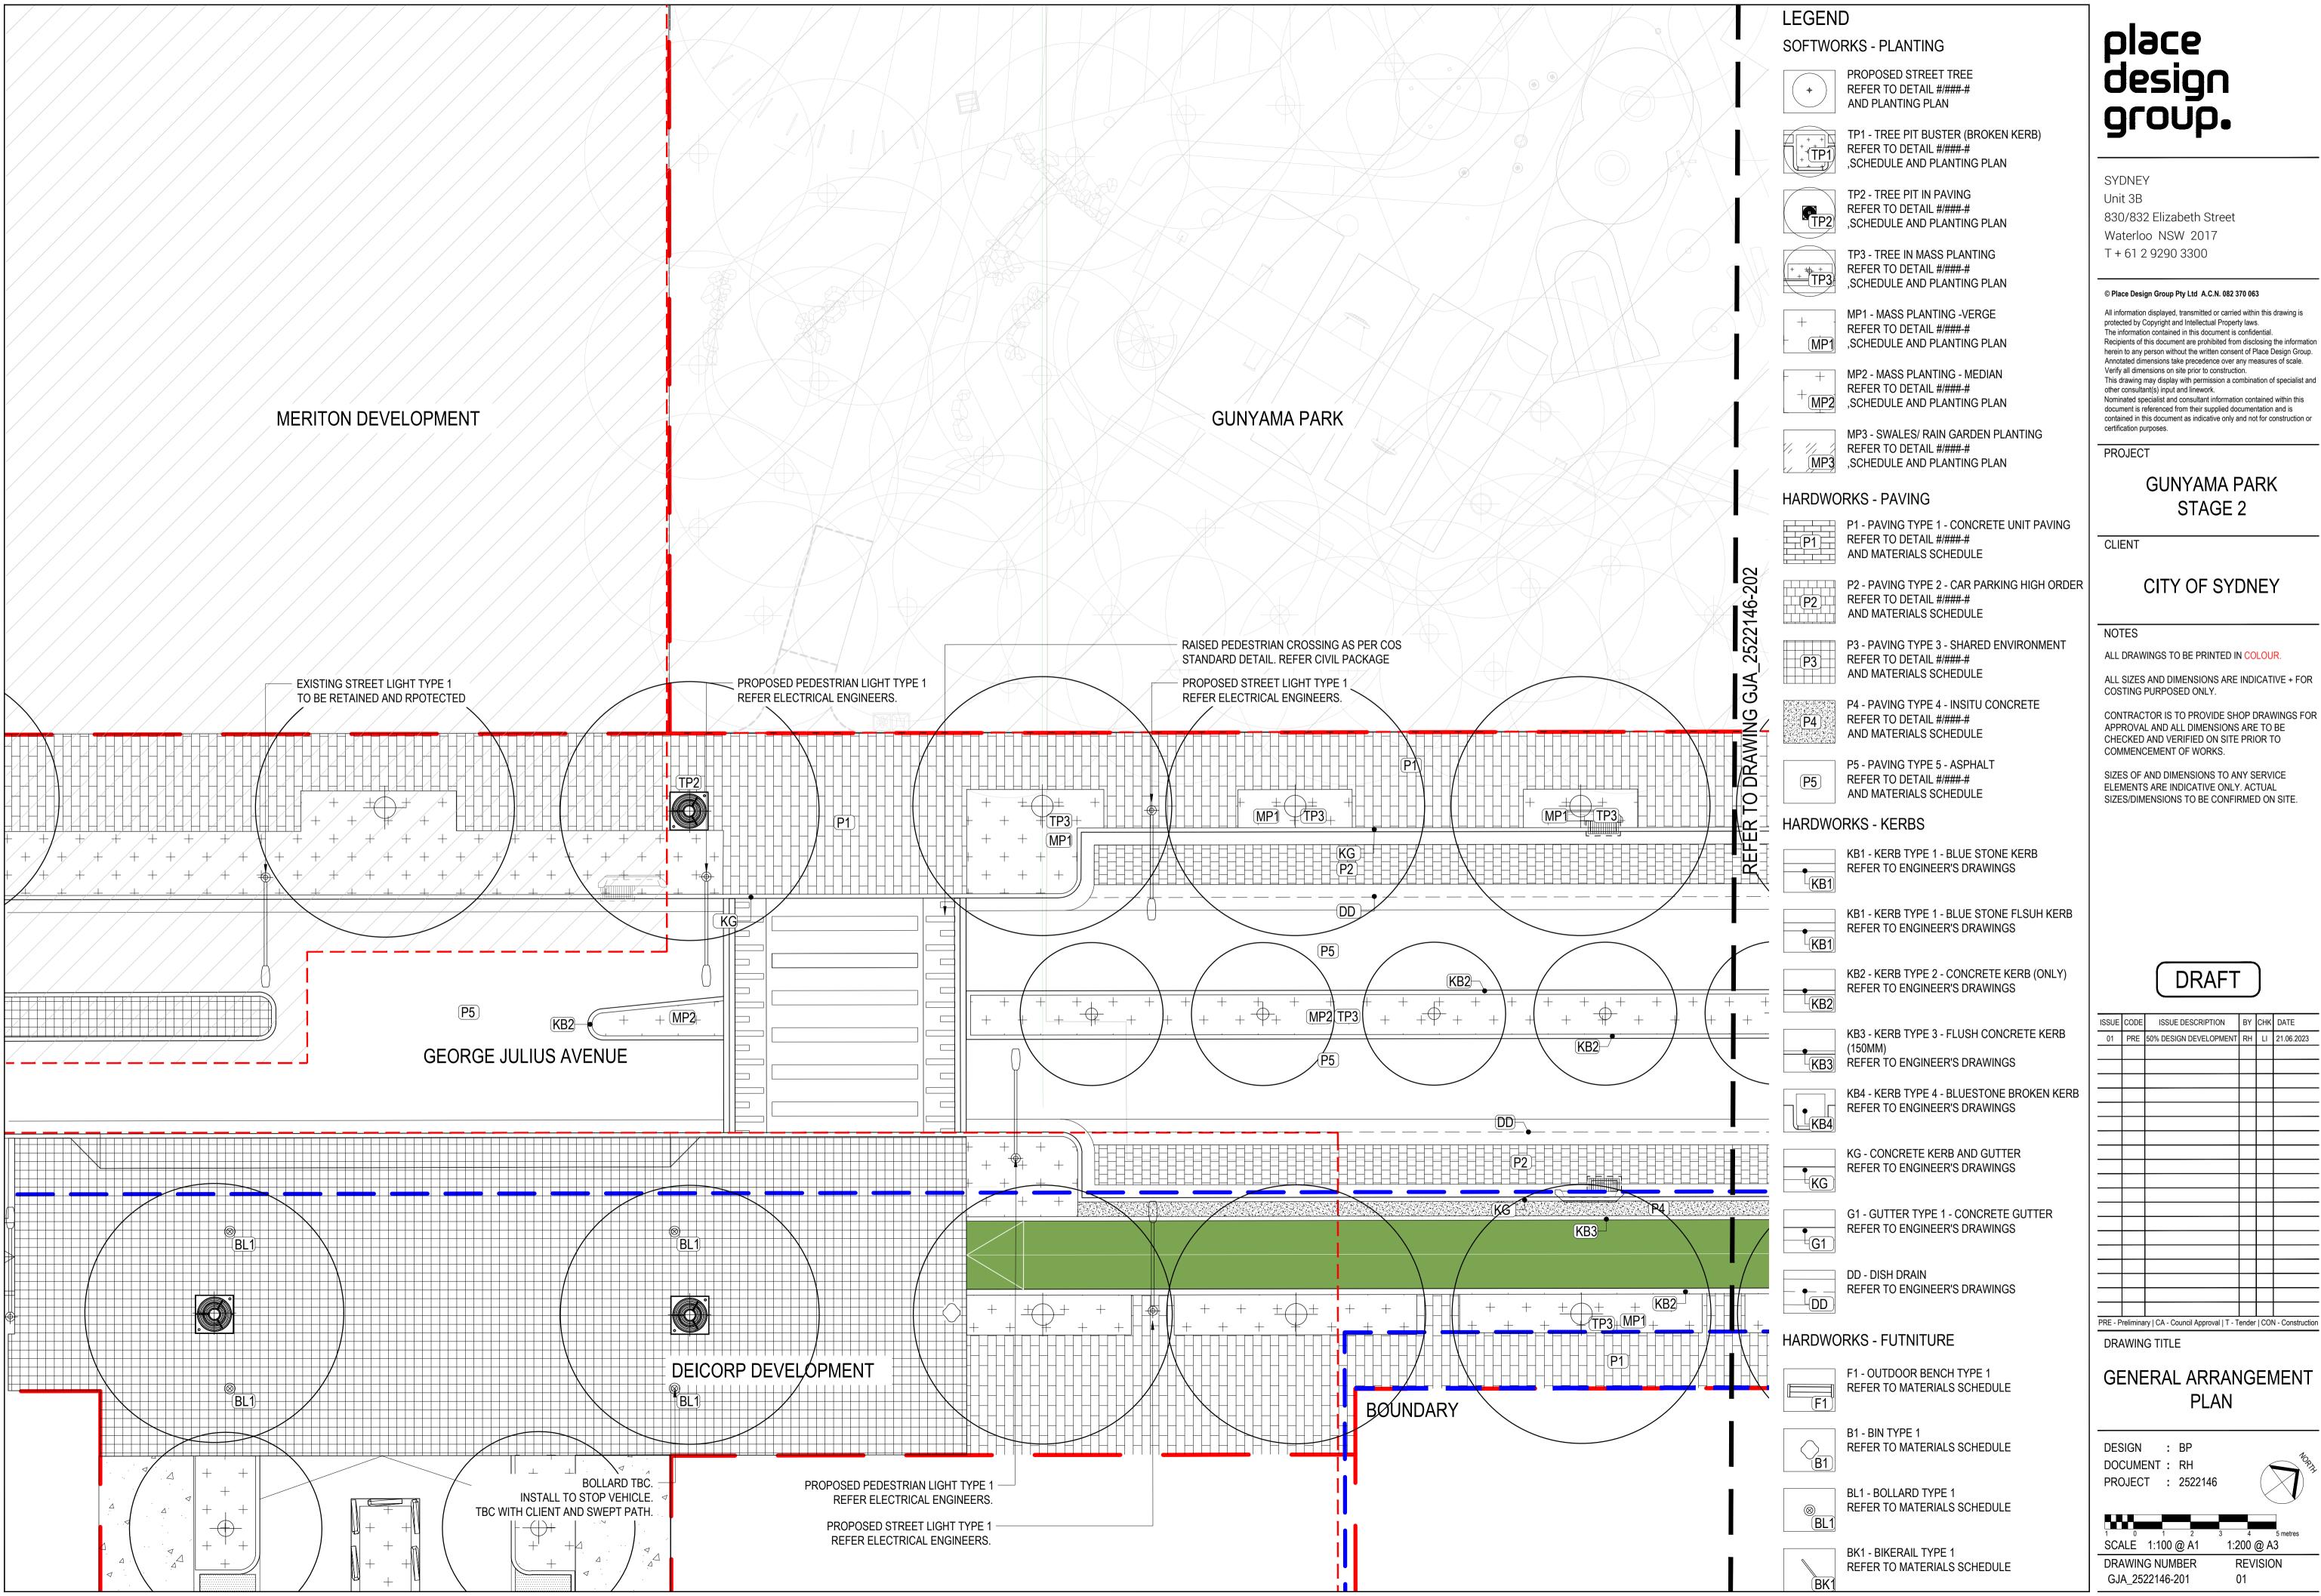
DRAWING TITLE

MATERIALS SCHEDULE

DESIGN : BP DOCUMENT : RH PROJECT : 2522146


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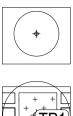




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01	PRE	50% DESIGN DEVELOPMENT	RH	LI	21.06.2023
PRE - P	relimina	ry CA - Council Approval T - T	ender		N - Construction
DRA	WIN	G TITLE			



LEGEND SOFTWORKS - PLANTING

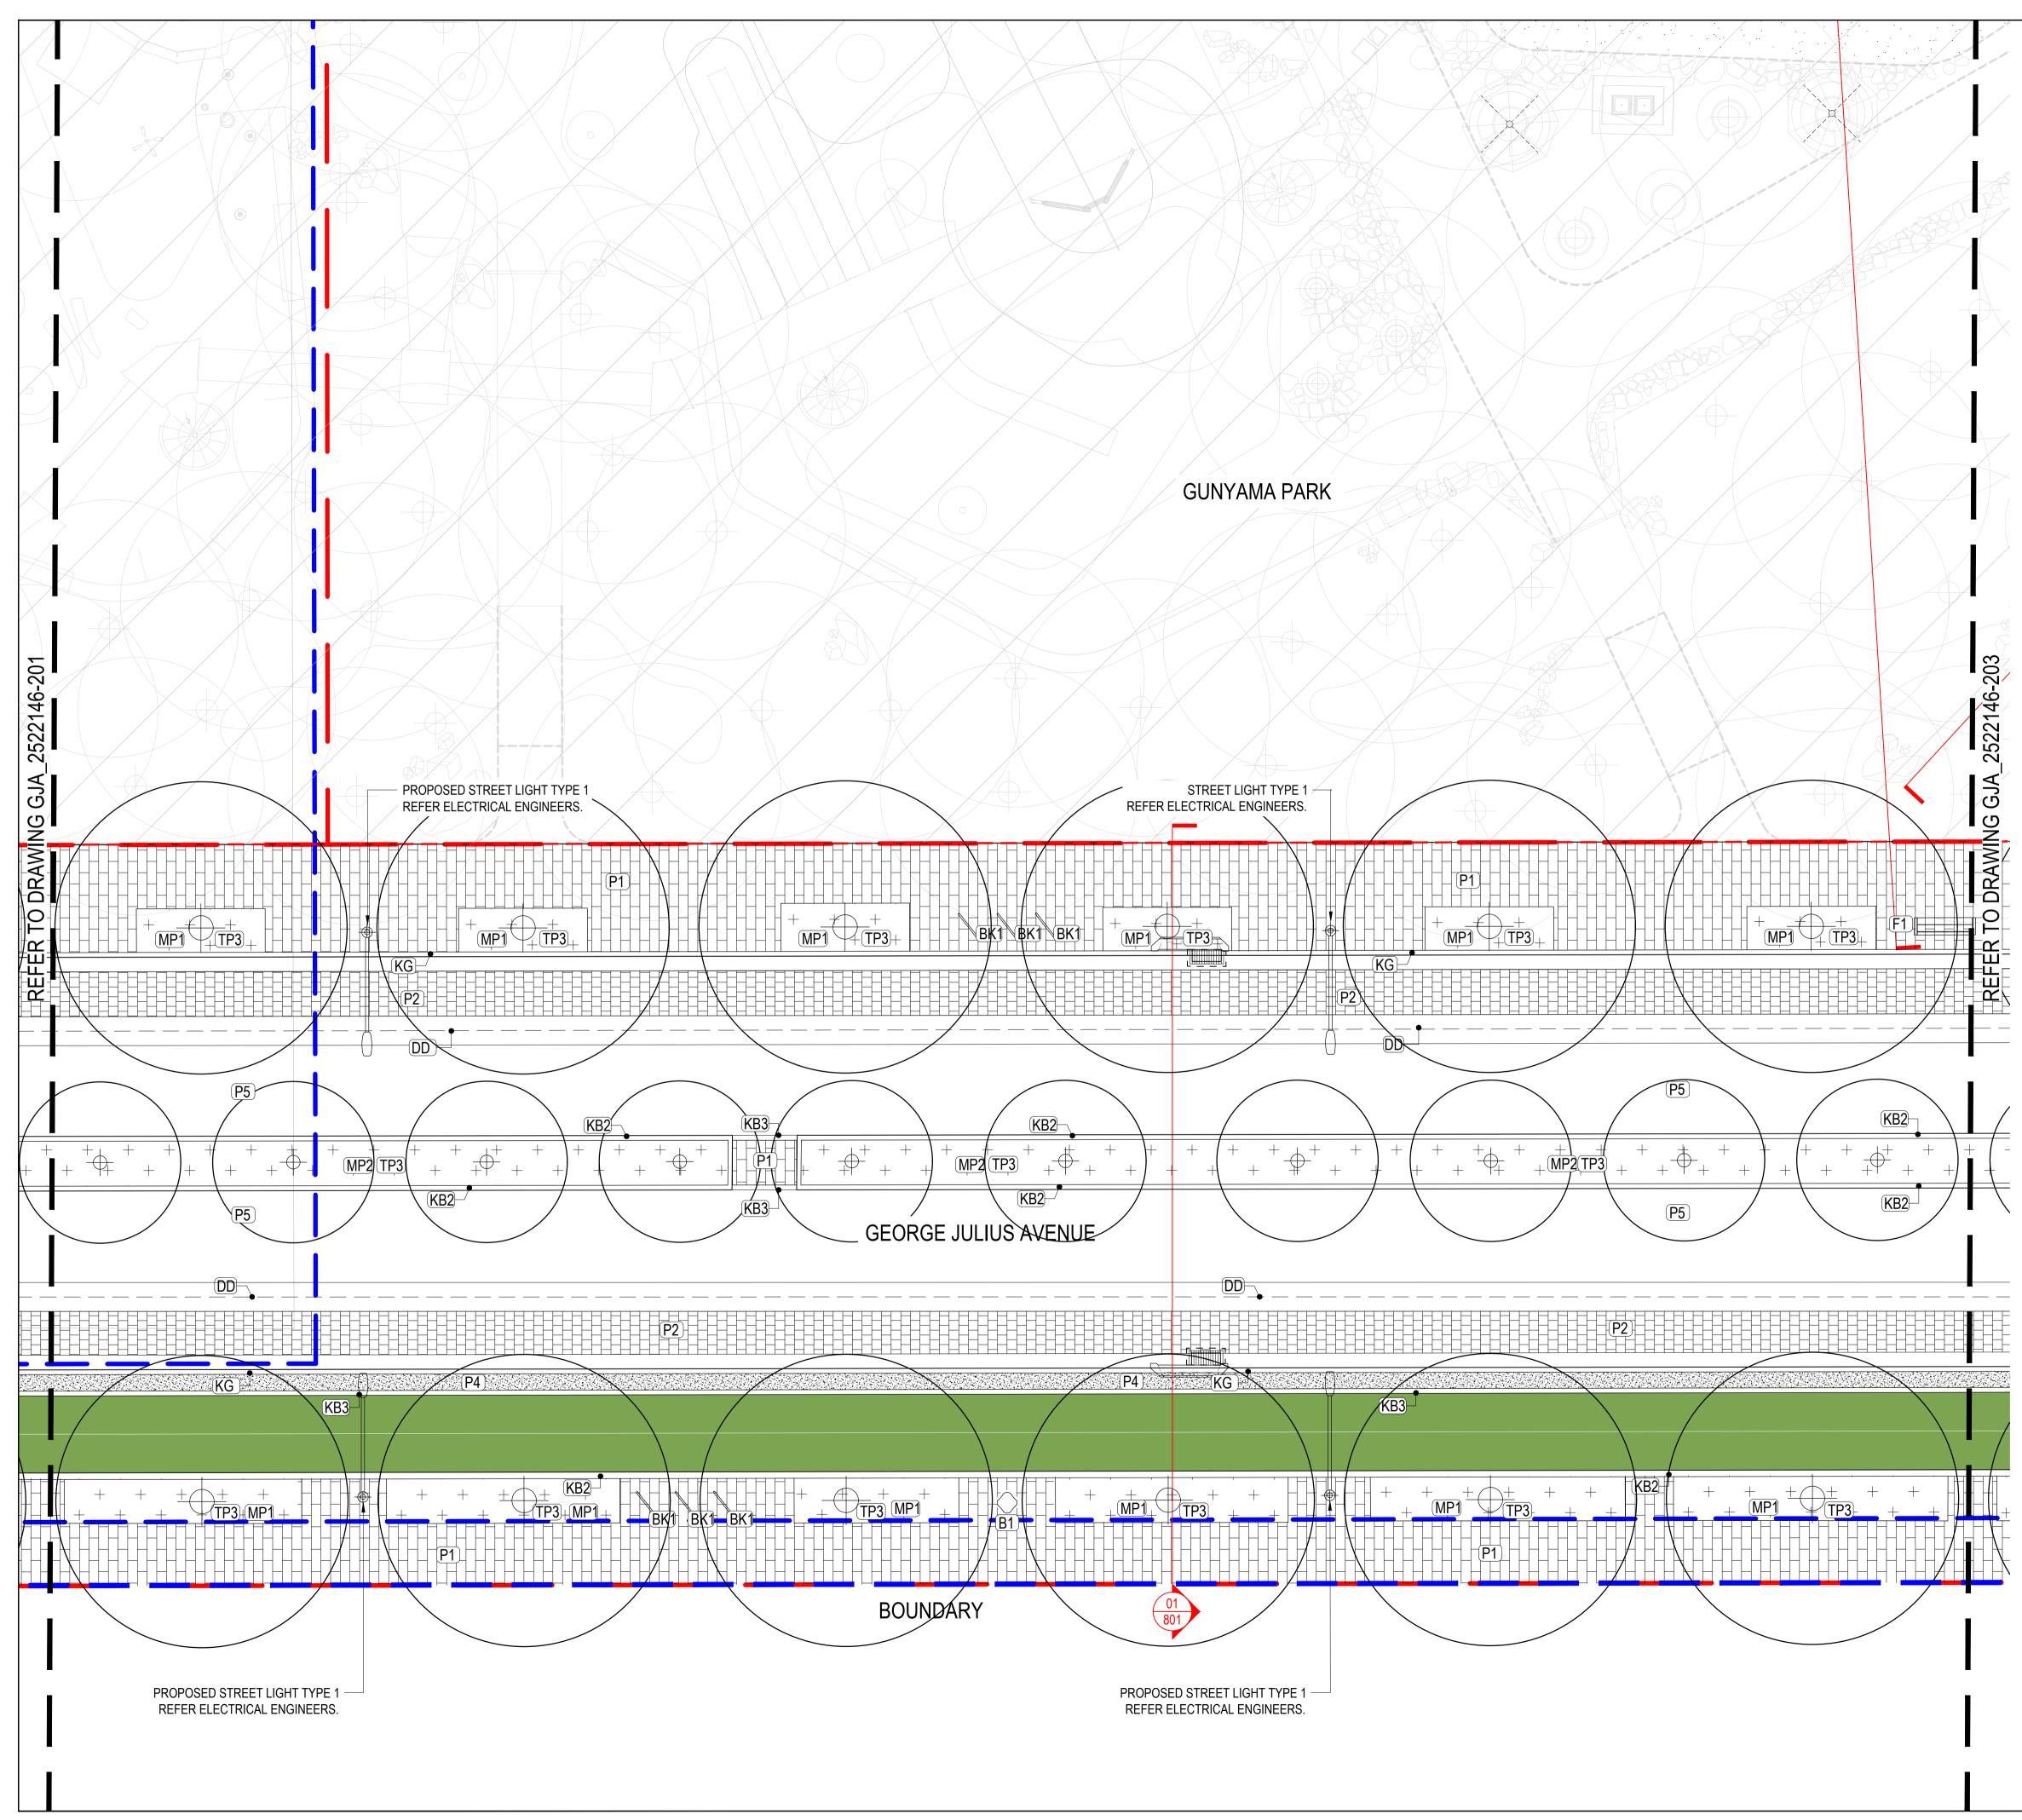

PROPOSED STREET TREE REFER TO DETAIL #/###-# AND PLANTING PLAN

TP1 - TREE PIT BUSTER (BROKEN KERB) REFER TO DETAIL #/###-#

,SCHEDULE AND PLANTING PLAN TP2 - TREE PIT IN PAVING

TP3 - TREE IN MASS PLANTING REFER TO DETAIL #/###-# REFER TO DETAIL #/###-# ,SCHEDULE AND PLANTING PLAN



MP1 - MASS PLANTING -VERGE REFER TO DETAIL #/###-# MP1 ,SCHEDULE AND PLANTING PLAN

1/,

MP2 - MASS PLANTING - MEDIAN REFER TO DETAIL #/###-# MP2 ,SCHEDULE AND PLANTING PLAN

MP3 - SWALES/ RAIN GARDEN PLANTING REFER TO DETAIL #/###-# MP3 ,SCHEDULE AND PLANTING PLAN

HARDWORKS - PAVING



P1 - PAVING TYPE 1 - CONCRETE UNIT PAVING P1 REFER TO DETAIL #/###-# AND MATERIALS SCHEDULE P2 - PAVING TYPE 2 - CAR PARKING HIGH ORDER

P2 REFER TO DETAIL #/###-# AND MATERIALS SCHEDULE



P3 - PAVING TYPE 3 - SHARED ENVIRONMENT P3 REFER TO DETAIL #/###-# AND MATERIALS SCHEDULE

(P4)

P4 - PAVING TYPE 4 - INSITU CONCRETE REFER TO DETAIL #/###-# AND MATERIALS SCHEDULE

(P5)

P5 - PAVING TYPE 5 - ASPHALT REFER TO DETAIL #/###-# AND MATERIALS SCHEDULE

HARDWORKS - KERBS




КВ1 - KERB TYPE 1 - BLUE STONE K REFER TO ENGINEER'S DRAWINGS KB1 - KERB TYPE 1 - BLUE STONE KERB



REFER TO ENGINEER'S DRAWINGS

KB2

KB3 - KERB TYPE 3 - FLUSH CONCRETE KERB (150MM) (150MM) **KB3** REFER TO ENGINEER'S DRAWINGS

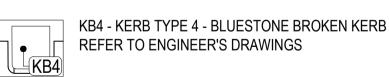

• KG

KG - CONCRETE KERB AND GUTTER REFER TO ENGINEER'S DRAWINGS

G1 - GUTTER TYPE 1 - CONCRETE GUTTER • ----G1

- REFER TO ENGINEER'S DRAWINGS

DD - DISH DRAIN _ • _ _ REFER TO ENGINEER'S DRAWINGS

HARDWORKS - FUTNITURE



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BK1

B1

F1 - OUTDOOR BENCH TYPE 1 REFER TO MATERIALS SCHEDULE

B1 - BIN TYPE 1 REFER TO MATERIALS SCHEDULE

BL1 - BOLLARD TYPE 1 REFER TO MATERIALS SCHEDULE BL1

> BK1 - BIKERAIL TYPE 1 **REFER TO MATERIALS SCHEDULE**

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PROJECT

GUNYAMA PARK STAGE 2

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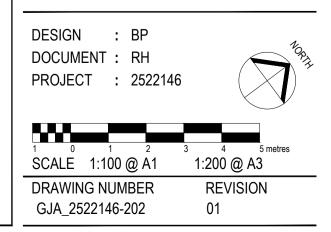
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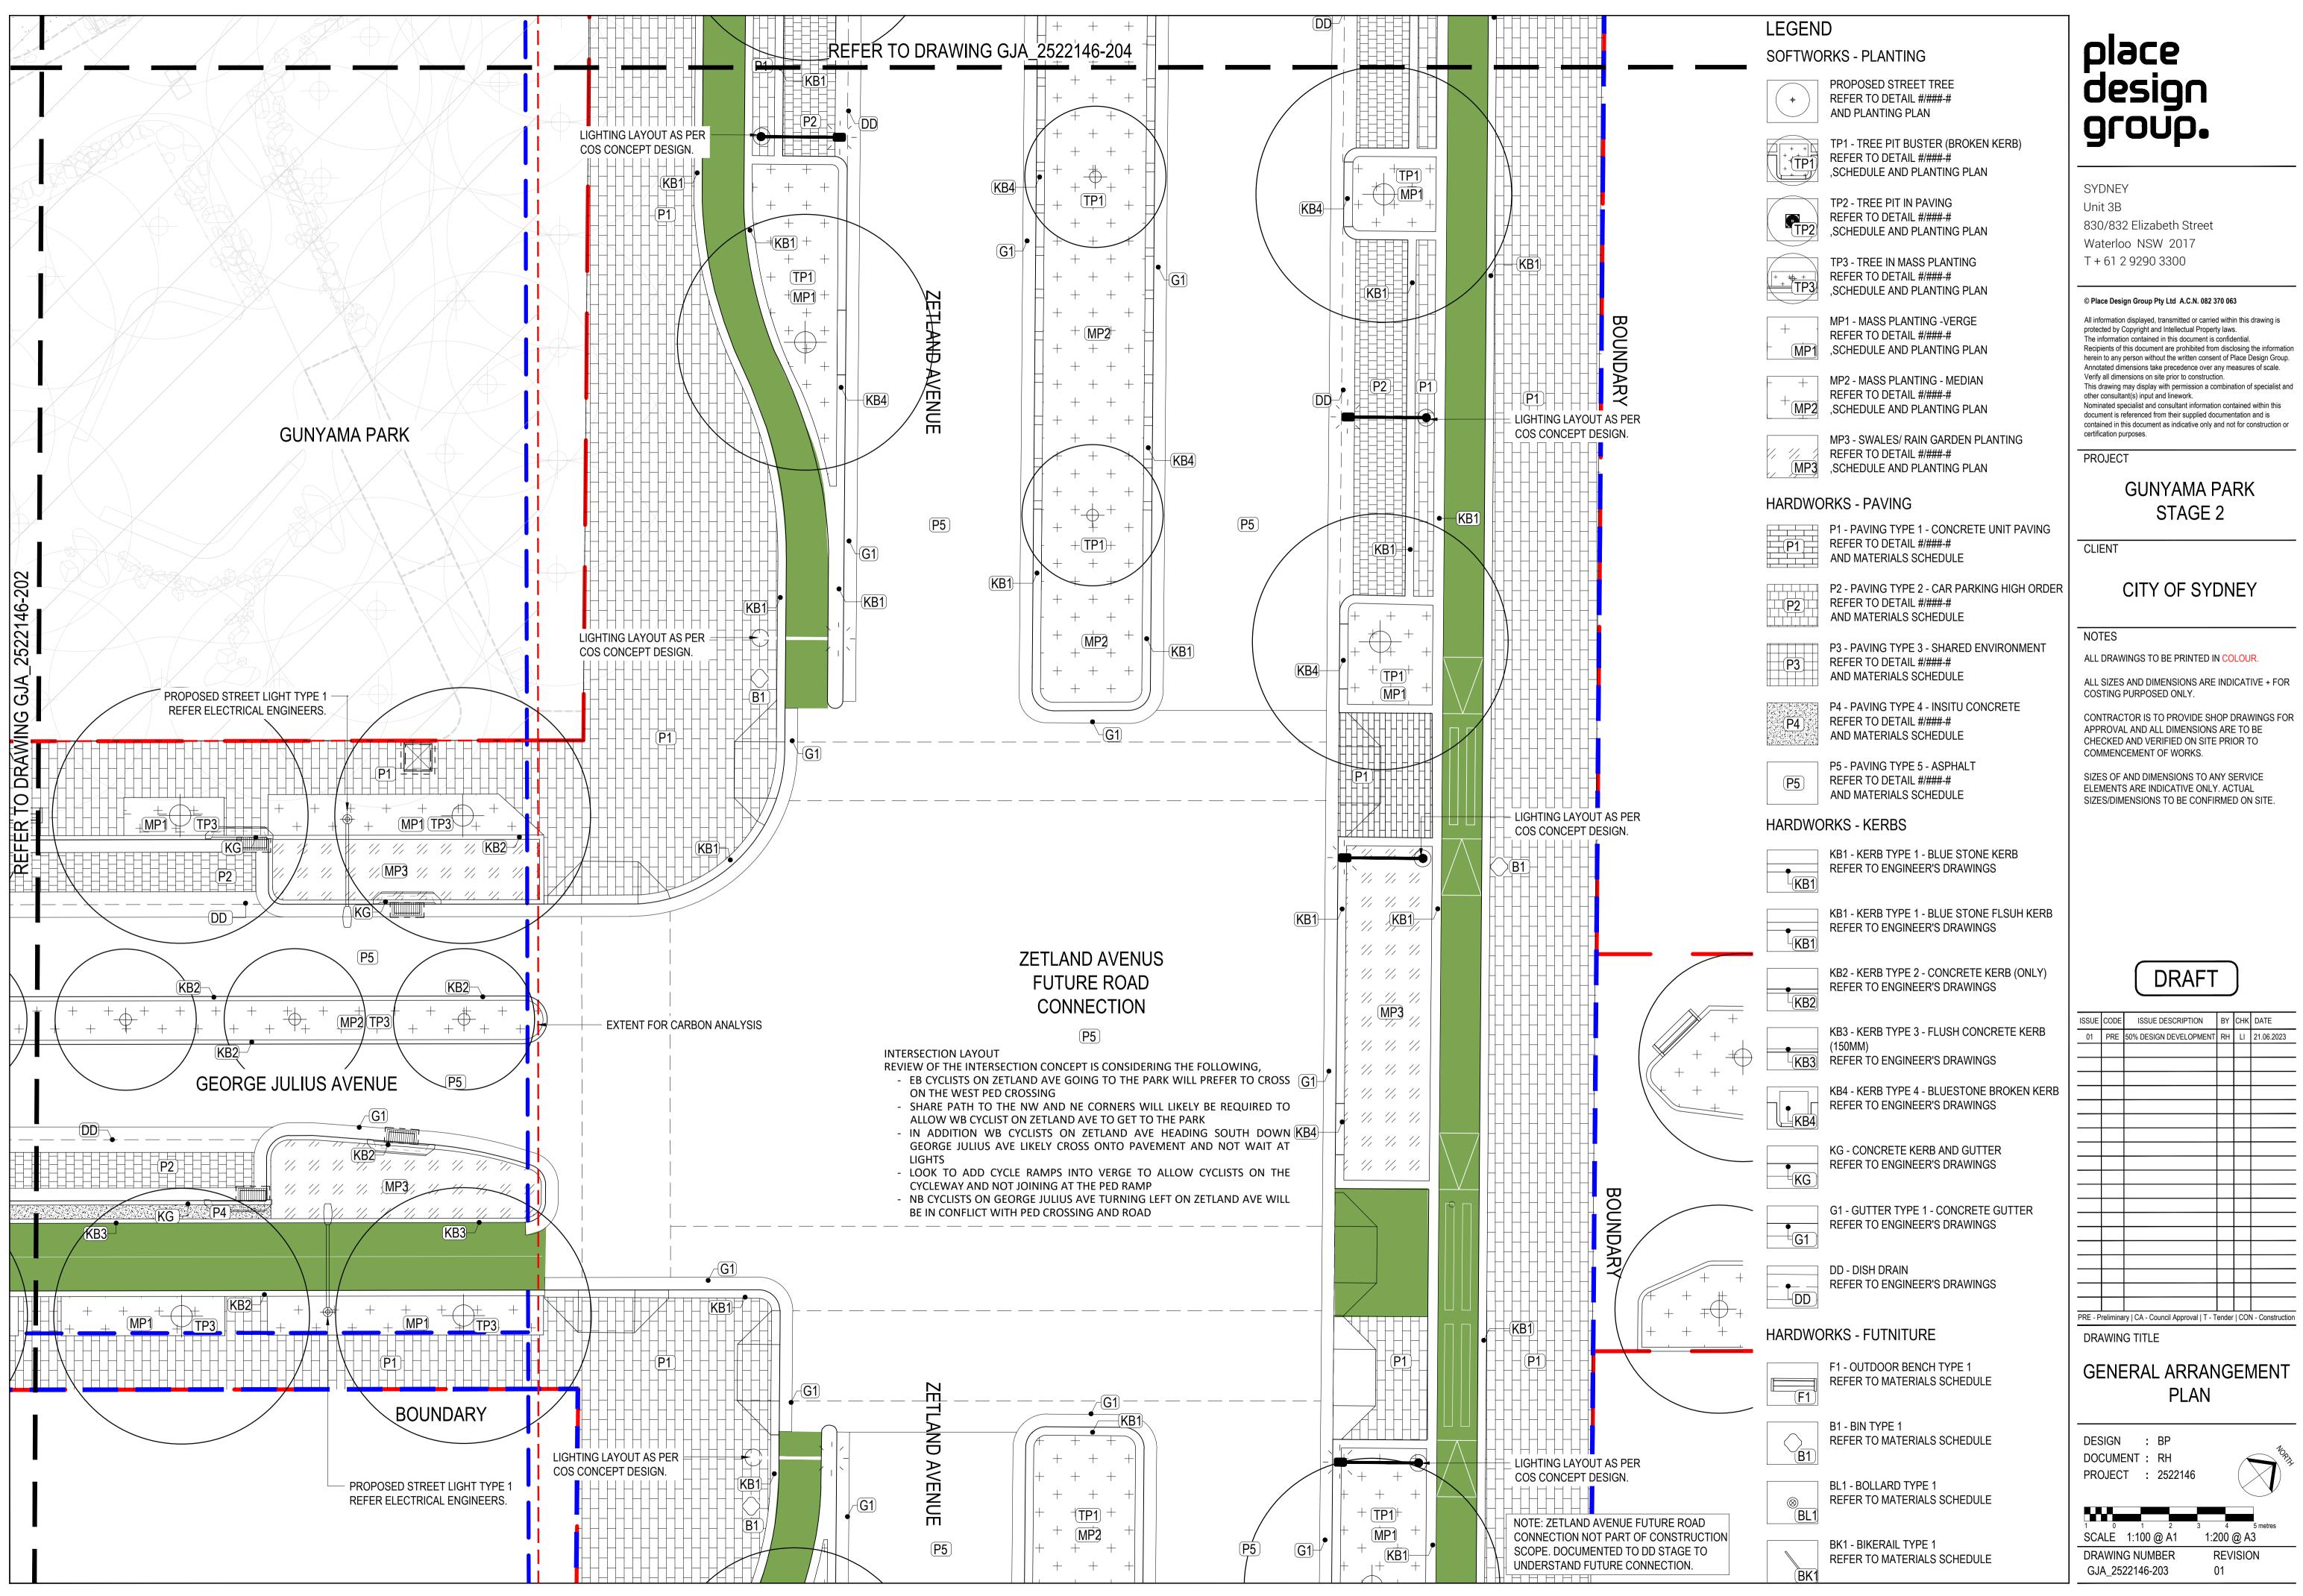
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ISSUE	CODE	ISSUE DESCRIPTION	BY	СНК	DATE
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PRE - P	relimina	I Iry CA - Council Approval T - T	ender	000	N - Construction
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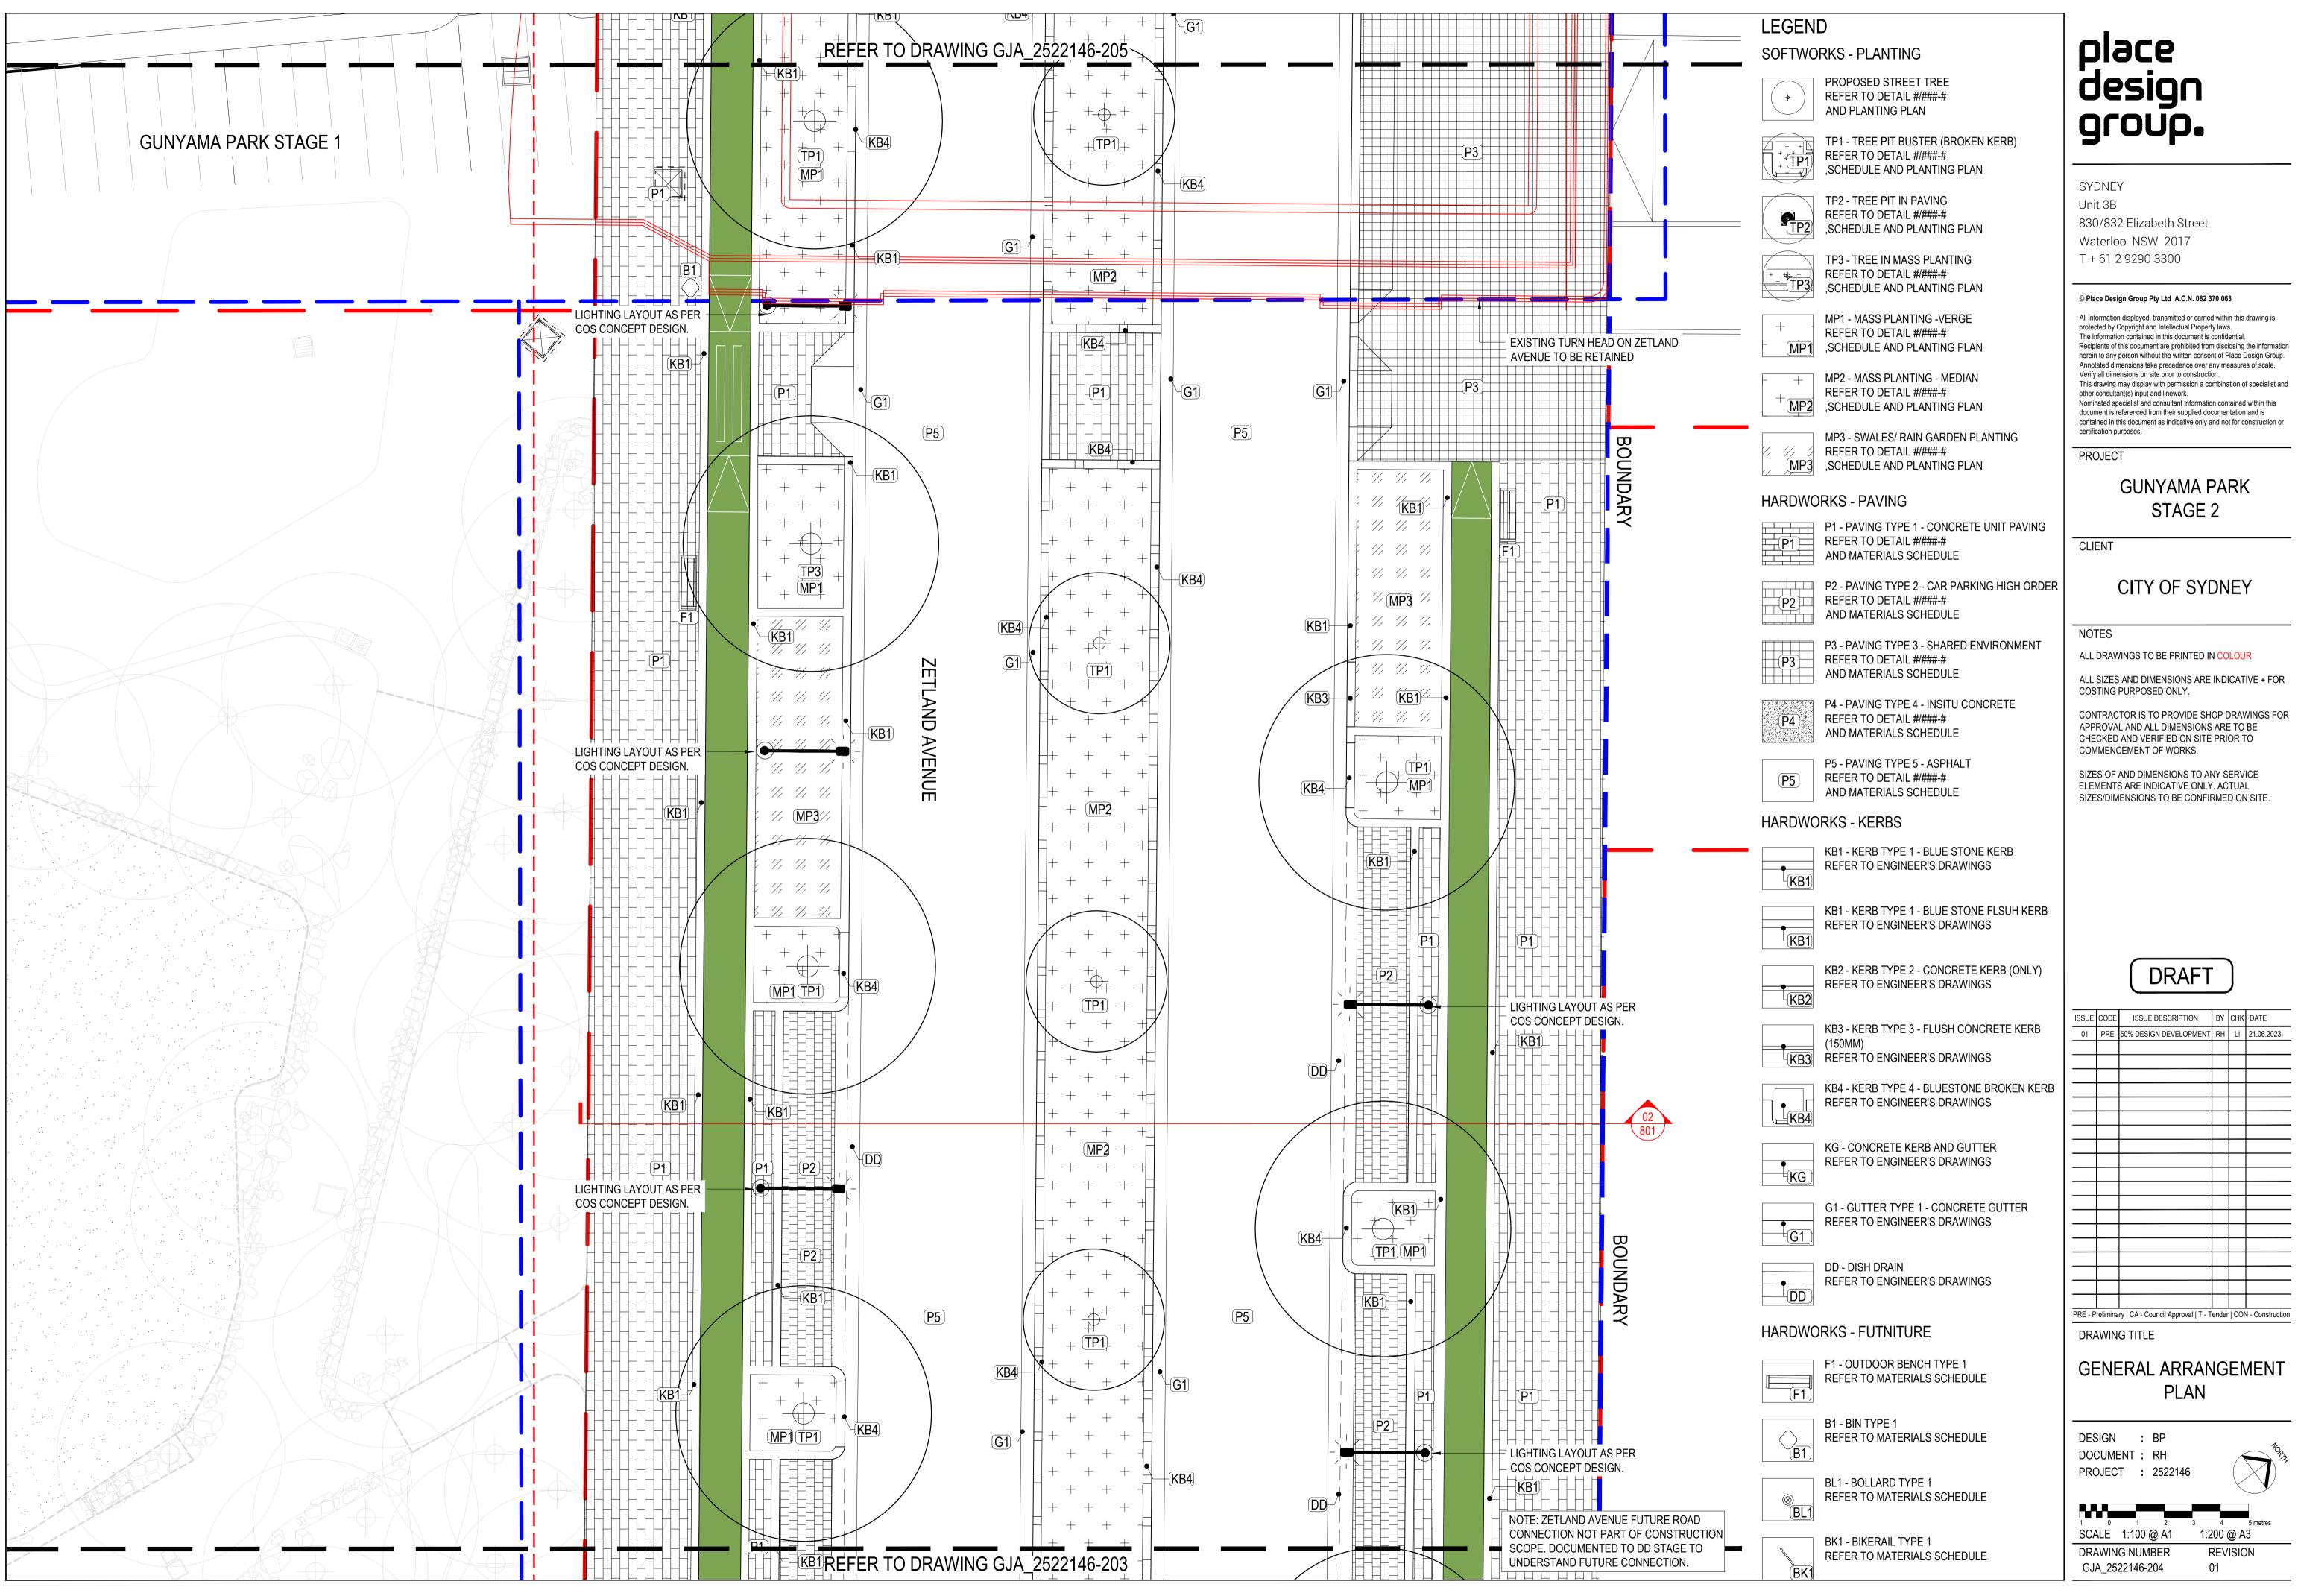
GENERAL ARRANGEMENT PLAN




KB2 - KERB TYPE 2 - CONCRETE KERB (ONLY) REFER TO ENGINEER'S DRAWINGS

KB1 - KERB TYPE 1 - BLUE STONE FLSUH KERB





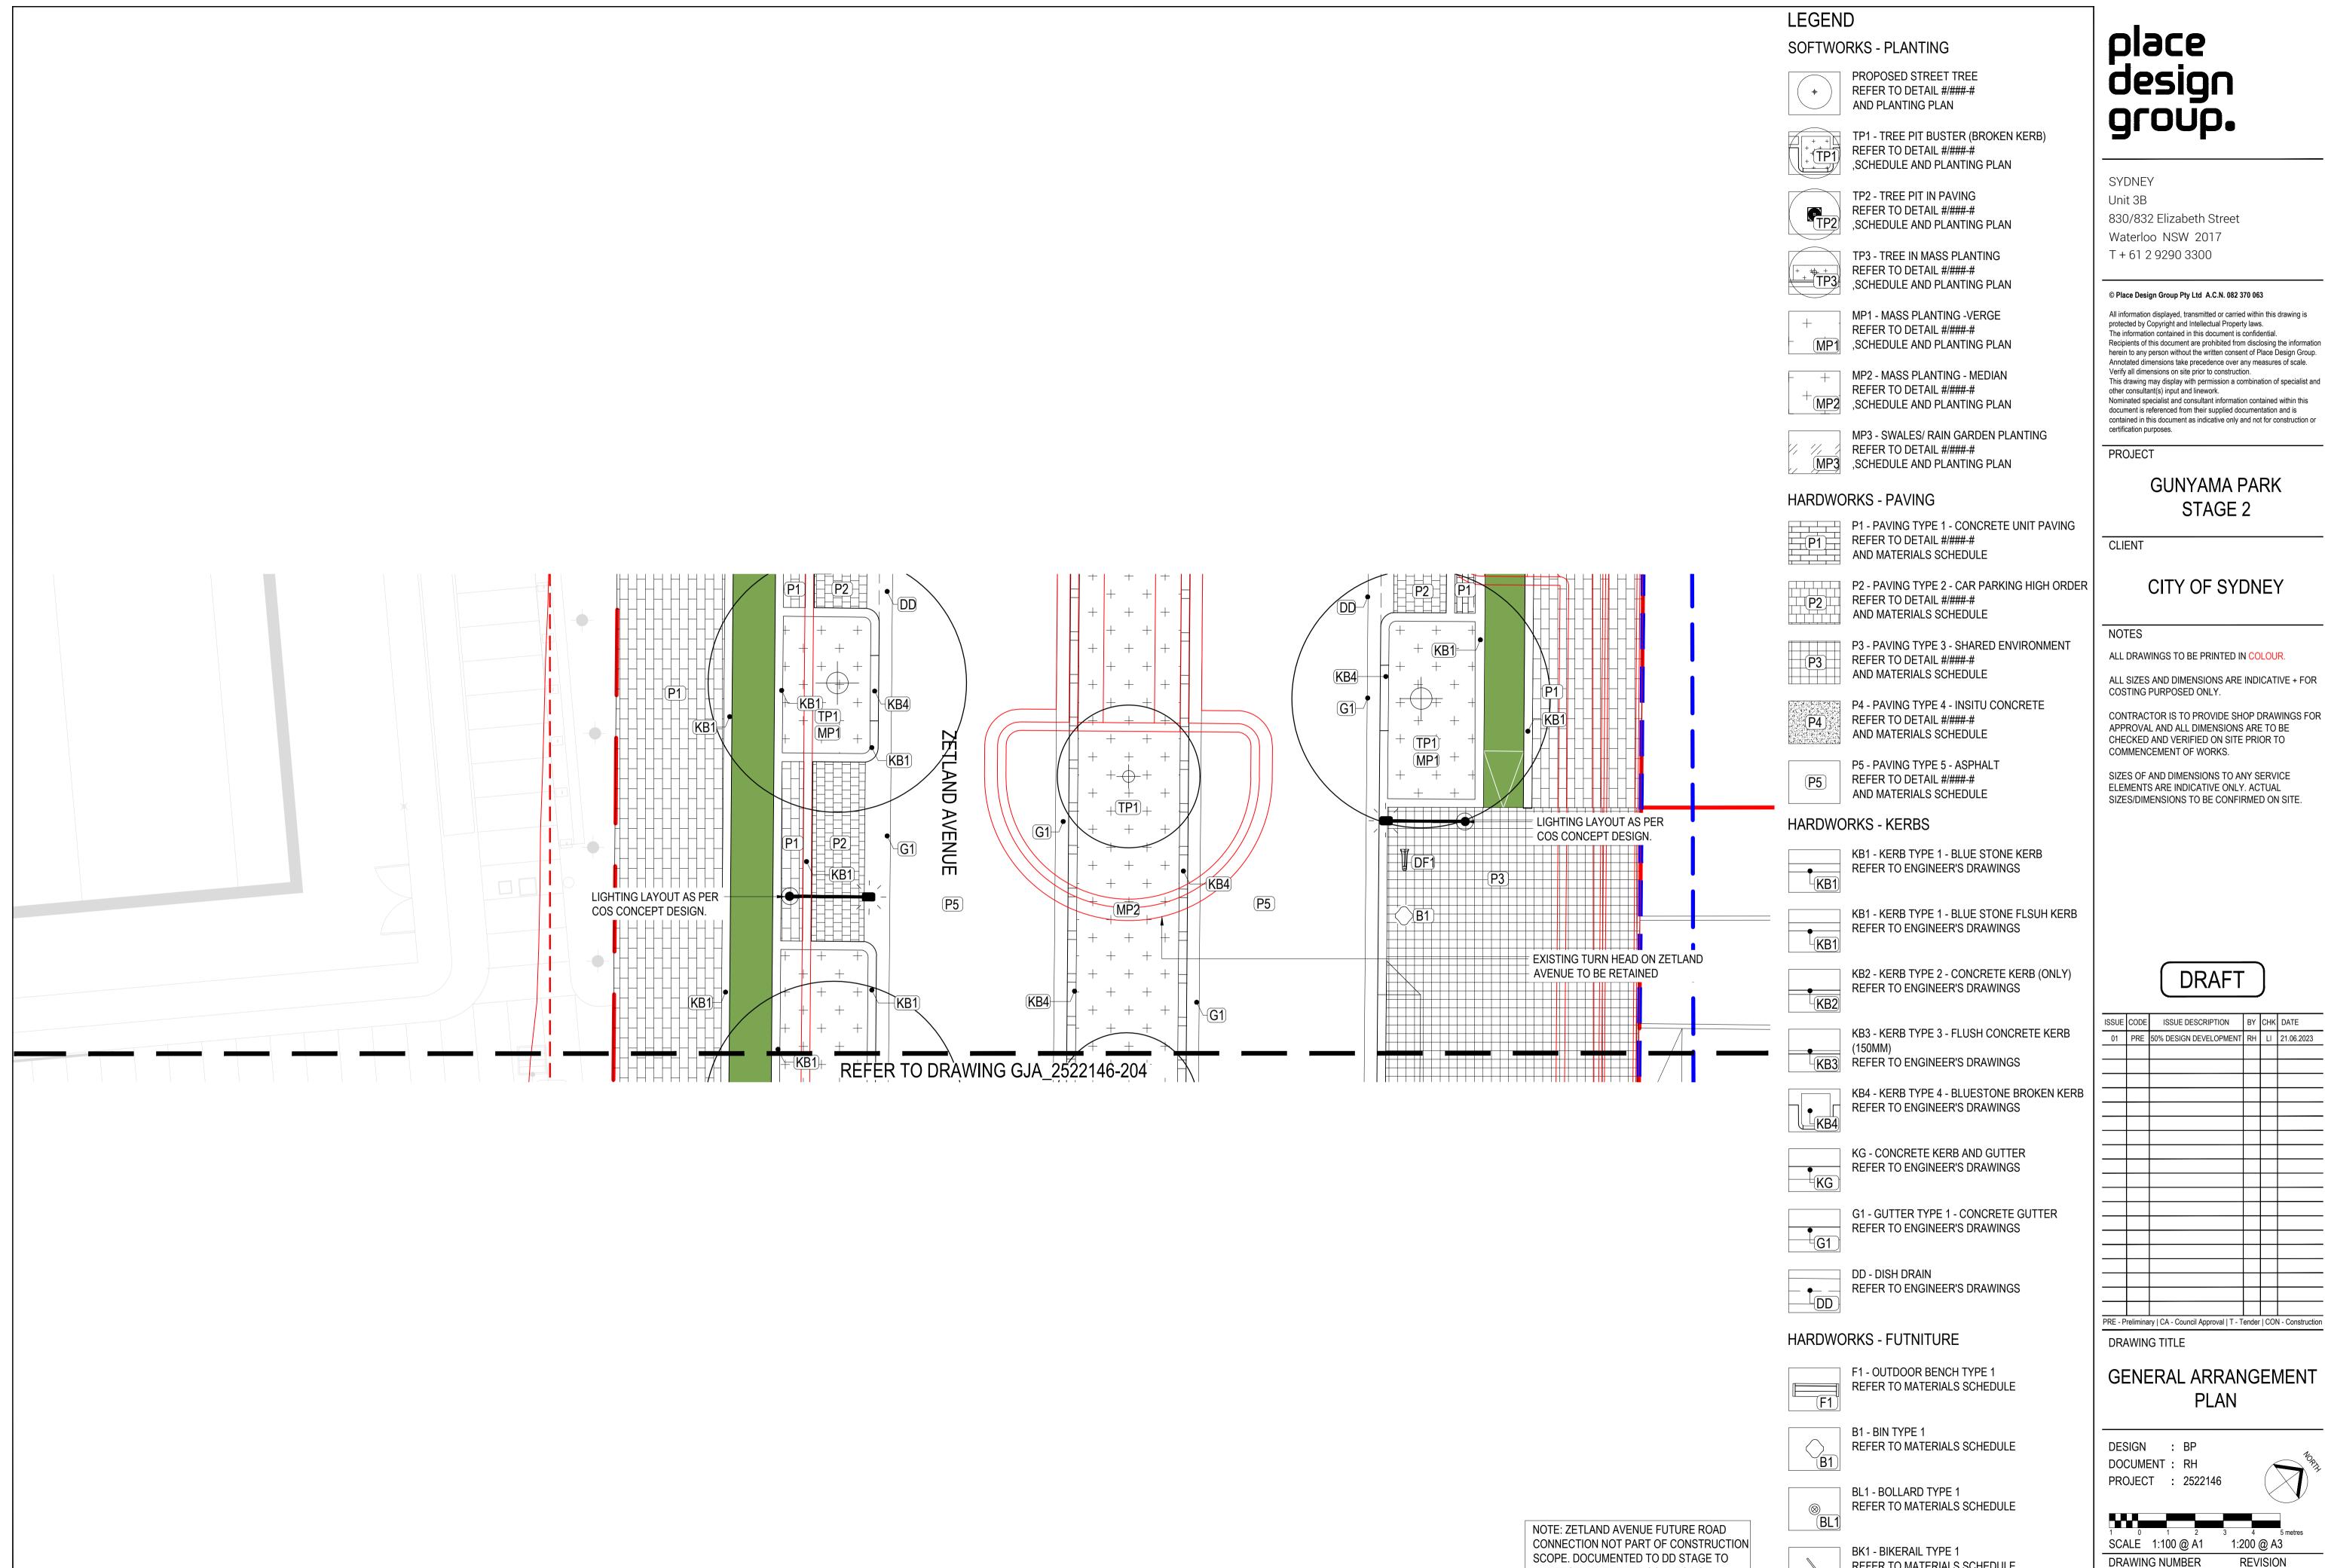


REFER TO MATERIALS SCHEDULE

BK'

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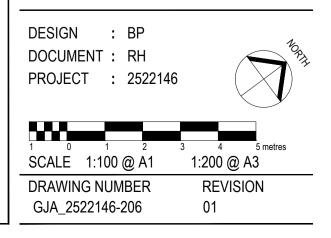
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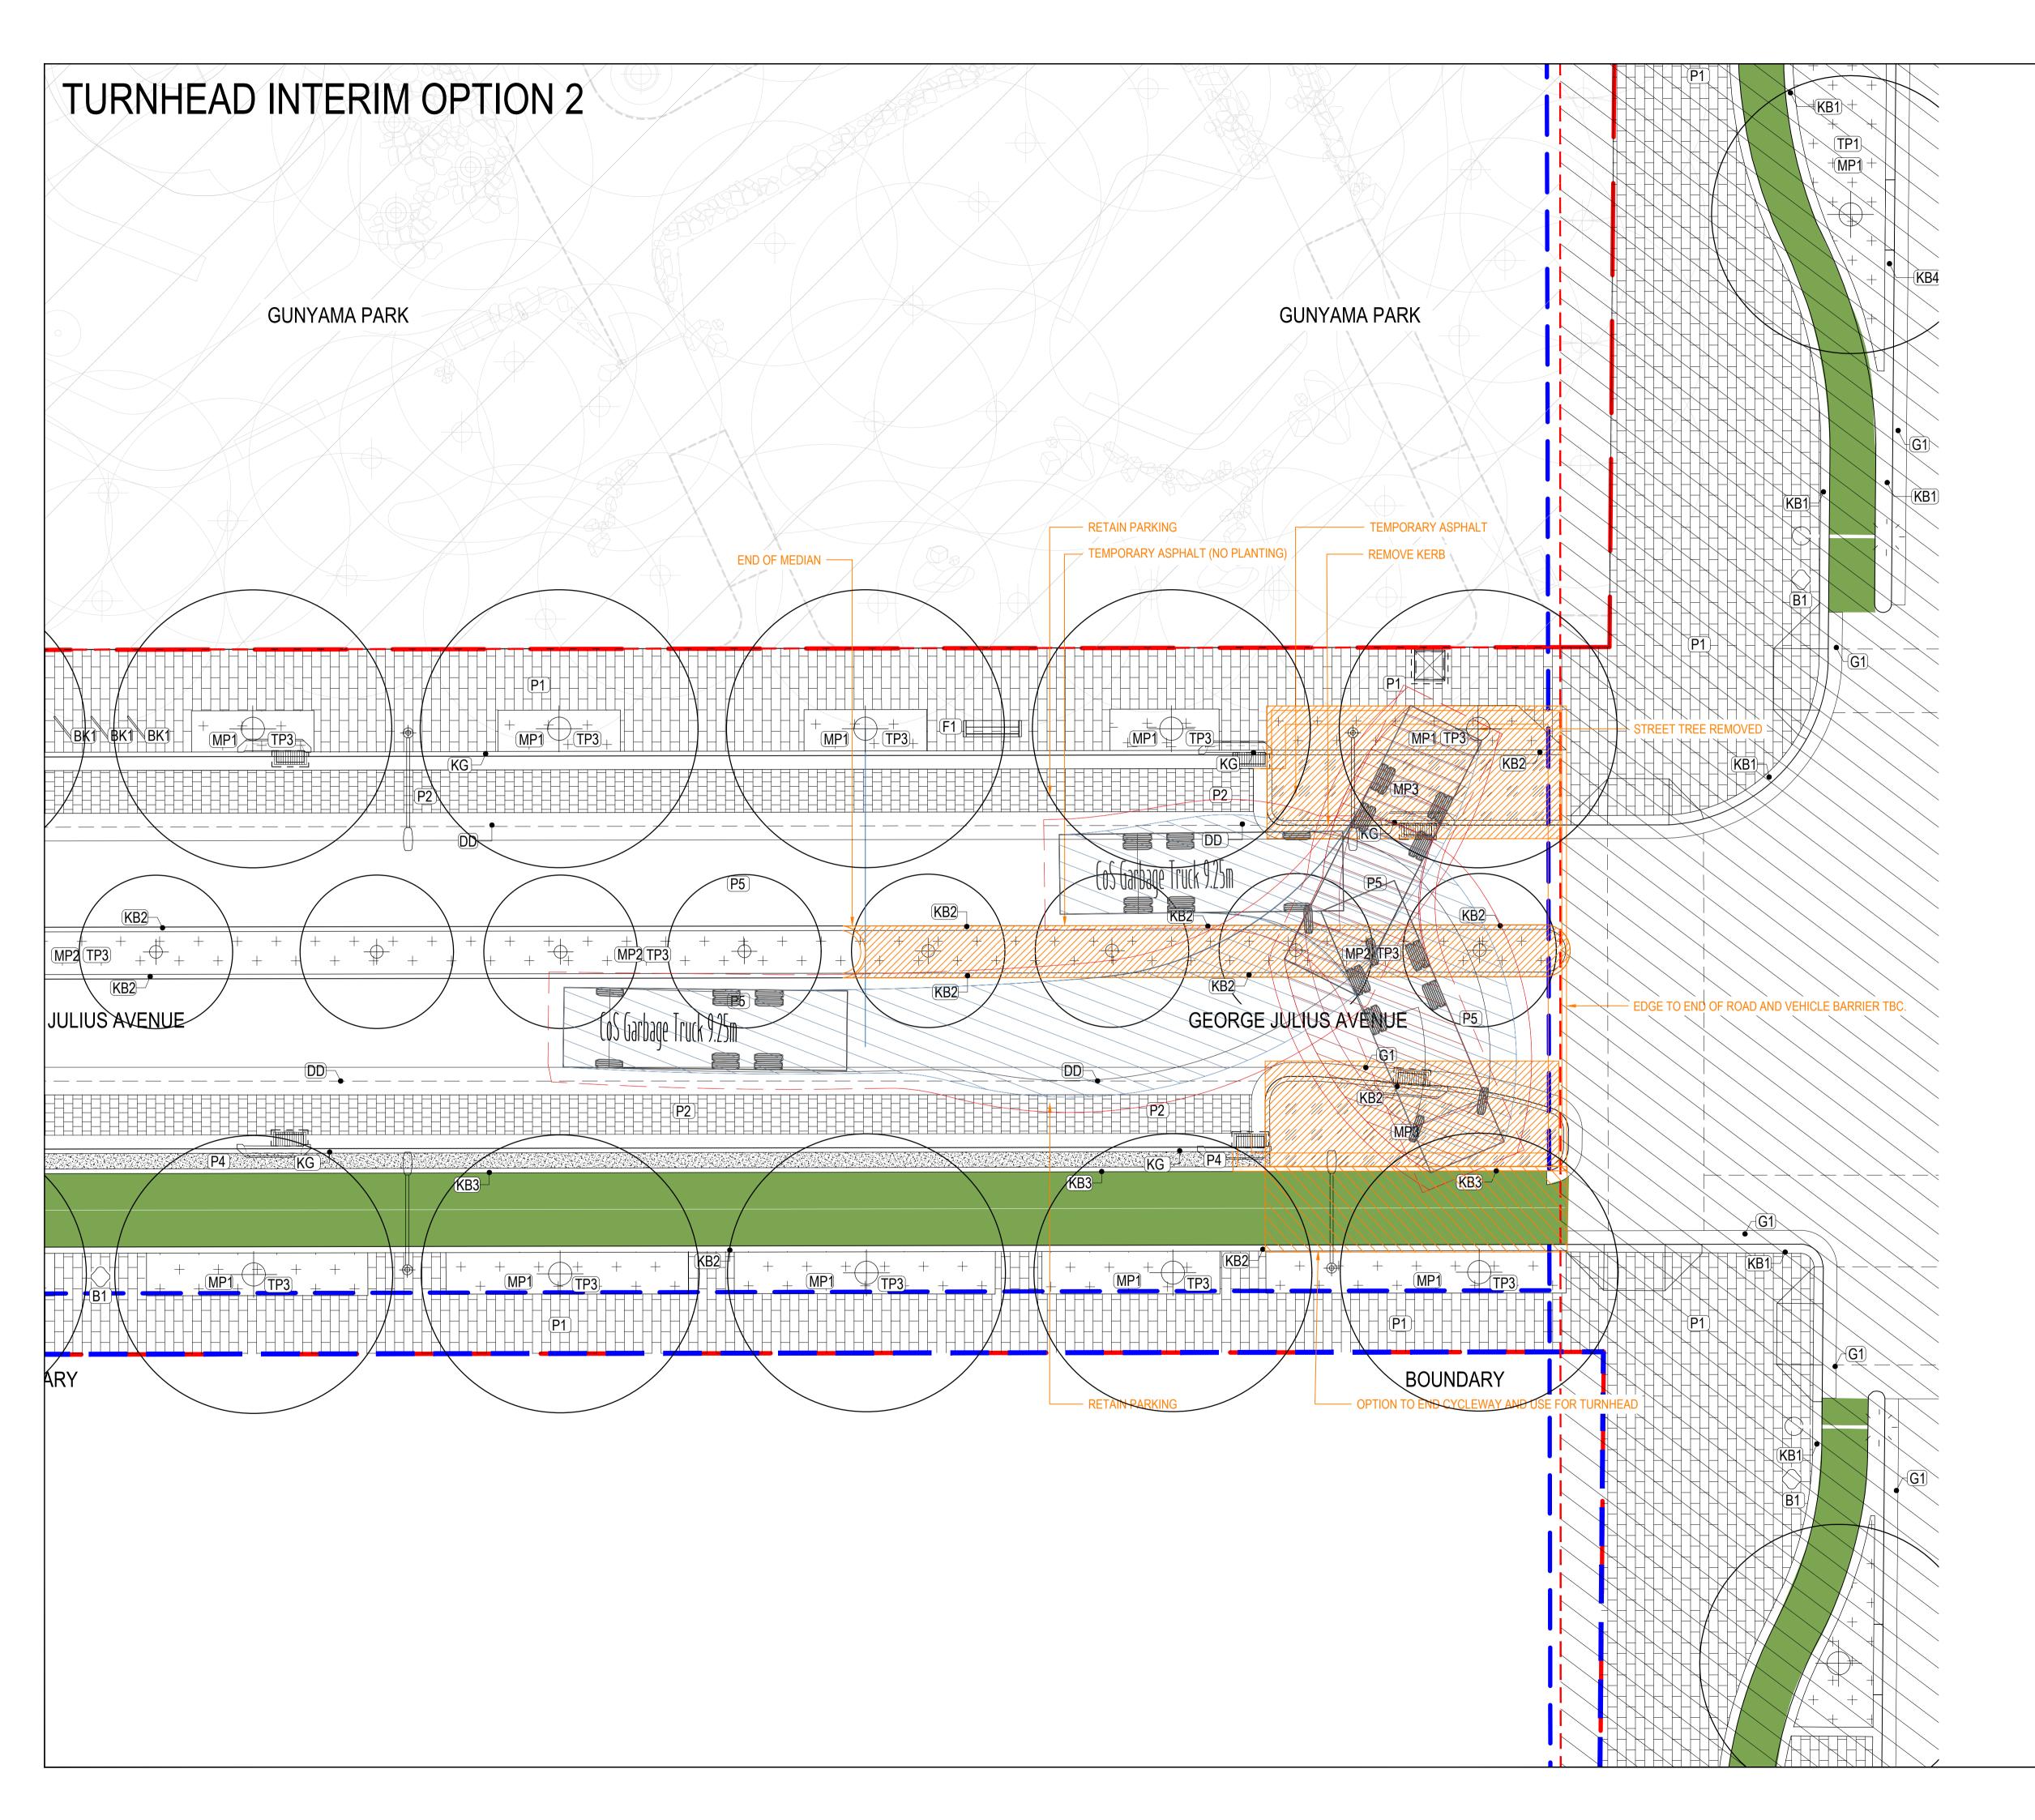
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GENERAL ARRANGEMENT PLAN - INTERIM 1



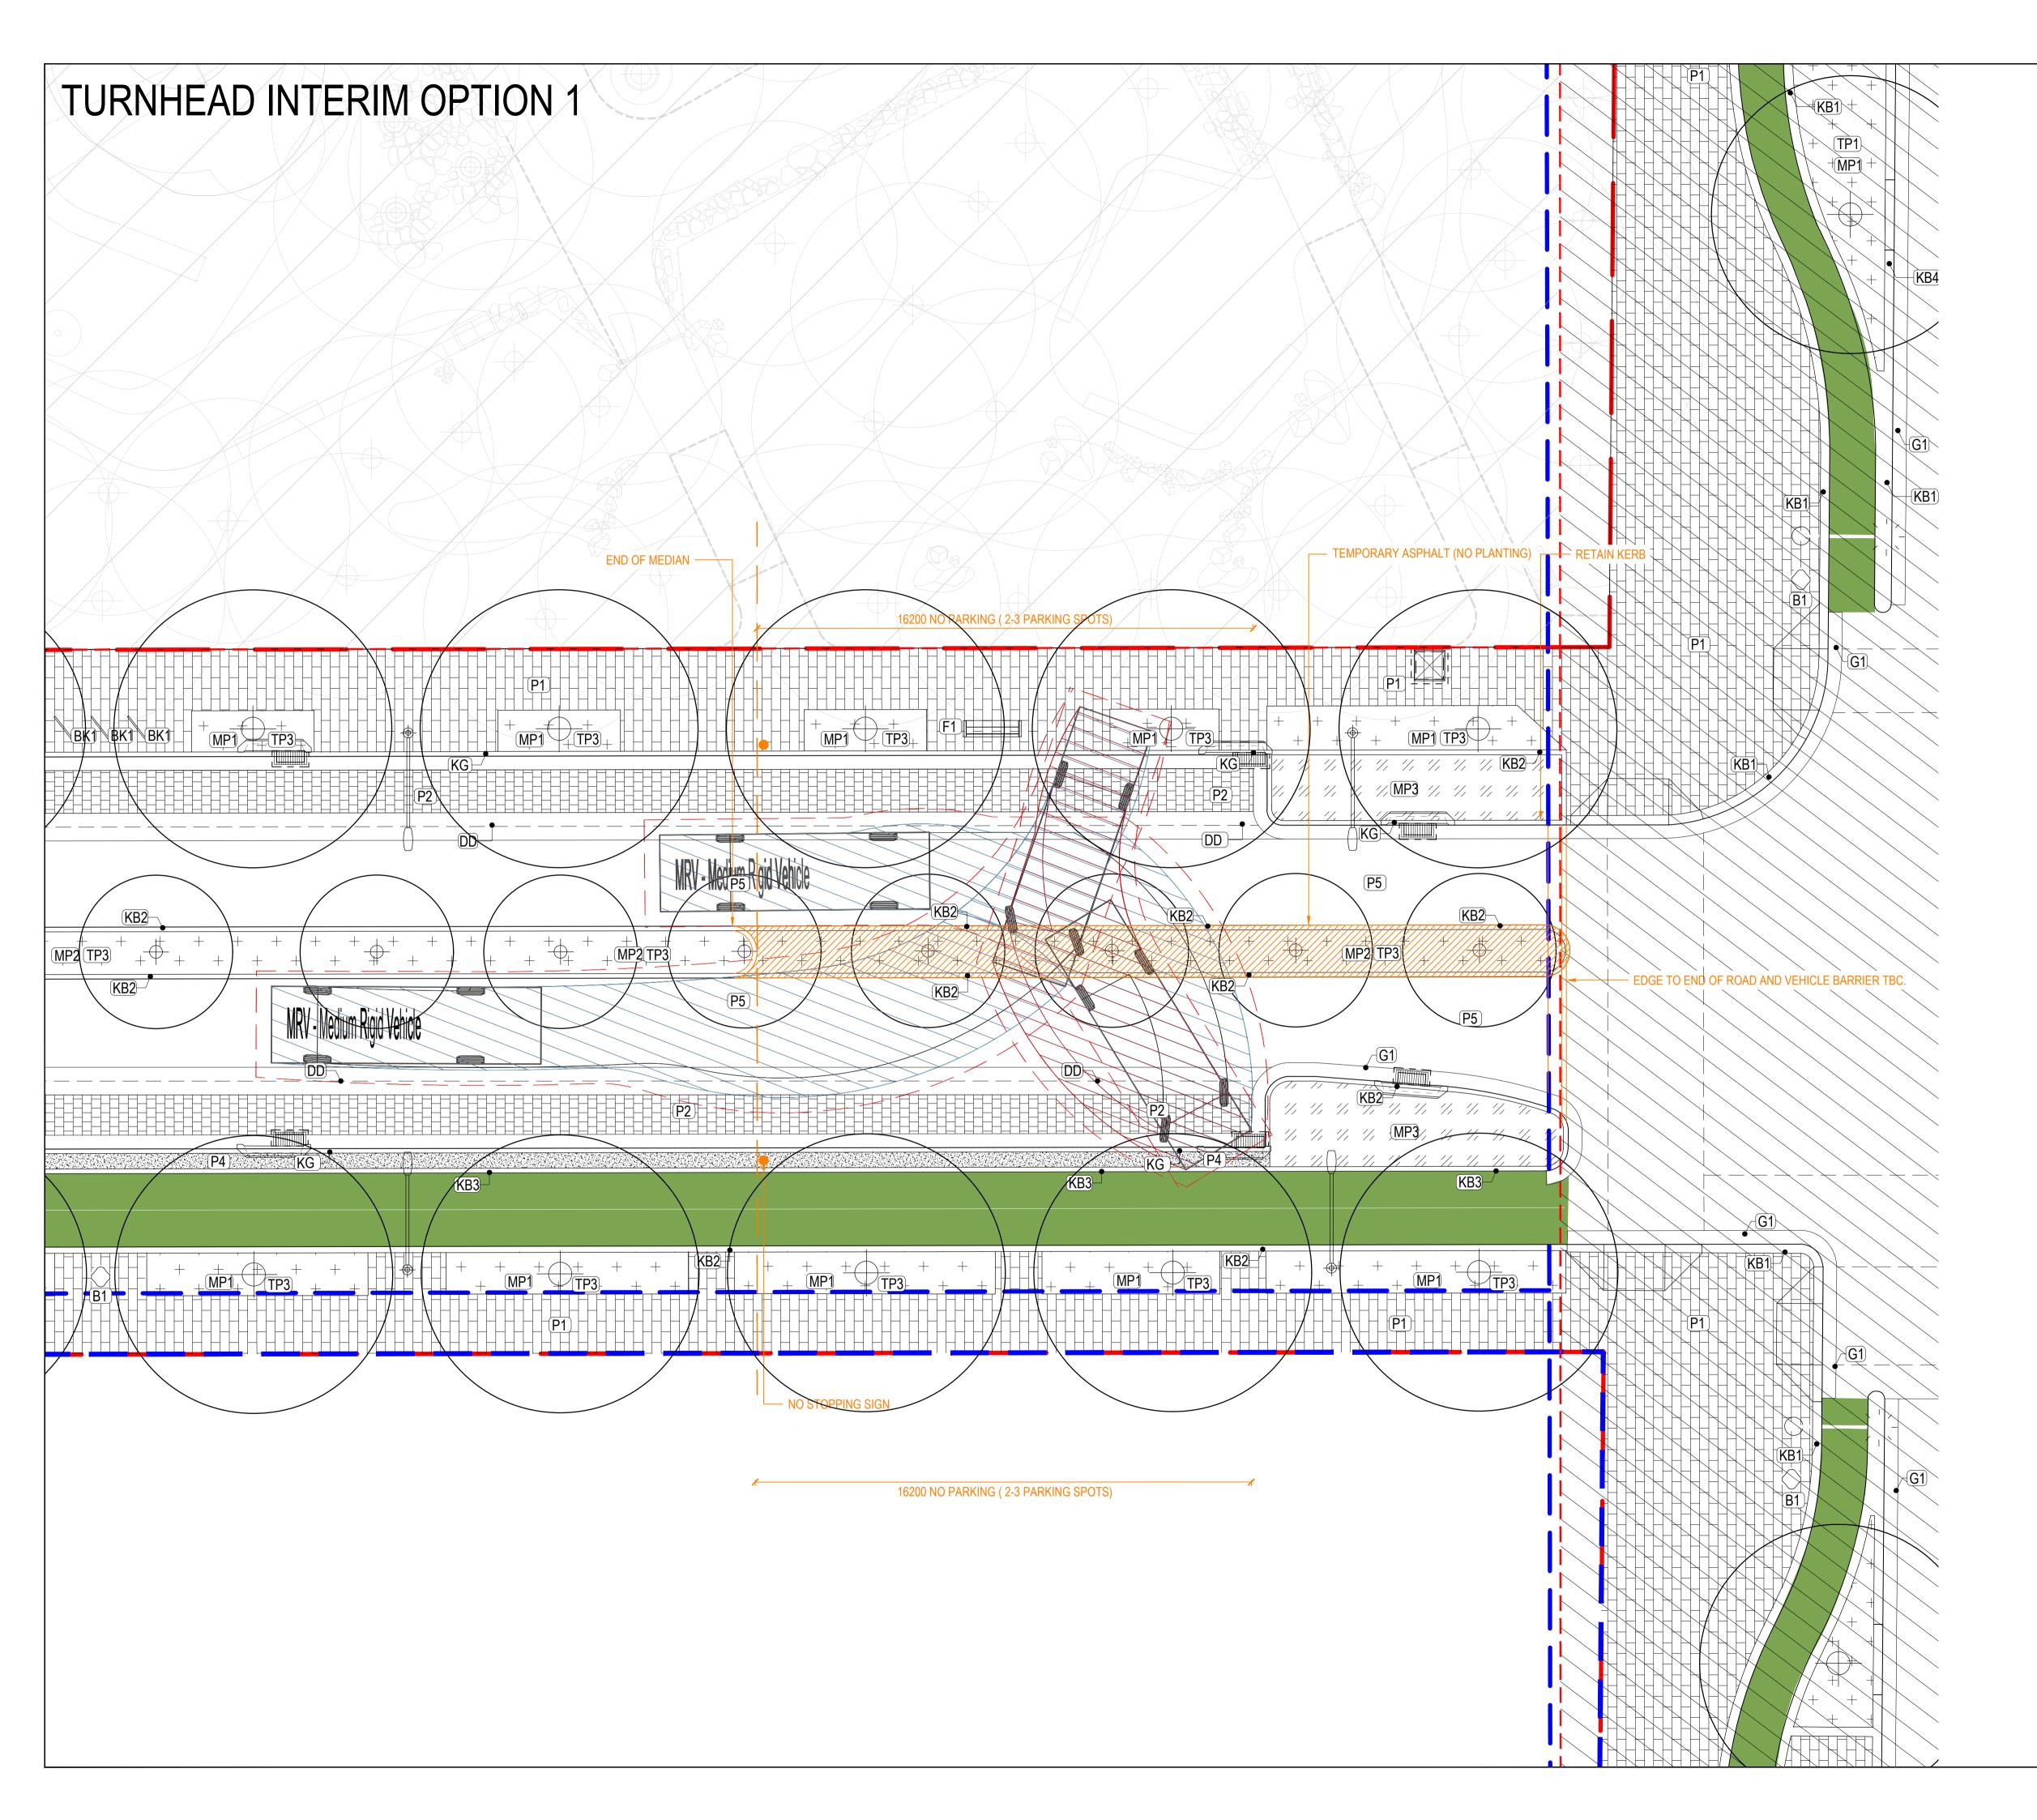

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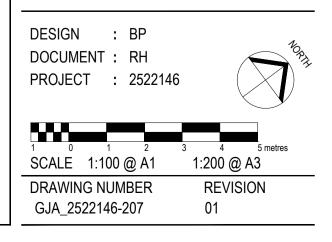
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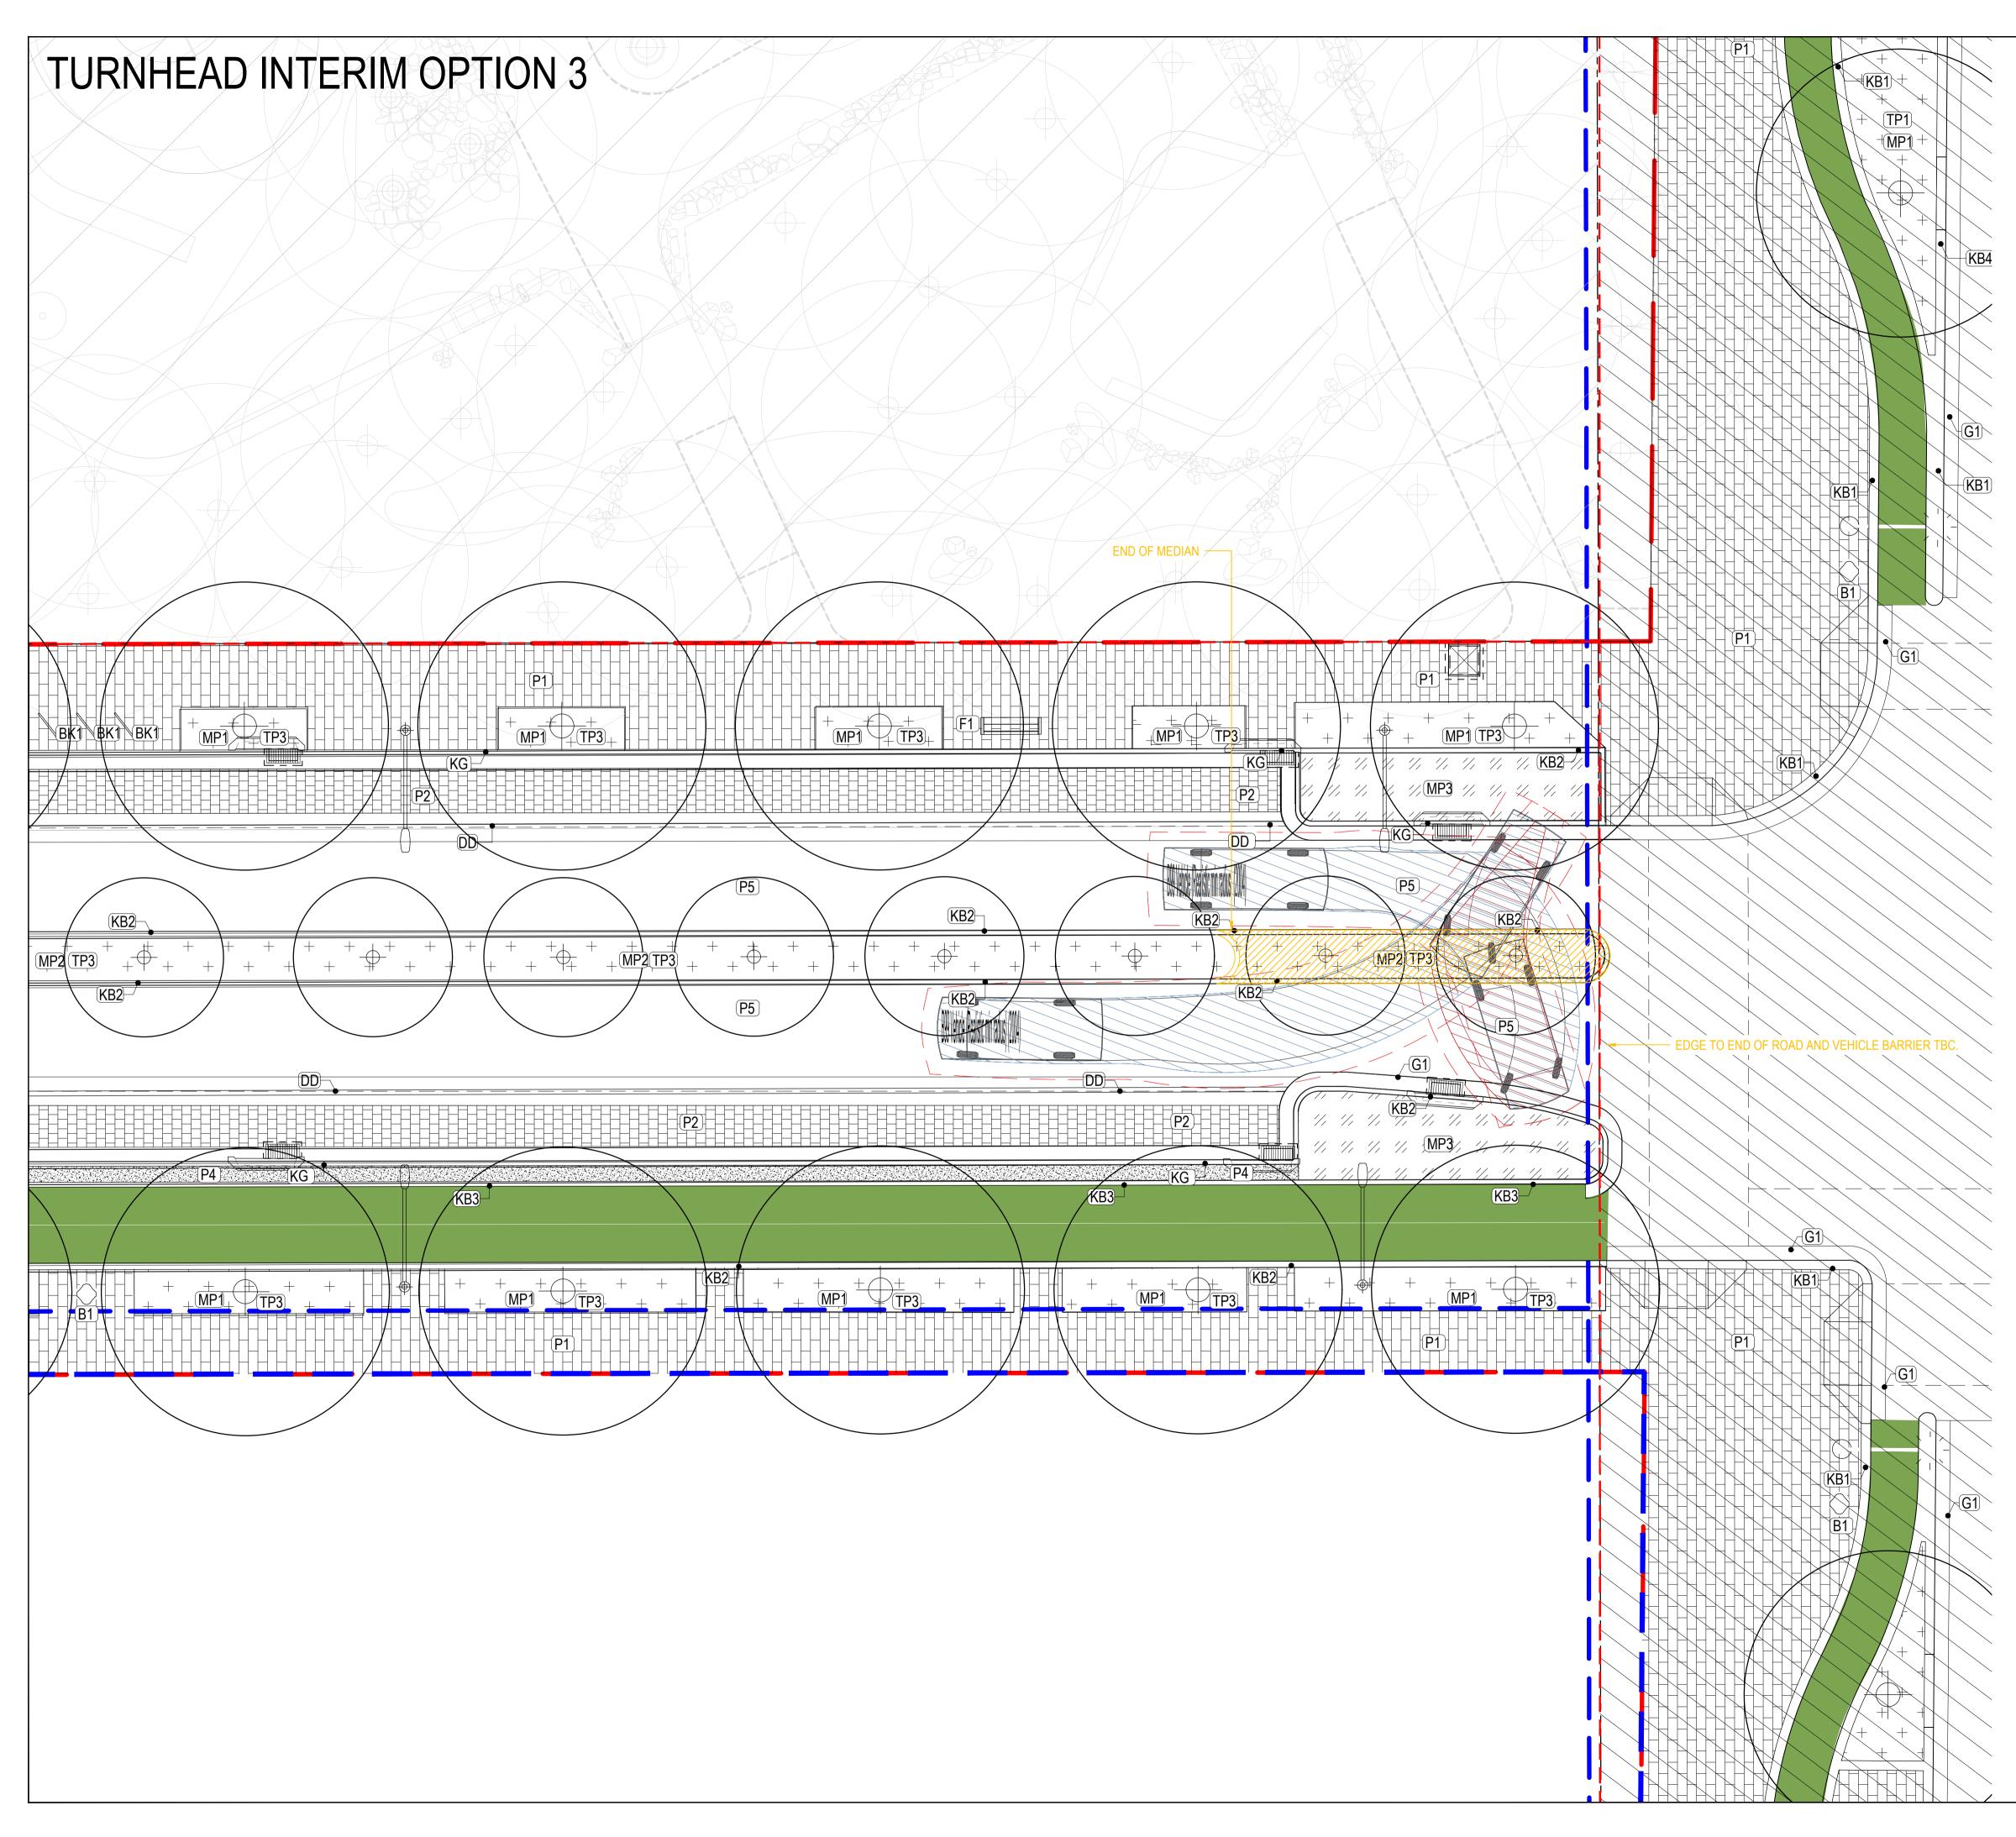
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GENERAL ARRANGEMENT PLAN - INTERIM 2





NOTE:

BAN VEHICLES AT THE PETER ST INTERSECTION GRATER THAN B99, USE OF ADDITIONAL SIGNAGE REQUIRED.

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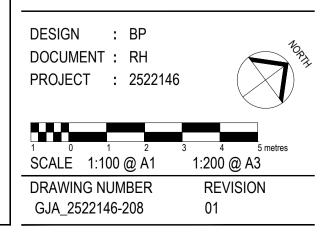
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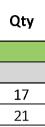
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GENERAL ARRANGEMENT PLAN - INTERIM 3



George Julius Avenue Planting Schedule							
SYM	Botanical Name	Common name	Mature Height X Width (m)	Pot size	Spacing (m ²)	Qty	
	Julius Avenue						
	ED STREET TREES				1		
La	Livistona australis	Cabbage Tree Palm	20 x 6	400L	As Shown	17	
Lt	Liriodendron tulipifera	Tulip Tree	20 x 8	400L	As Shown	21	
PROPOS	ED PLANTING MATRIX A						
<u>РХ</u>	Philodendron 'Xanadu'	Xanadu	1 x 1		4/m2	226	
LEG	Liriope ' Evergreen Giant'	Liriope	0.8 x 0.8	200mm	6/m2	345	
DSS	Dianella 'Silver Streak'	Dianella	0.8 x 0.8	200mm	6/m2	345	
	ED PLANTING MATRIX B						
LV	Lomandra 'Verday'	Lomandra	1.2 x 1.2	200mm	5/m2	237	
	Lomandra 'Lime Tuff'	Lomandra	1.2 x 1.2	200mm	6/m2	285	
NGS	Nandina "Gulf Stream'	Nandina	1 x 1	200mm	4/m2	190	
PROPOS	ED PLANTING MATRIX C (Raingarden)						
Ca	Carex appressa	Tall Sedge	0.8 x 0.5	150mm	5/m2	36	
СаВ	Dianella caerulea 'Breeze'	Native Flax	0.7 x 0.7	150mm	5/m2	36	
-n	Ficinia nodosa	Knotted Club-Rush	1 x 1	150mm	5/m2	36	
Ga	Gahnia aspera	Rough Saw-Sedge	0.8 x 0.5	150mm	5/m2	36	
lu	Juncus usitatus	Common Rush	1 x 1	150mm	5/m2	36	
LIT	Lomandra longifolia 'Tanika'	Mat Rush	1 x 1	150mm	5/m2	36	
Zetland	Avenue						
PROPOS	ED STREET TREES						
Ar	Agathis robusta	Kauri Pine	6 x 5	400L	As Shown	7	
Zs	Zelkova serrata 'Green Vase'	Green Vase Japanese Elm	14 x 10	400L	As Shown	12	
PROPOS	ED PLANTING MATRIX A						
PX	Philodendron 'Xanadu'	Xanadu	1 x 1	200mm	4/m2	202	
LEG	Liriope ' Evergreen Giant'	Liriope	0.8 × 0.8	200mm	6/m2	321	
DSS	Dianella 'Silver Streak'	Dianella	0.8 x 0.8	200mm	6/m2	321	
	ED PLANTING MATRIX B						
.V	Lomandra 'Verday'	Lomandra	1.2 x 1.2	200mm	5/m2	508	
LLT	Lomandra 'Lime Tuff'	Lomandra	1.2 x 1.2	200mm	6/m2	610	
NGS	Nandina "Gulf Stream'	Nandina	1 x 1	200mm	4/m2	406	
PROPOS	ED PLANTING MATRIX C (Raingarden)						
Ca	Carex appressa	Tall Sedge	0.8 x 0.5	150mm	5/m2	80	
СаВ	Dianella caerulea 'Breeze'	Native Flax	0.7 x 0.7	150mm	5/m2	80	
Fn	Ficinia nodosa	Knotted Club-Rush	1 x 1	150mm	5/m2	80	
Ga	Gahnia aspera	Rough Saw-Sedge	0.8 x 0.5	150mm	5/m2	80	
lu	Juncus usitatus	Common Rush	1 x 1	150mm	5/m2	80	
	Lomandra longifolia 'Tanika'	Mat Rush	1 x 1	150mm	5/m2	80	



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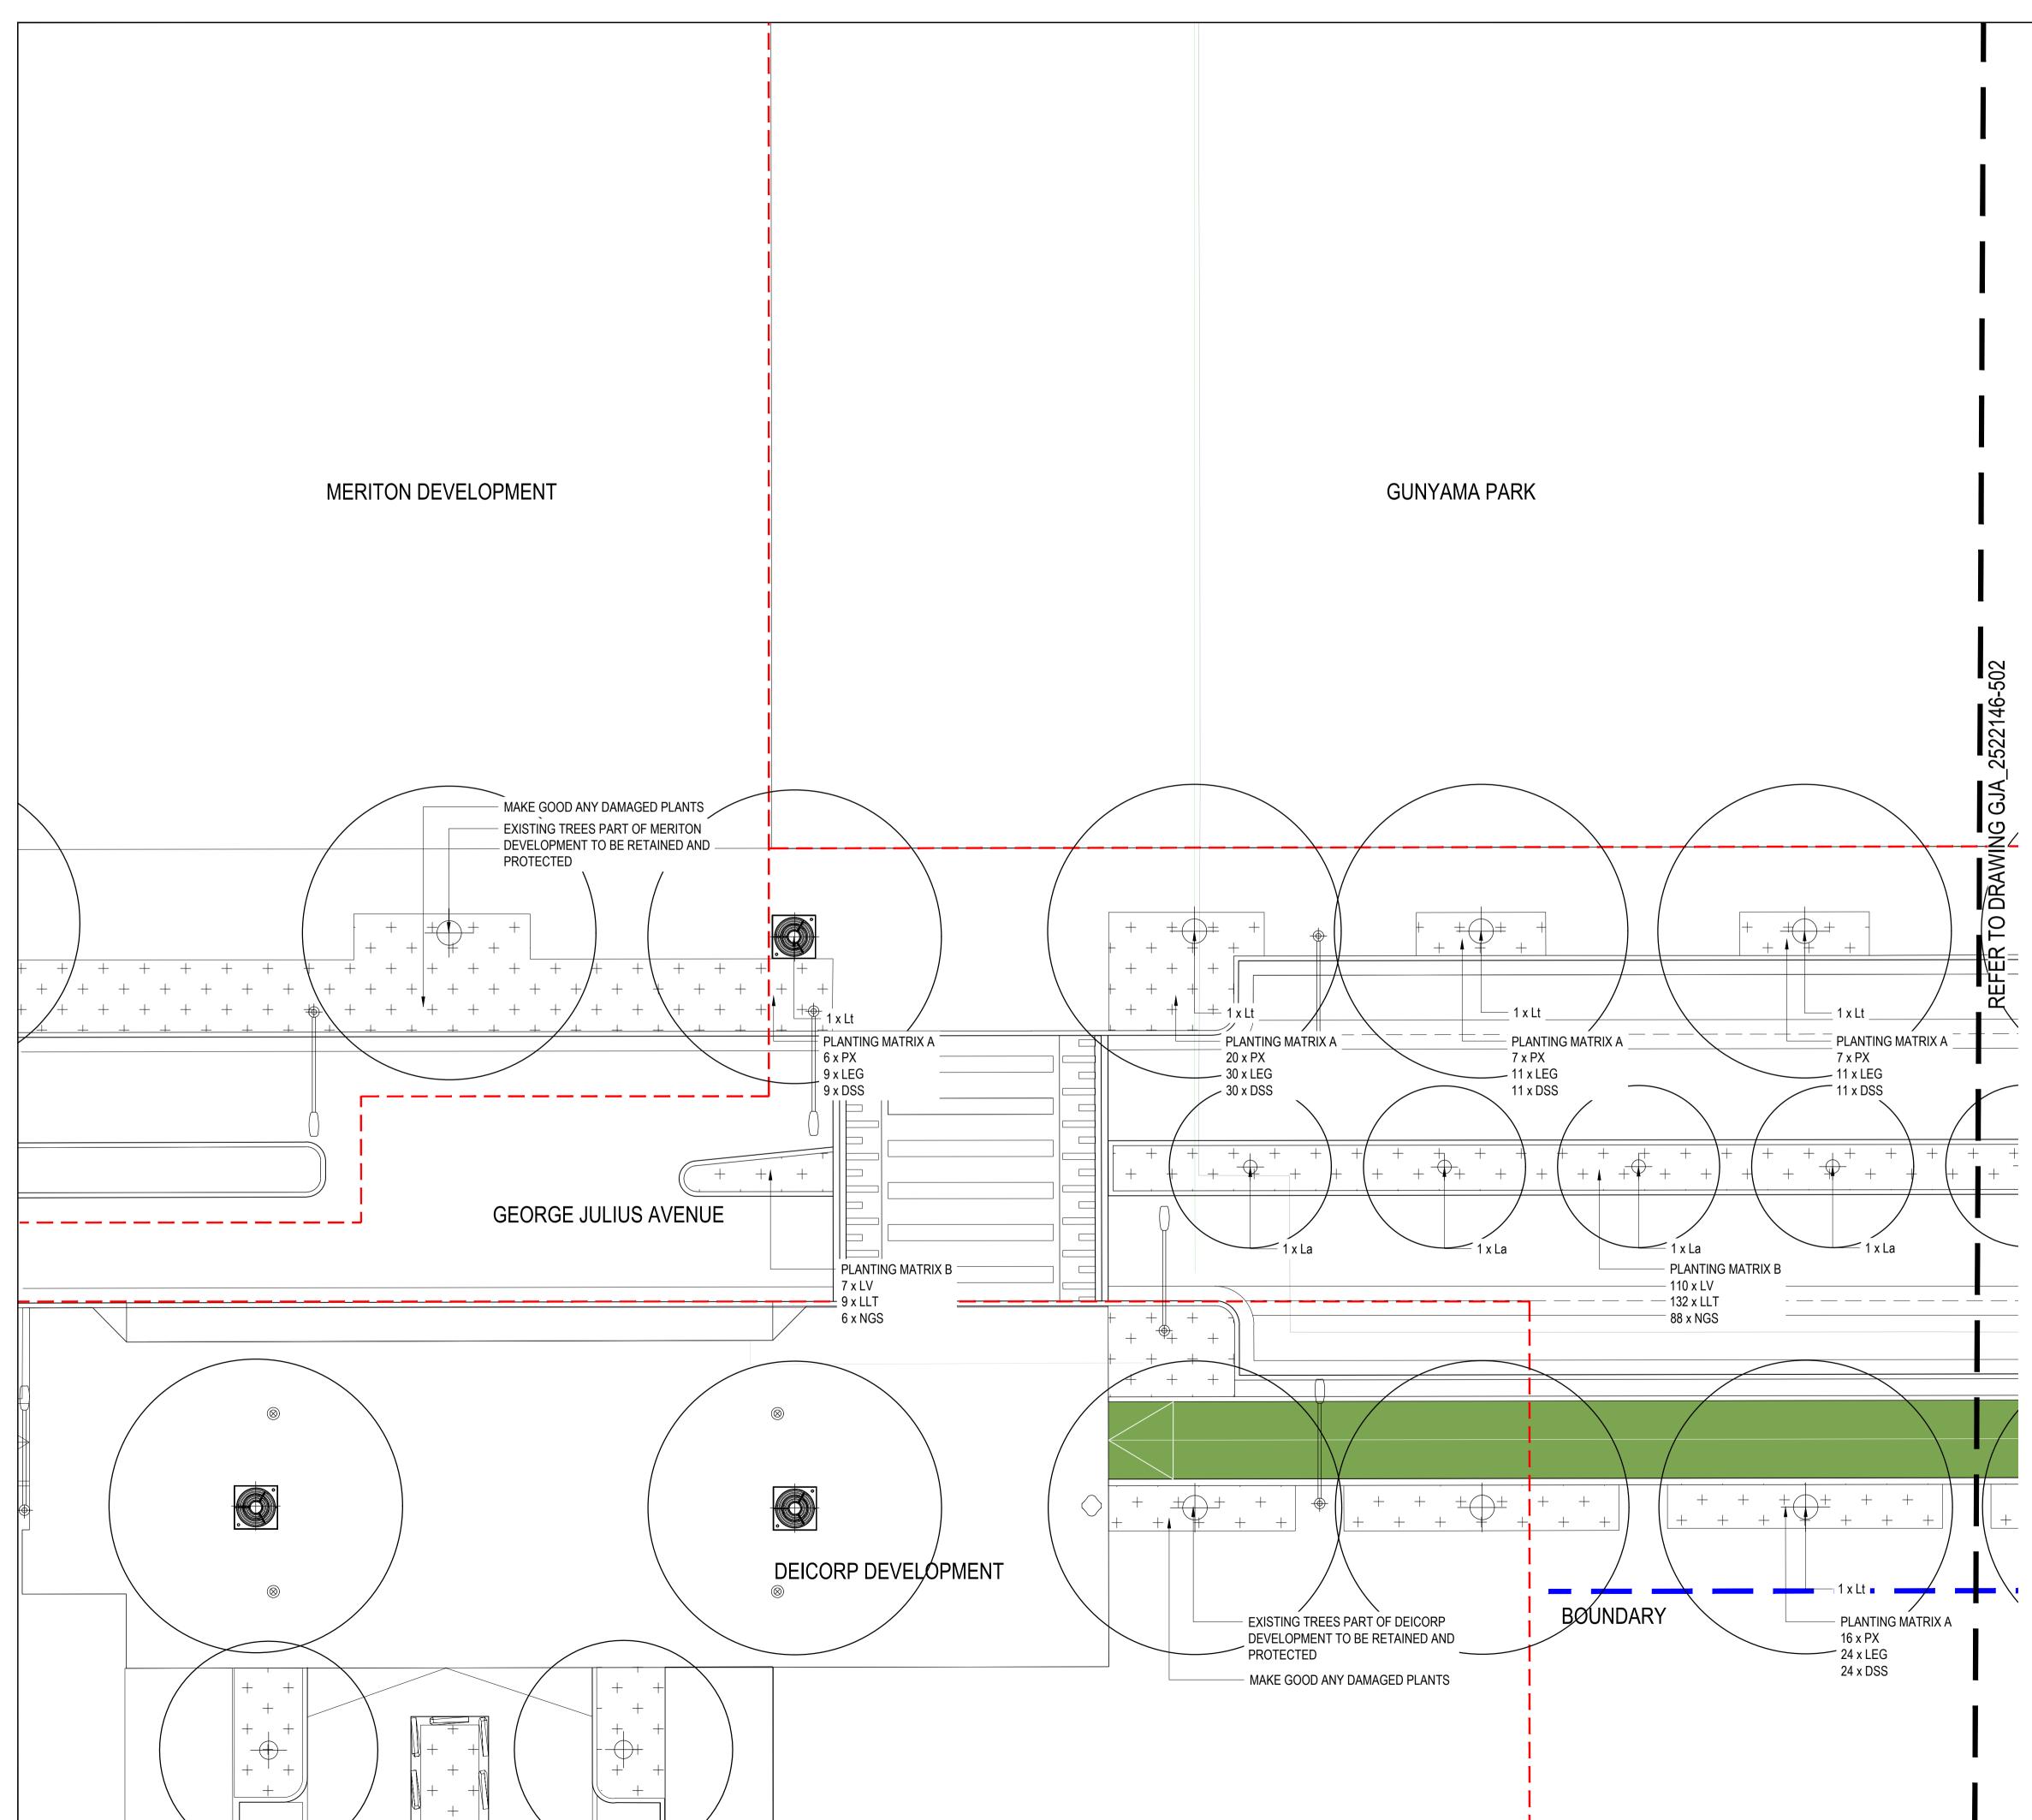
DRAWING TITLE

PLANTING SCHEDULE


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LEGEND SOFTWORKS - PLANTING



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PROPOSED STREET TREE REFER TO DETAIL #/###-# AND PLANTING PLAN

TP1 - TREE PIT BUSTER (BROKEN KERB) REFER TO DETAIL #/###-# ,SCHEDULE AND PLANTING PLAN

TP2 - TREE PIT IN PAVING REFER TO DETAIL #/###-# ,SCHEDULE AND PLANTING PLAN

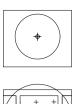TP3 - TREE IN MASS PLANTING REFER TO DETAIL #/###-# ,SCHEDULE AND PLANTING PLAN

MP1 - MASS PLANTING -VERGE REFER TO DETAIL #/###-# ,SCHEDULE AND PLANTING PLAN

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MP2 - MASS PLANTING - MEDIAN REFER TO DETAIL #/###-# ,SCHEDULE AND PLANTING PLAN

MP3 - SWALES/ RAIN GARDEN PLANTING REFER TO DETAIL #/###-# ,SCHEDULE AND PLANTING PLAN

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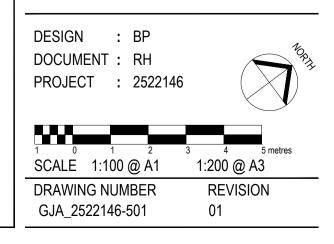
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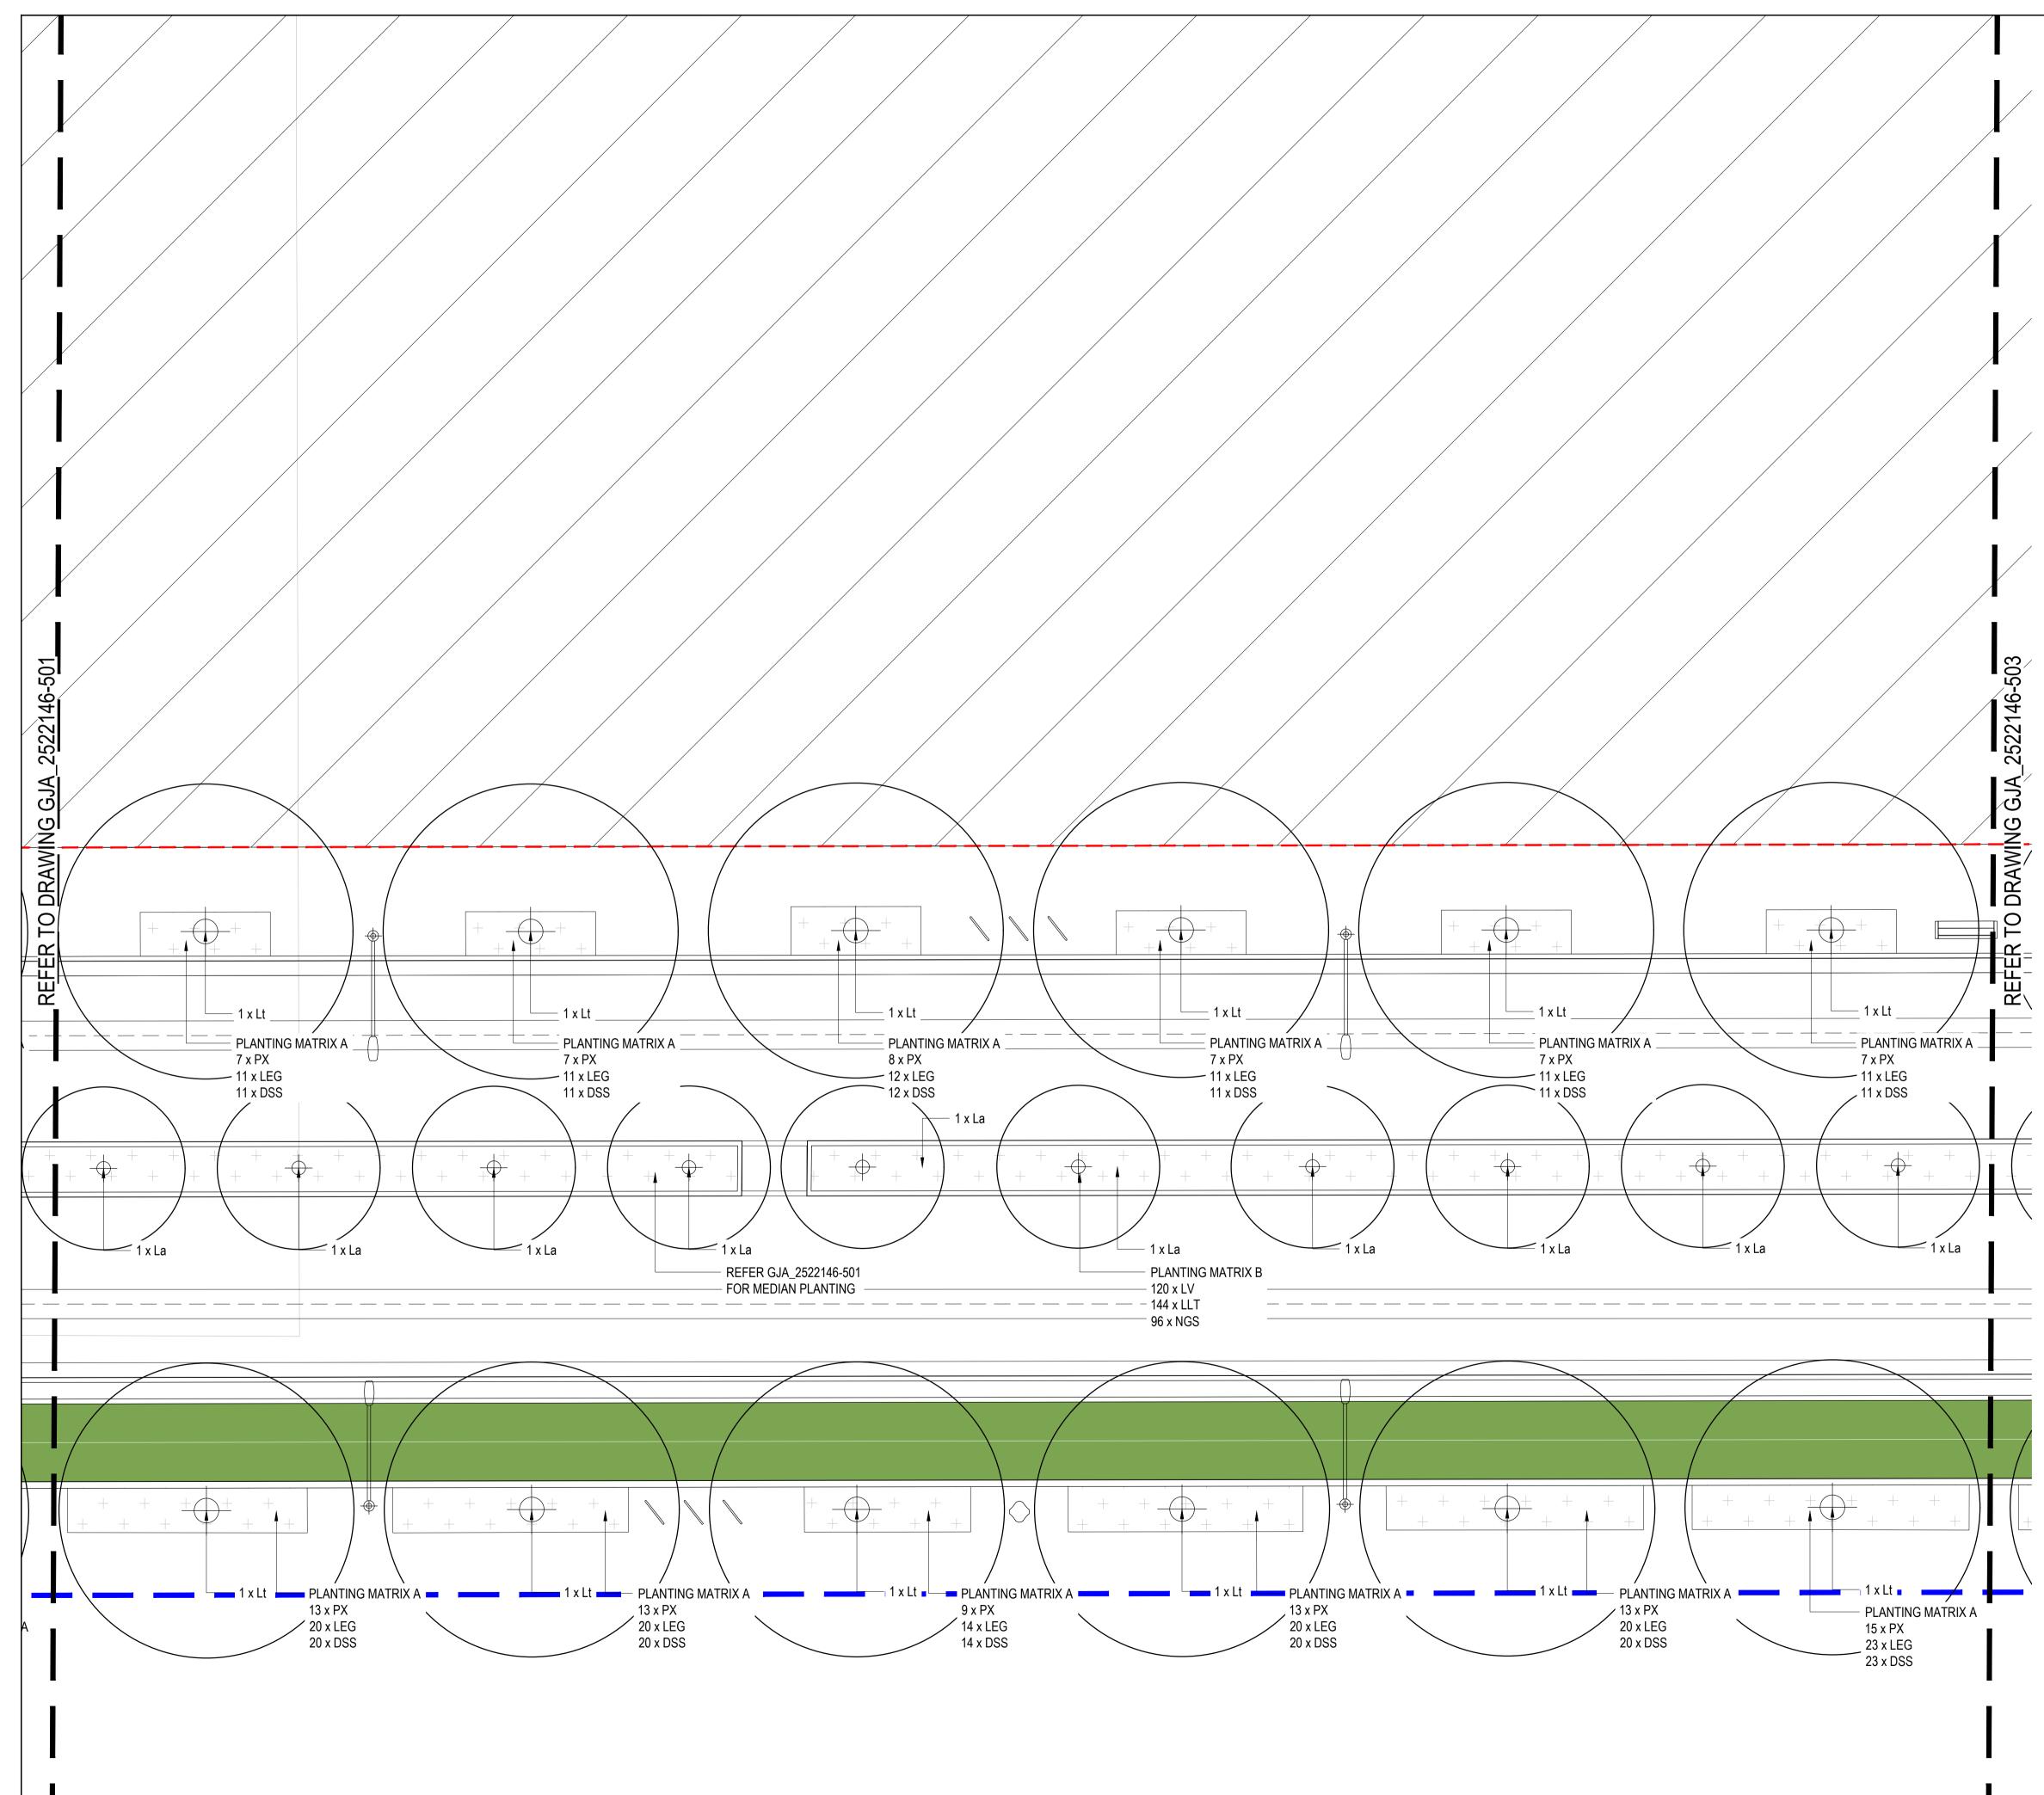


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DRAWING TITLE

PLANTING PLAN





LEGEND SOFTWORKS - PLANTING



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PROPOSED STREET TREE REFER TO DETAIL #/###-# AND PLANTING PLAN

TP1 - TREE PIT BUSTER (BROKEN KERB) ´_| + + | + + | + + + REFER TO DETAIL #/###-# SCHEDULE AND PLANTING PLAN

> TP2 - TREE PIT IN PAVING REFER TO DETAIL #/###-# SCHEDULE AND PLANTING PLAN

TP3 - TREE IN MASS PLANTING REFER TO DETAIL #/###-# ,SCHEDULE AND PLANTING PLAN

MP1 - MASS PLANTING -VERGE REFER TO DETAIL #/###-# ,SCHEDULE AND PLANTING PLAN

MP2 - MASS PLANTING - MEDIAN

REFER TO DETAIL #/###-# ,SCHEDULE AND PLANTING PLAN

MP3 - SWALES/ RAIN GARDEN PLANTING REFER TO DETAIL #/###-# ,SCHEDULE AND PLANTING PLAN

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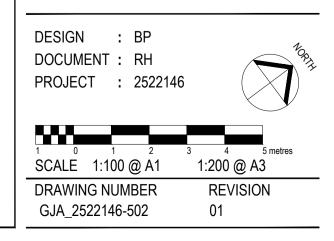
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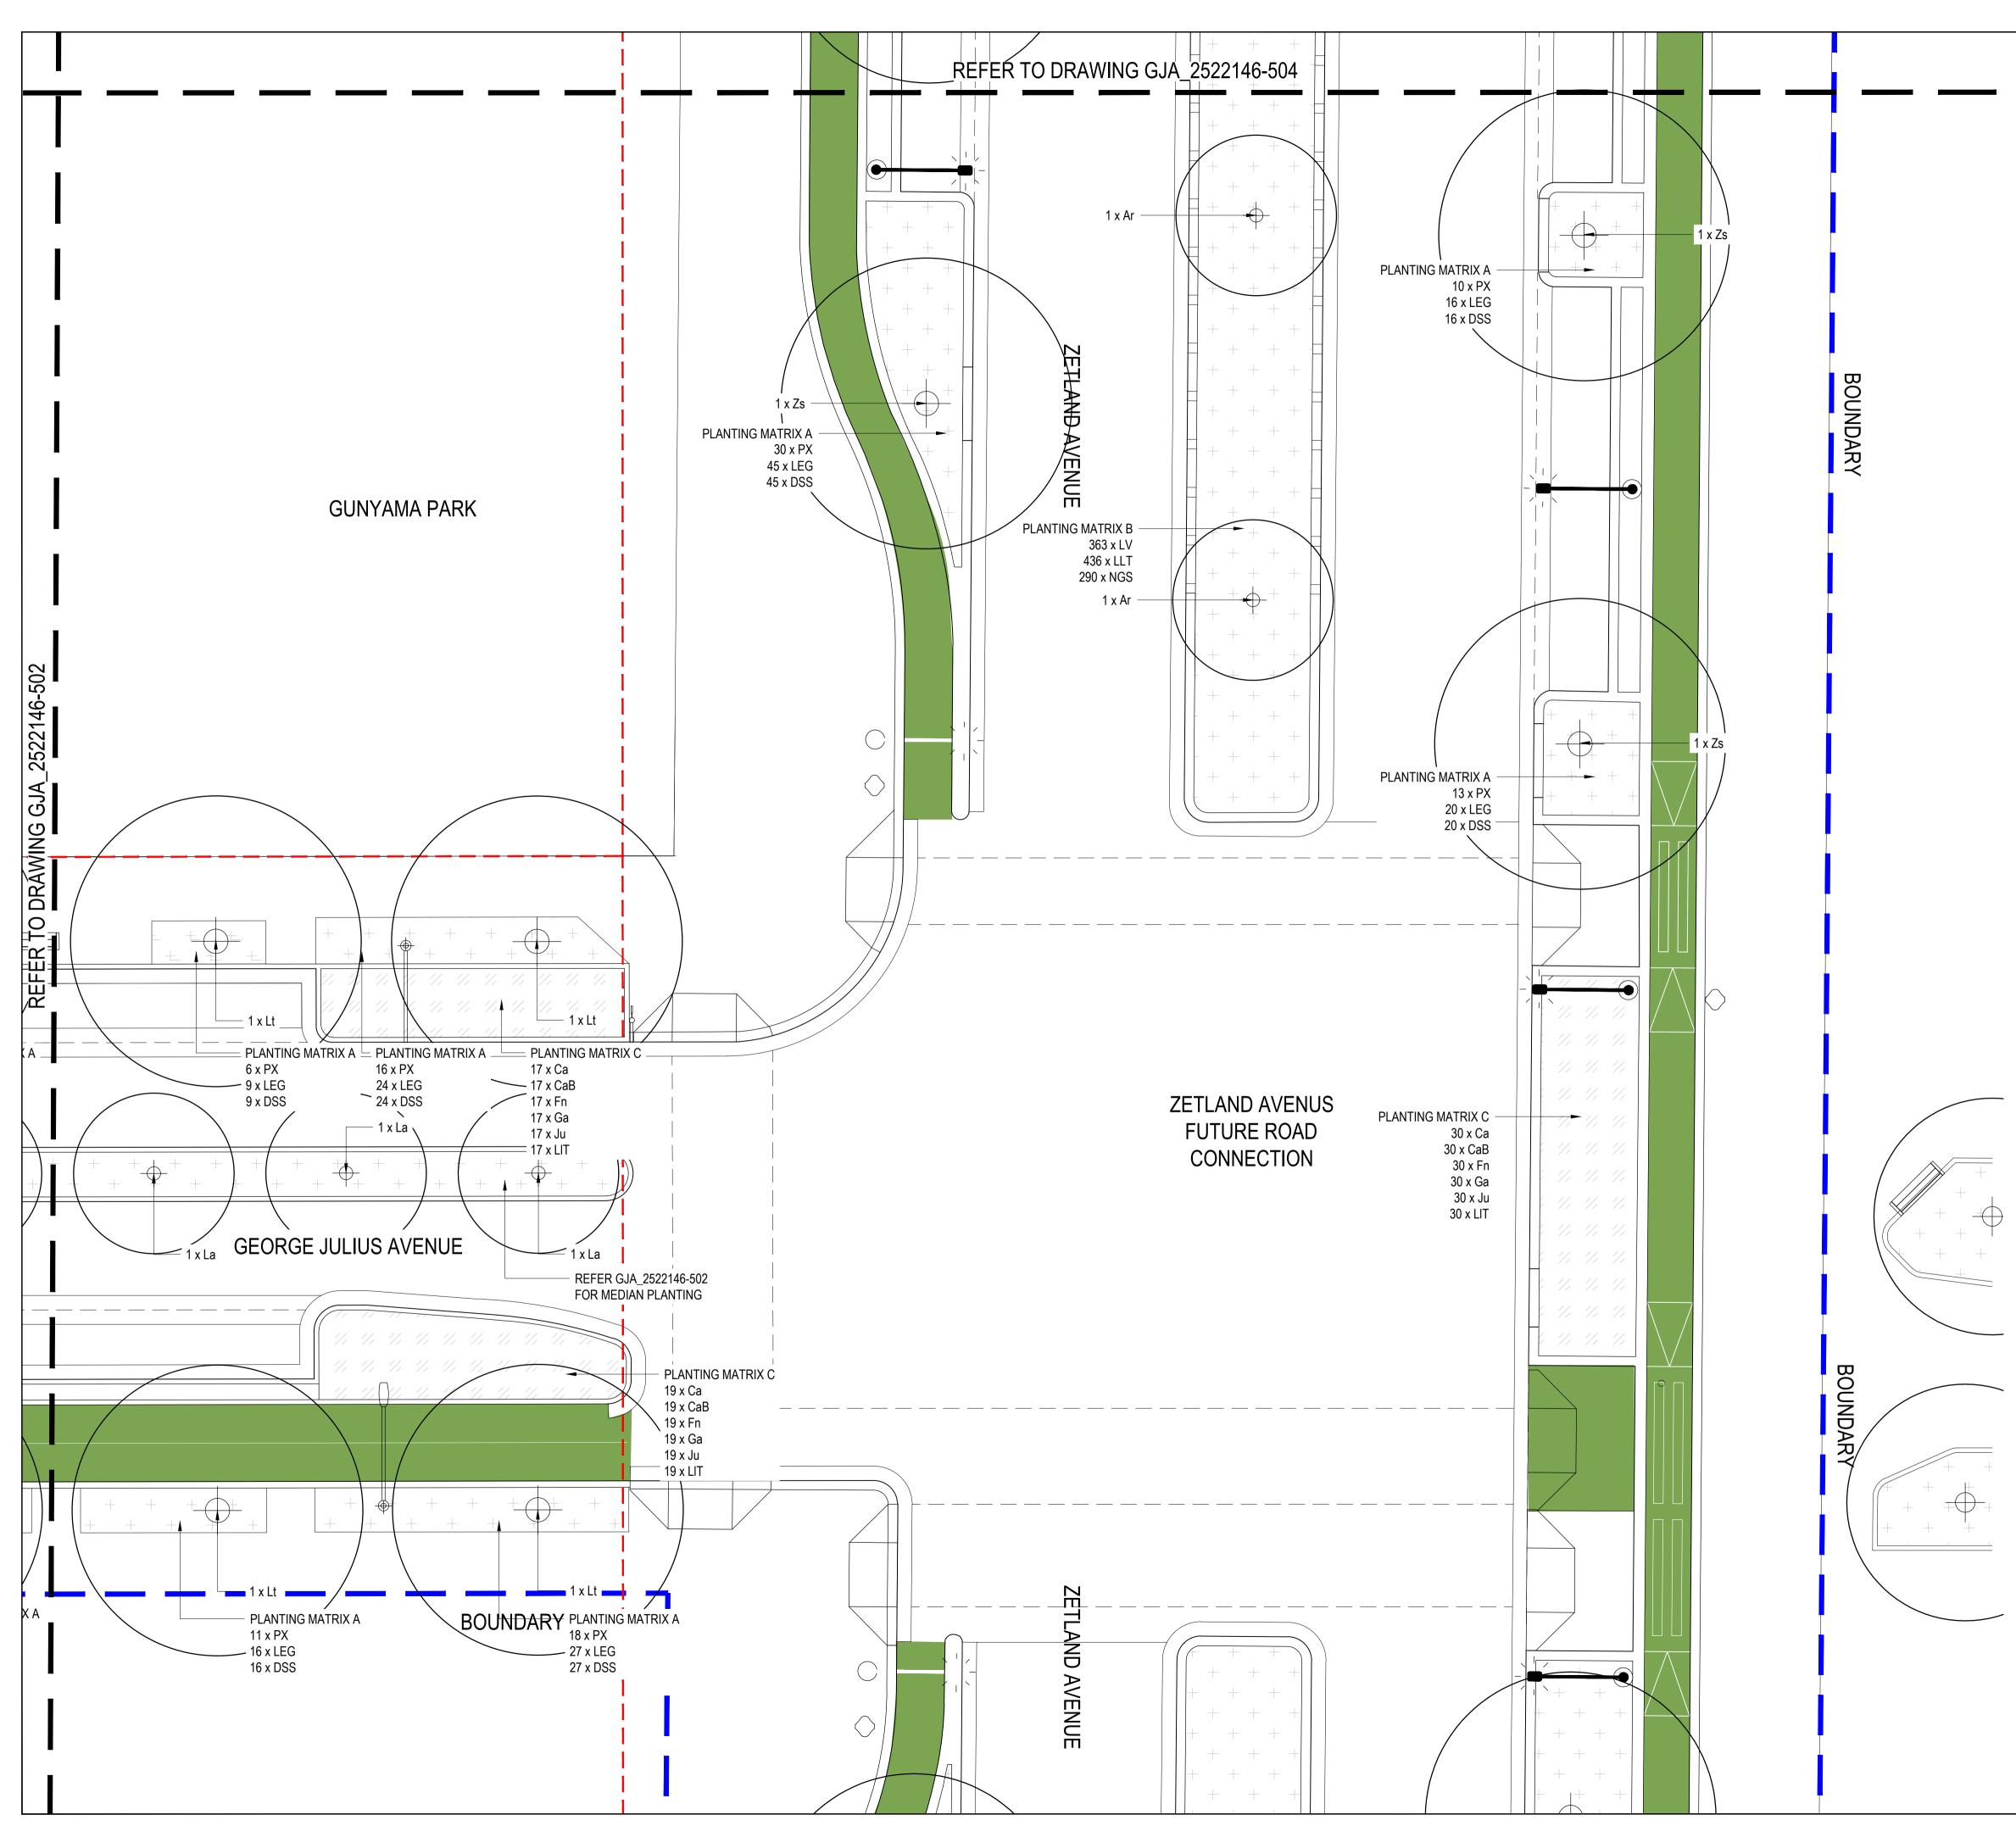


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PLANTING PLAN





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SOFTWORKS - PLANTING



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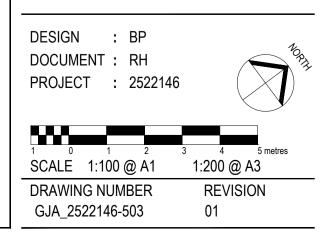
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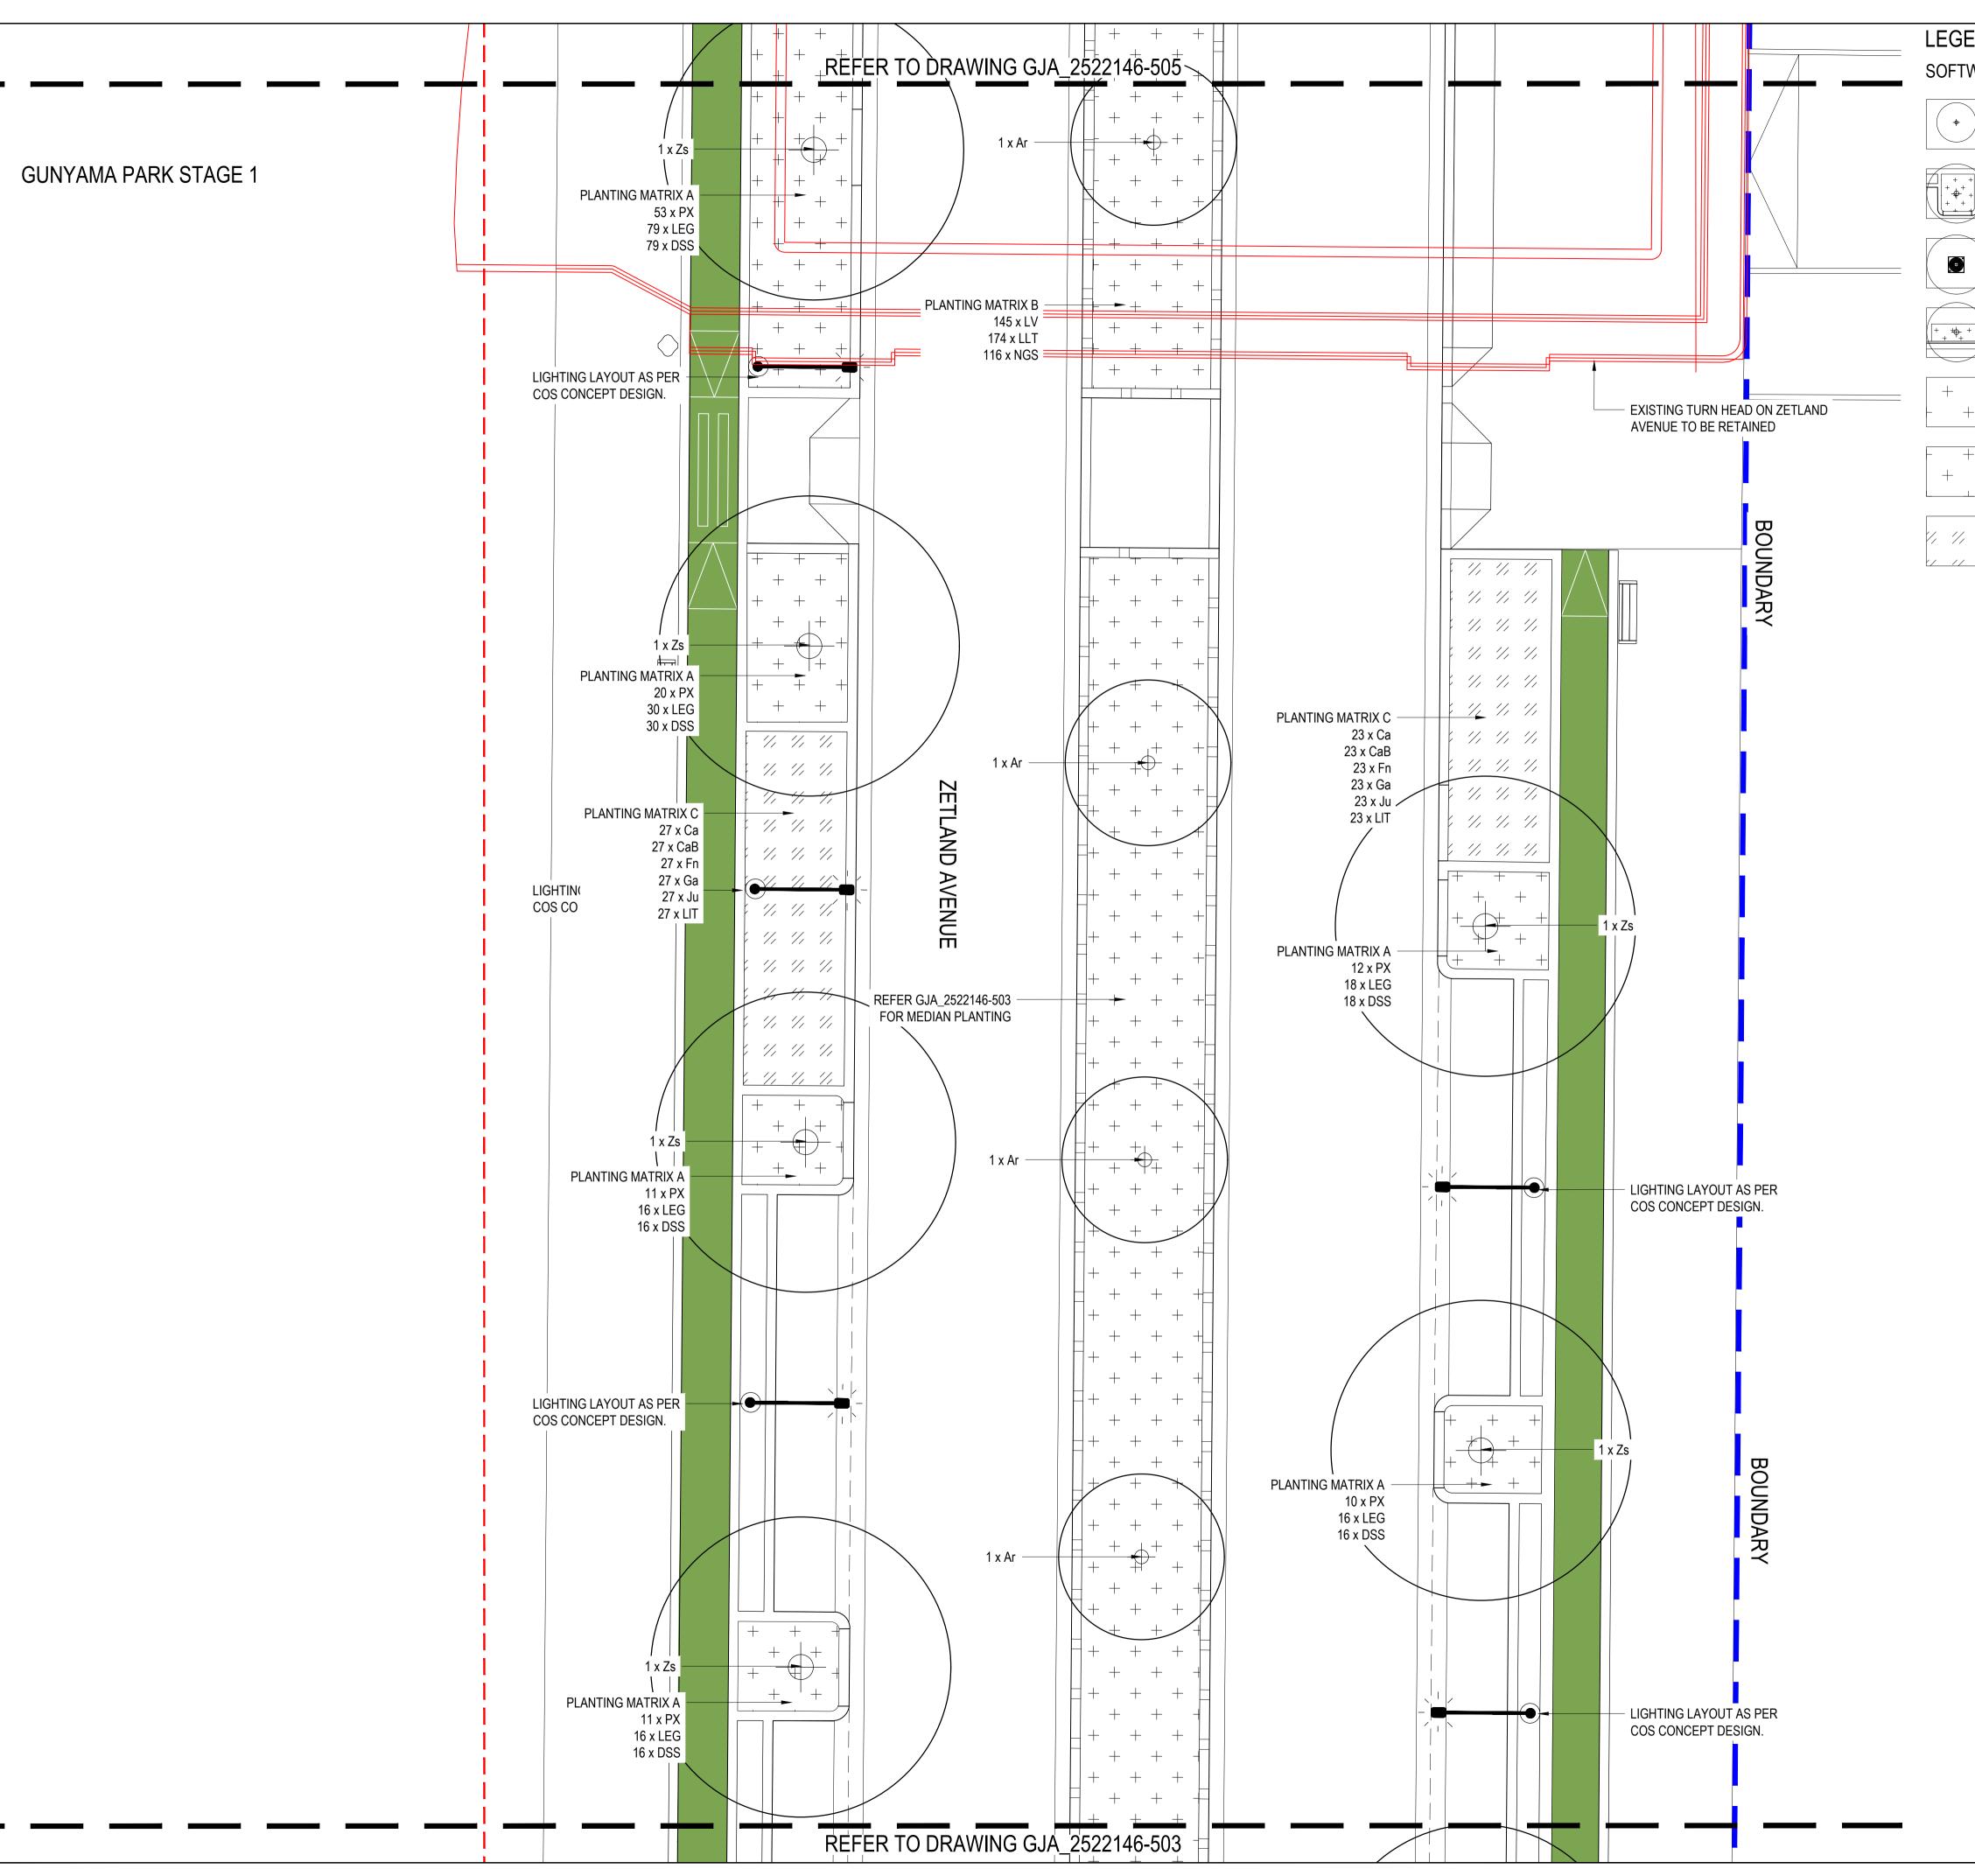
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DRAWING TITLE

PLANTING PLAN



NOTE: ZETLAND AVENUE FUTURE ROAD CONNECTION NOT PART OF CONSTRUCTION SCOPE. DOCUMENTED TO DD STAGE TO UNDERSTAND FUTURE CONNECTION.



LEGEND

SOFTWORKS - PLANTING



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MP2 - MASS PLANTING - MEDIAN REFER TO DETAIL #/###-# ,SCHEDULE AND PLANTING PLAN

MP3 - SWALES/ RAIN GARDEN PLANTING REFER TO DETAIL #/###-# ,SCHEDULE AND PLANTING PLAN

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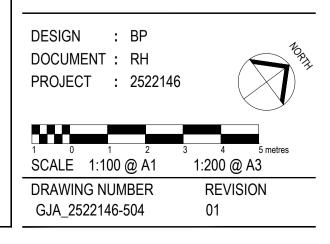
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ISSUE DESCRIPTION	BY	CF


ISSUE	CODE	ISSUE DESCRIPTION	BY	СНК	DATE
01	PRE	50% DESIGN DEVELOPMENT	RH	LI	21.06.2023

DRAWING TITLE

PLANTING PLAN



NOTE: ZETLAND AVENUE FUTURE ROAD CONNECTION NOT PART OF CONSTRUCTION SCOPE. DOCUMENTED TO DD STAGE TO UNDERSTAND FUTURE CONNECTION.

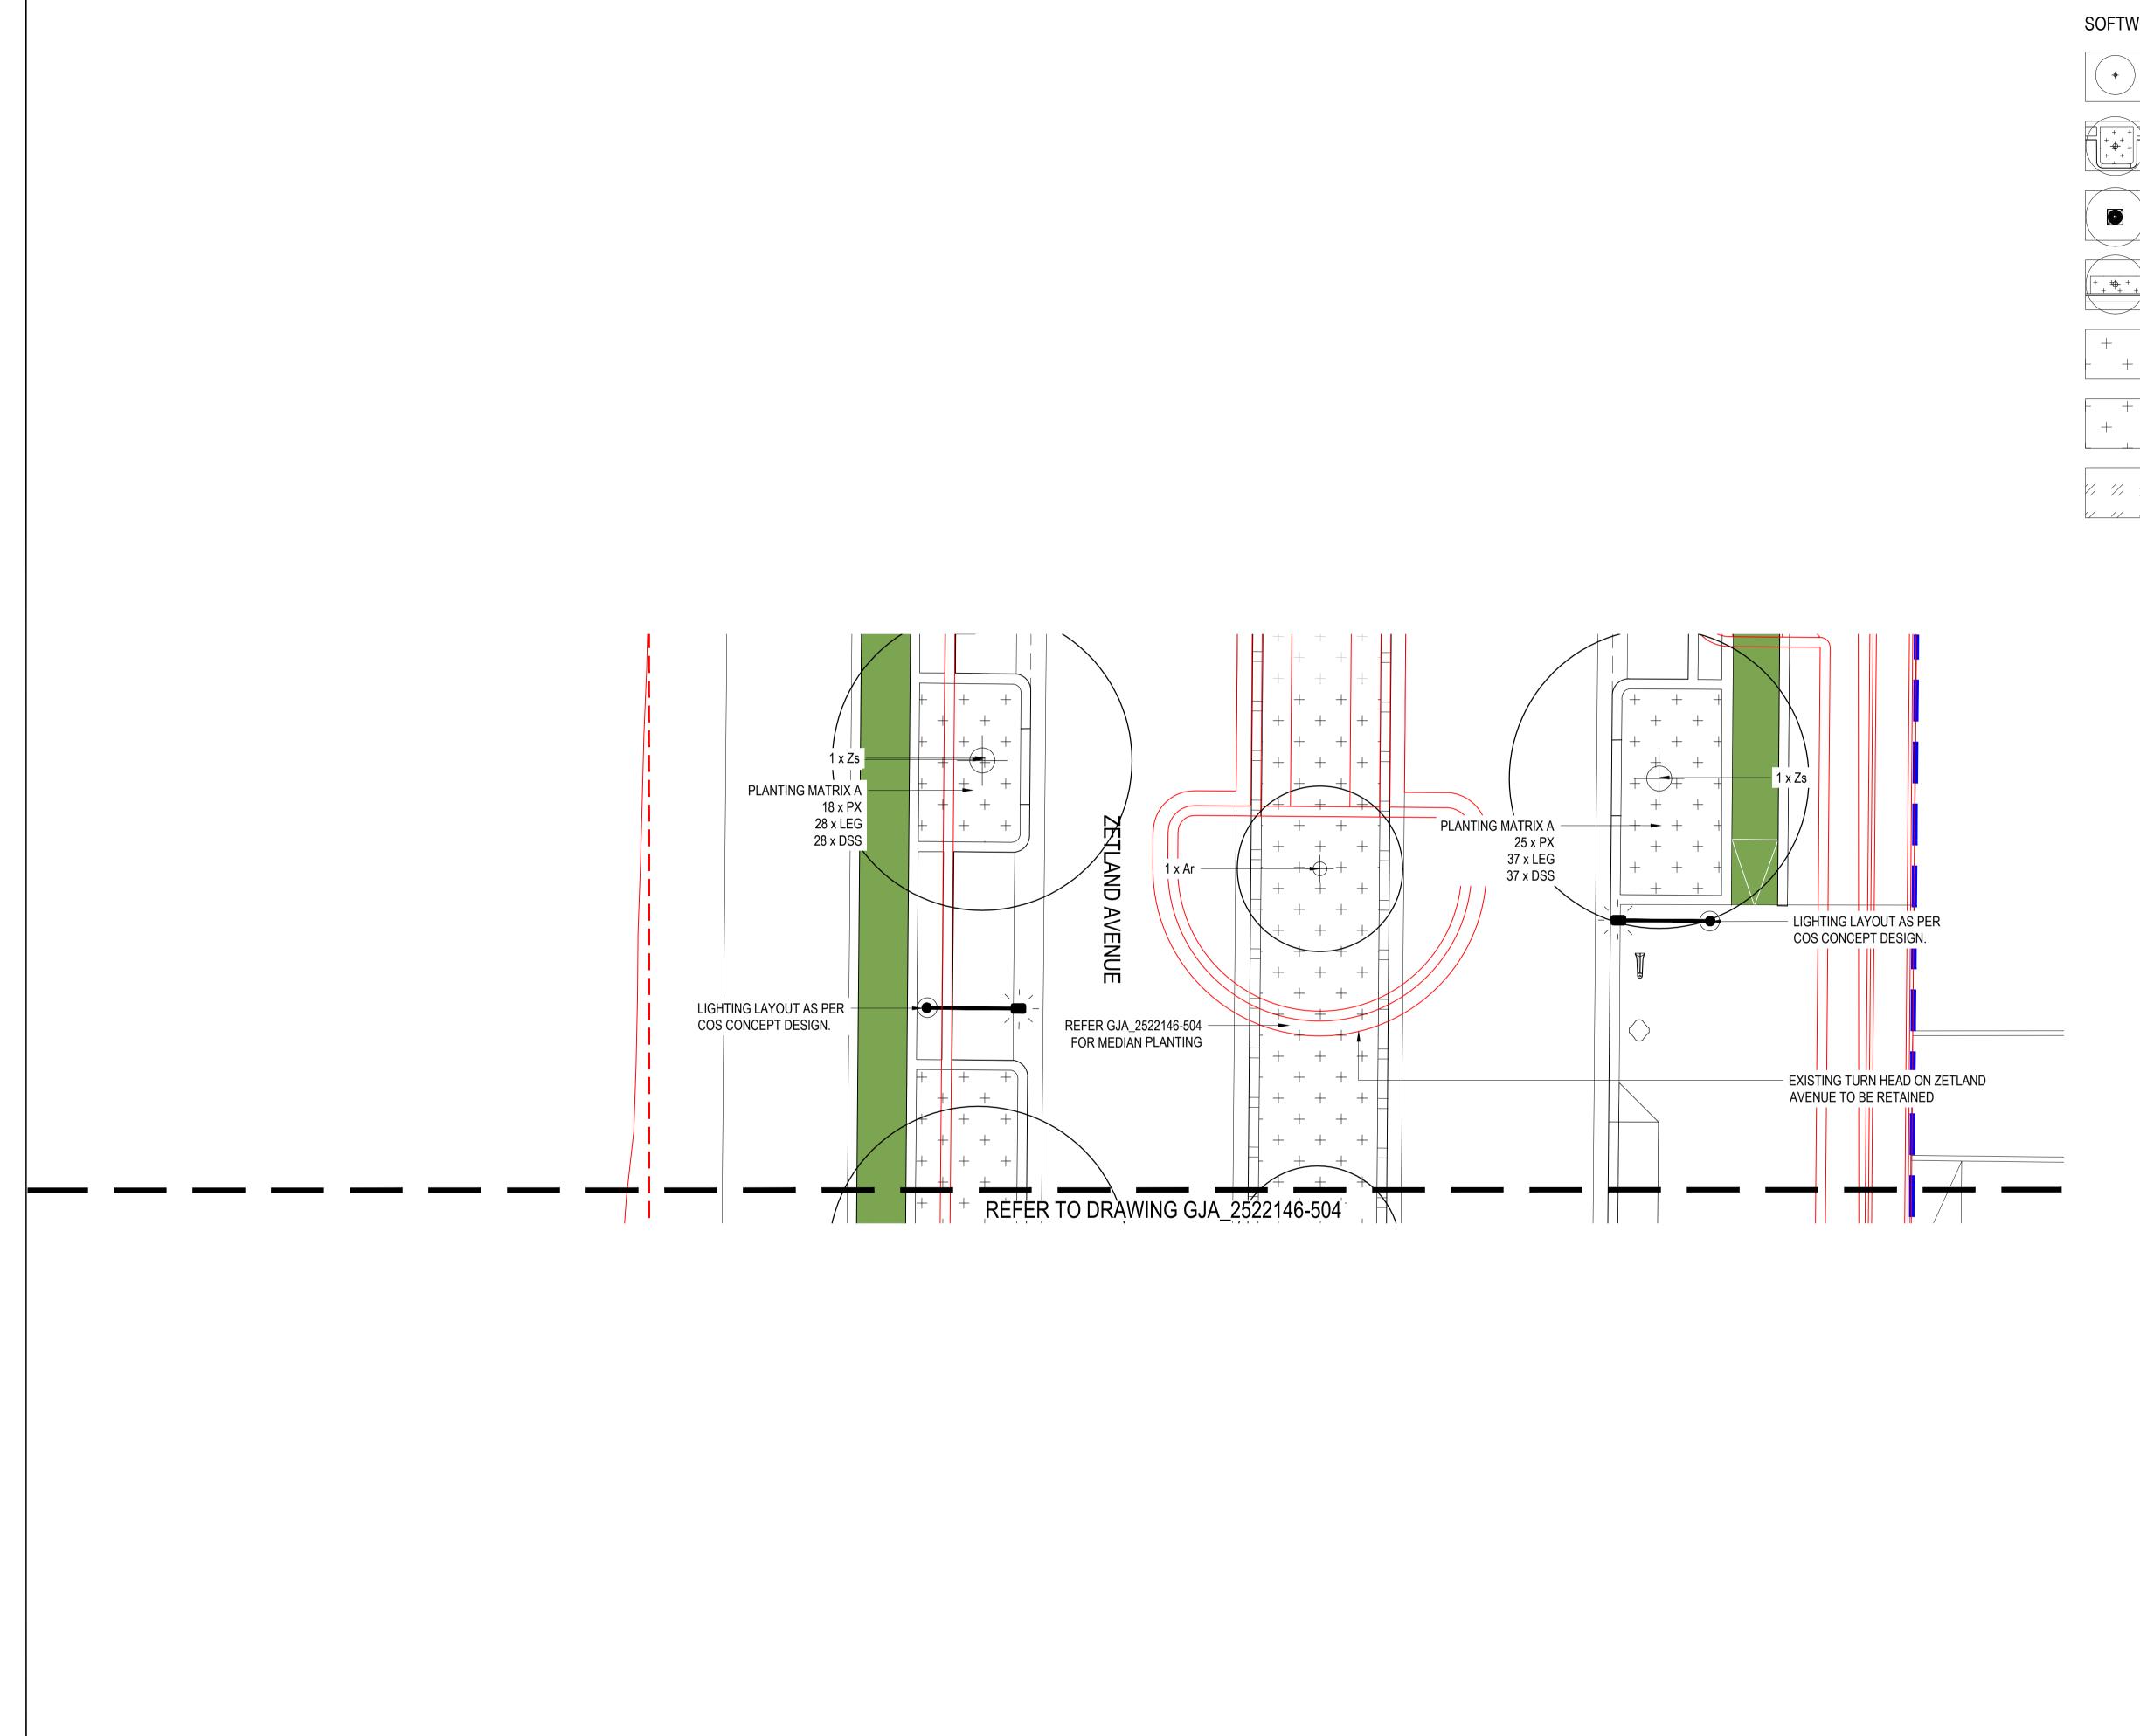

LEGEND

SOFTWORKS - PLANTING



(#)

+ + + +

+

PROPOSED STREET TREE REFER TO DETAIL #/###-# AND PLANTING PLAN

TP1 - TREE PIT BUSTER (BROKEN KERB) REFER TO DETAIL #/###-# SCHEDULE AND PLANTING PLAN

TP2 - TREE PIT IN PAVING REFER TO DETAIL #/###-# SCHEDULE AND PLANTING PLAN

TP3 - TREE IN MASS PLANTING REFER TO DETAIL #/###-# ,SCHEDULE AND PLANTING PLAN

MP1 - MASS PLANTING -VERGE REFER TO DETAIL #/###-# SCHEDULE AND PLANTING PLAN

+

1 1/1

MP2 - MASS PLANTING - MEDIAN REFER TO DETAIL #/###-# SCHEDULE AND PLANTING PLAN

MP3 - SWALES/ RAIN GARDEN PLANTING REFER TO DETAIL #/###-# ,SCHEDULE AND PLANTING PLAN

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PROJECT

GUNYAMA PARK STAGE 2

CLIENT

CITY OF SYDNEY

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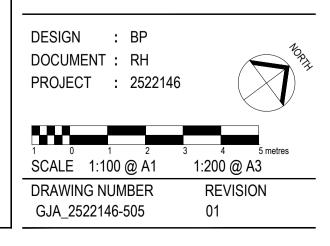
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(DRAFT)					
ISSUE	CODE	ISSUE DESCRIPTION	BY	СНК	DATE
01	PRE	50% DESIGN DEVELOPMENT	RH	LI	21.06.2023


PRF - P	relimina	ry CA - Council Approval T - To	ender		V - Construction	
PRE - Preliminary CA - Council Approval T - Tender CON - Construction						


DRAWING TITLE

PLANTING PLAN



NOTE: ZETLAND AVENUE FUTURE ROAD CONNECTION NOT PART OF CONSTRUCTION SCOPE. DOCUMENTED TO DD STAGE TO UNDERSTAND FUTURE CONNECTION.

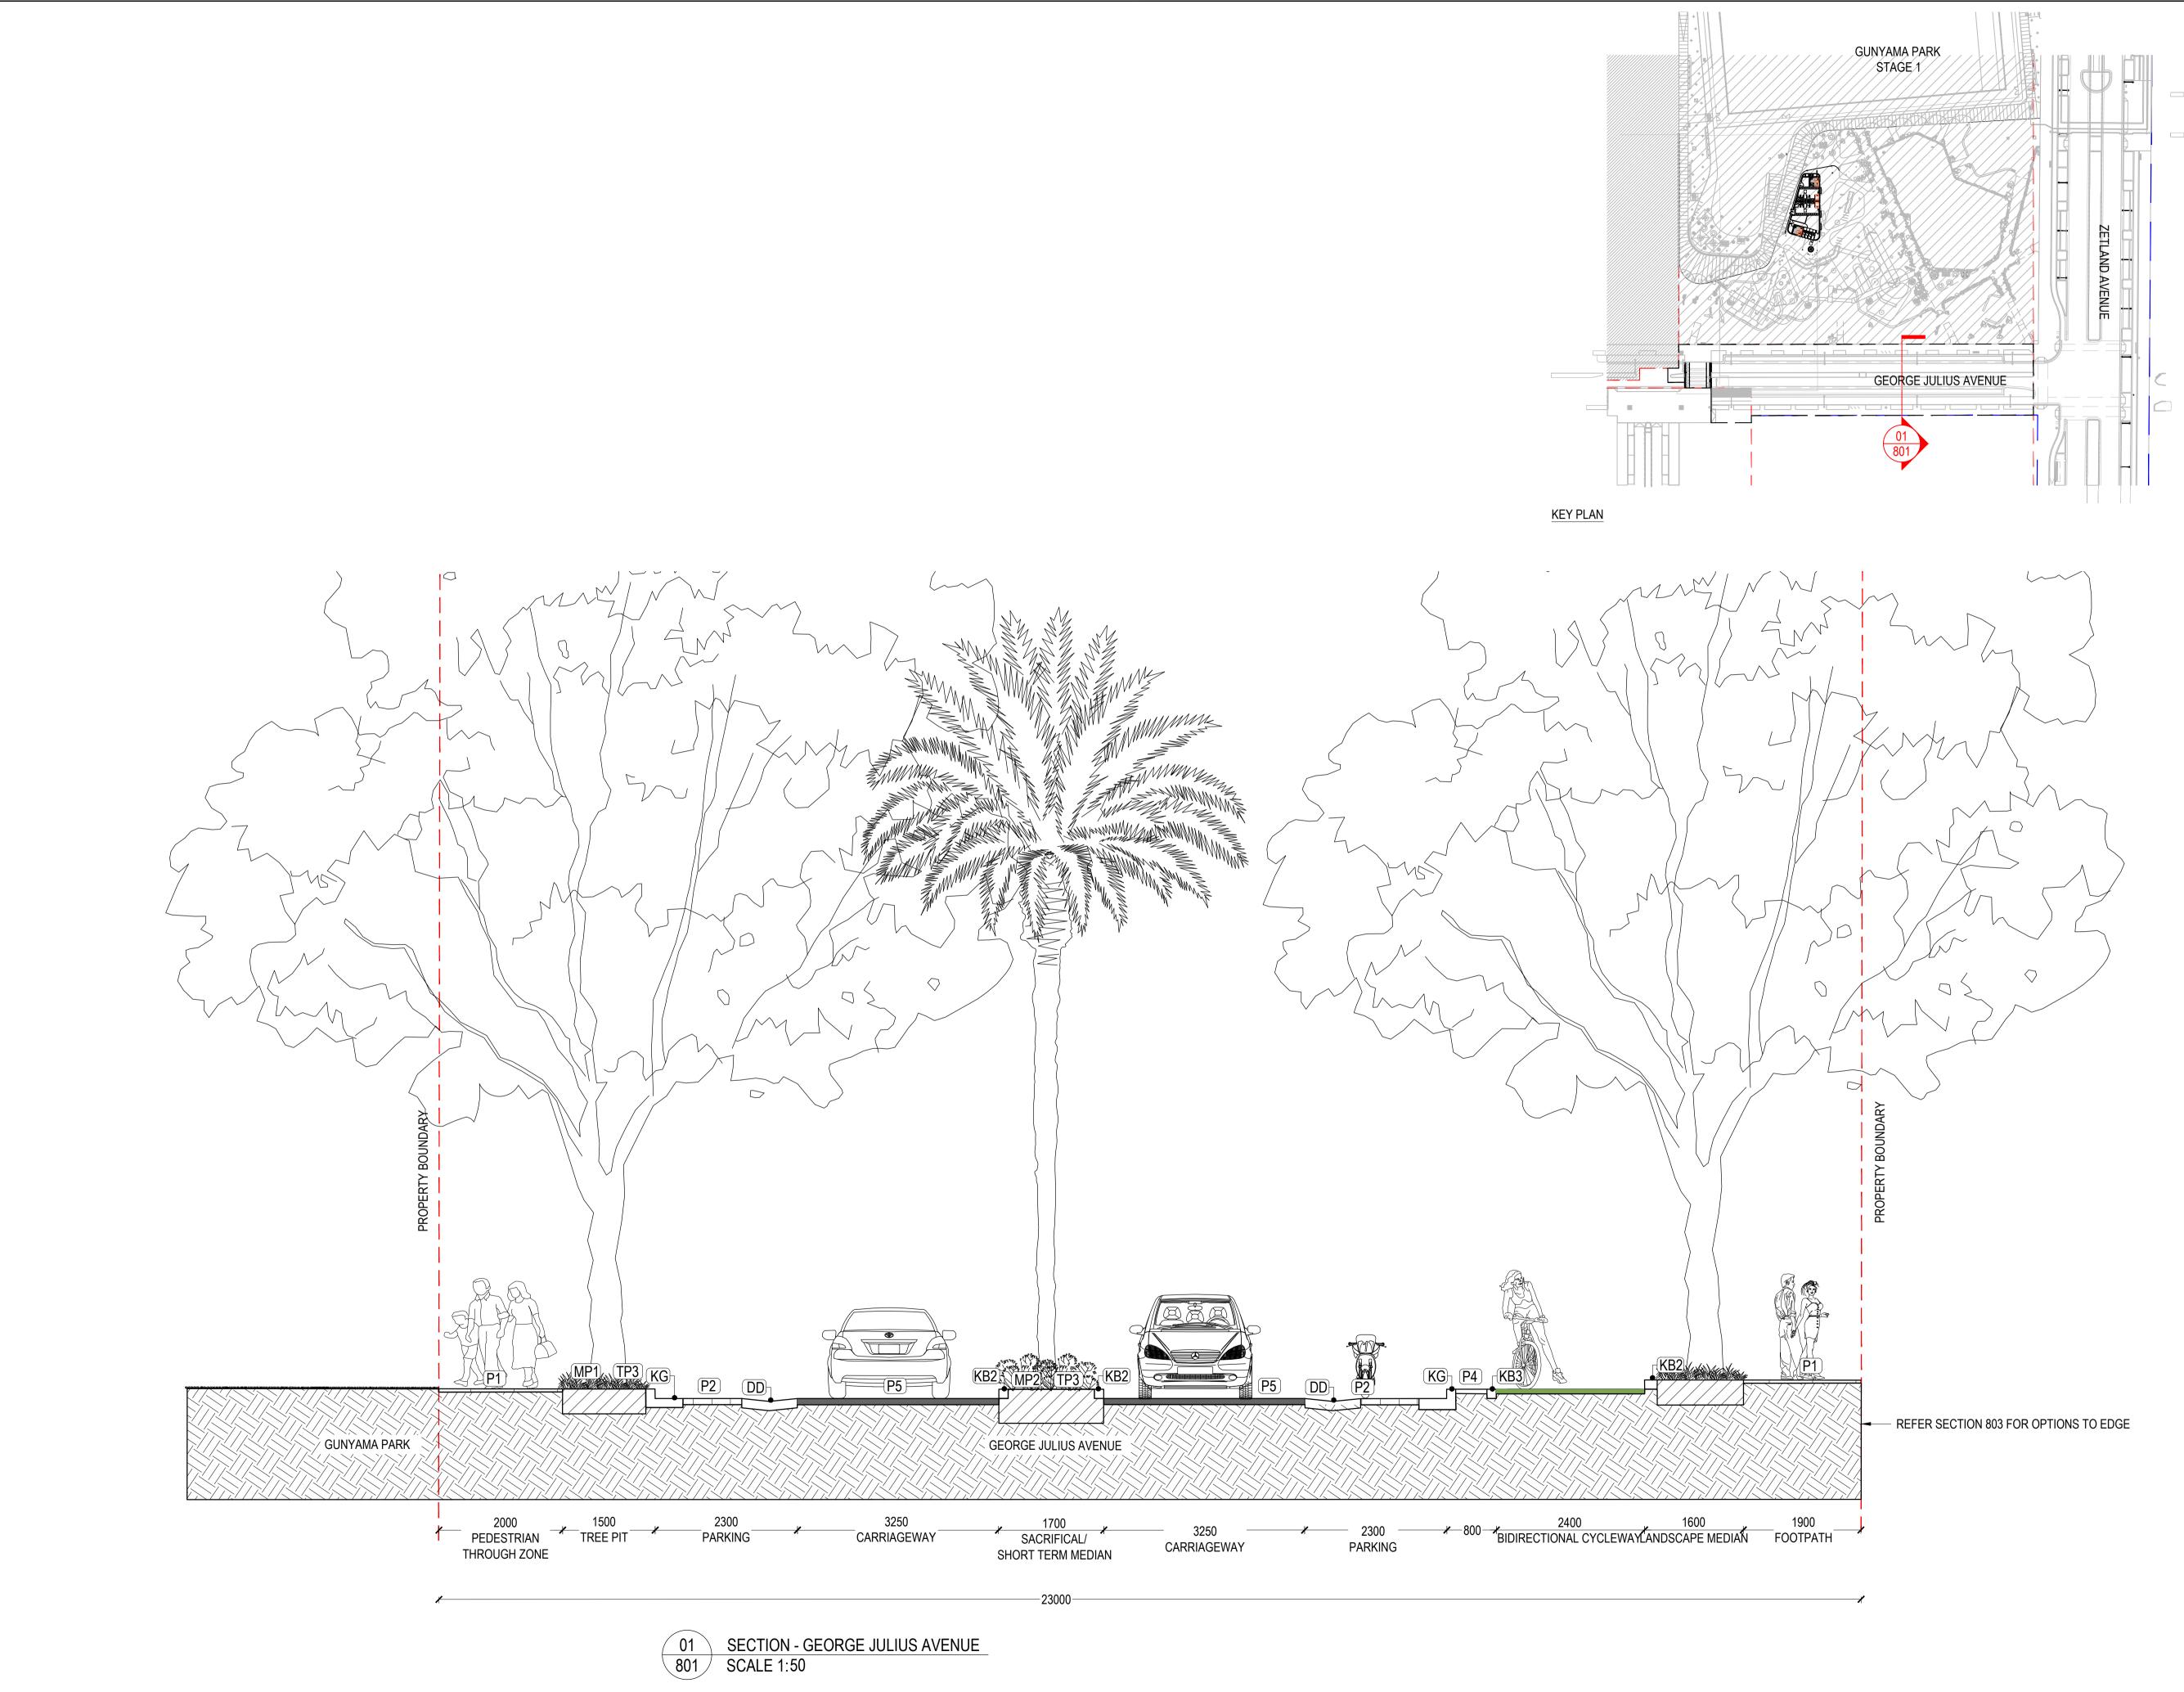

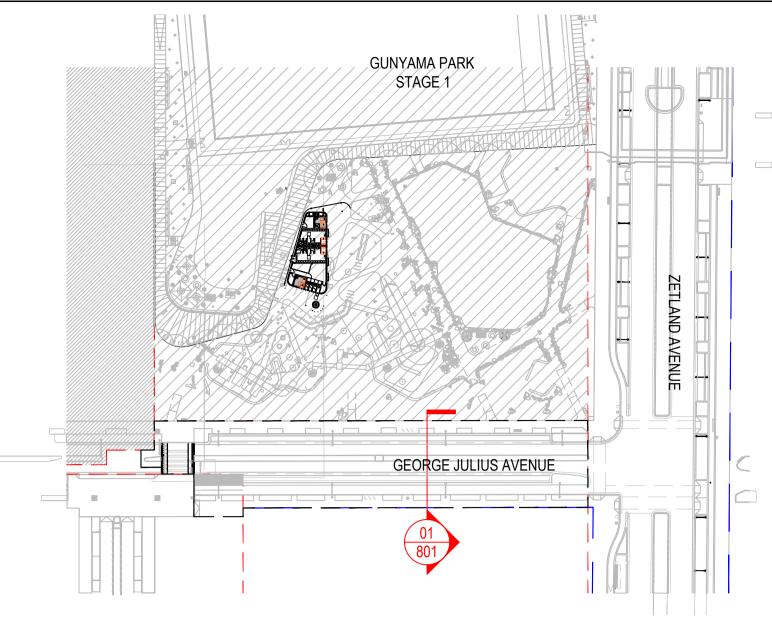



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ISSUE	CODE	ISSUE DESCRIPTION	BY	СНК	DATE	
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PRE - Preliminary CA - Council Approval T - Tender CON - Construction						

DRAWING TITLE


SECTIONS

DESIGN : BP DOCUMENT : RH PROJECT : 2522146



SCALE AS SHOWN @ A1 DRAWING NUMBER GJA_2522146-801

REVISION 01

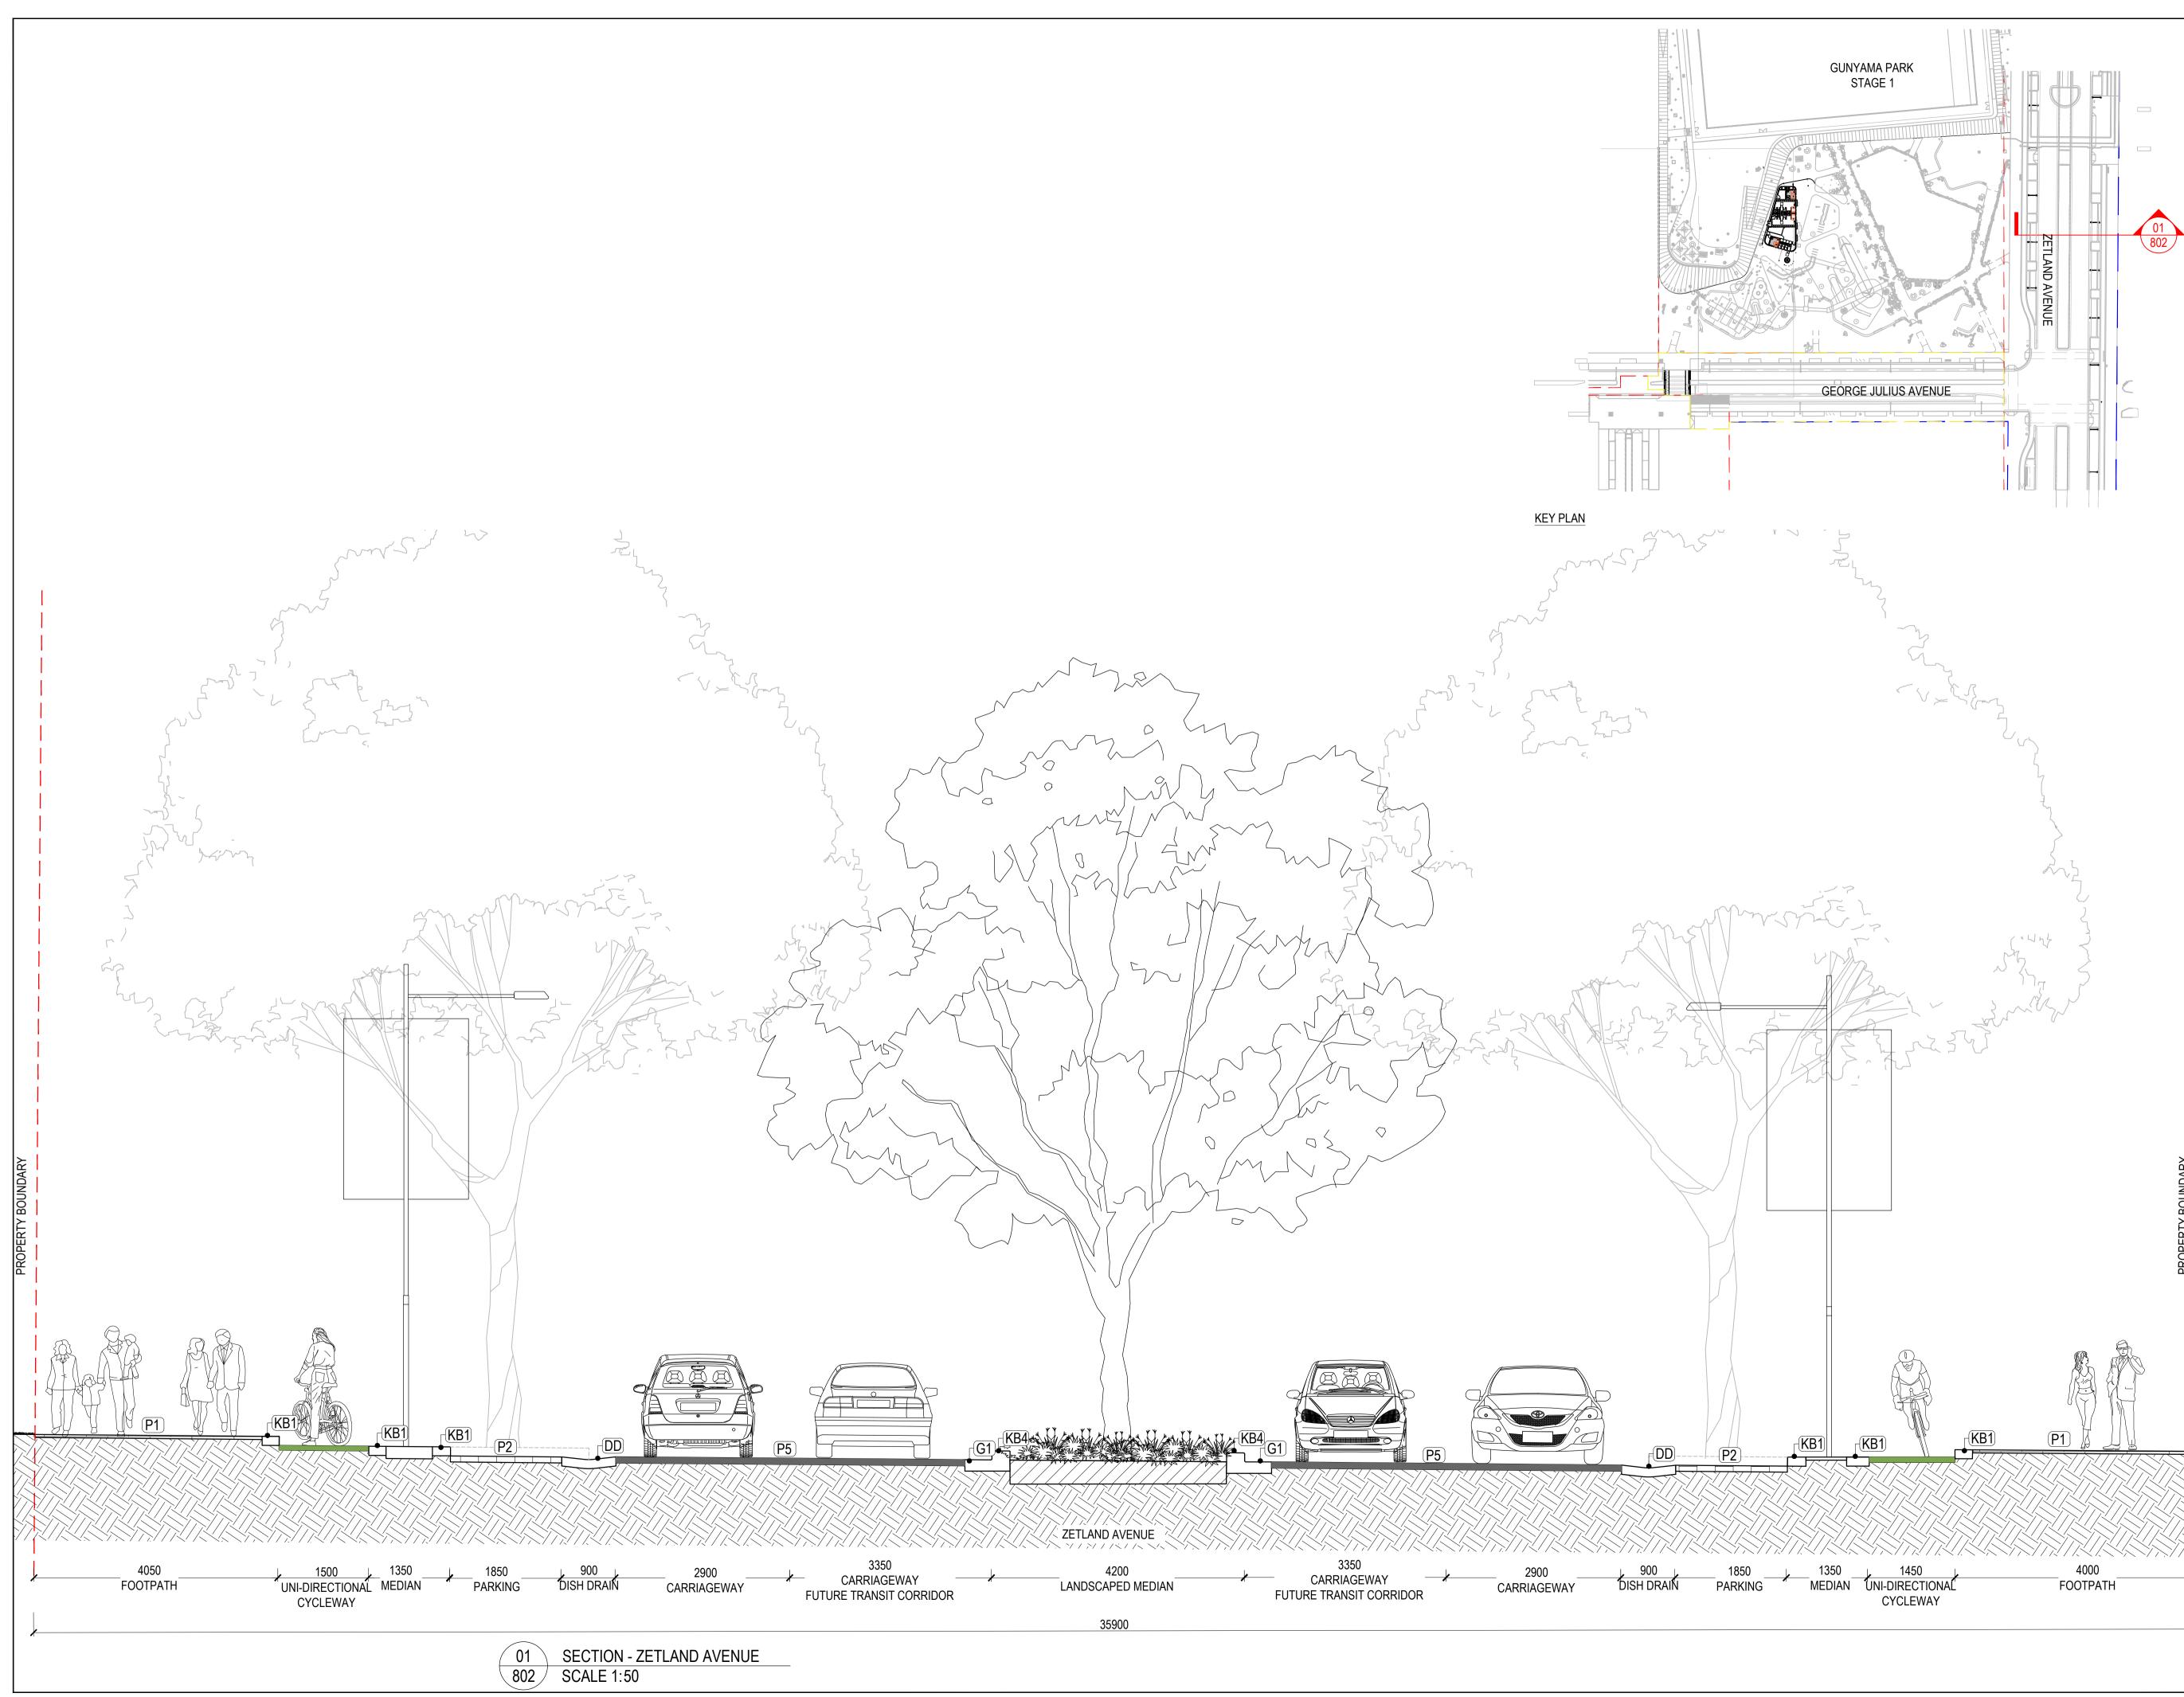

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PROJECT

GUNYAMA PARK STAGE 2

CLIENT

CITY OF SYDNEY

NOTES


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DRAWING TITLE


SECTIONS

DESIGN : BP DOCUMENT : RH PROJECT : 2522146




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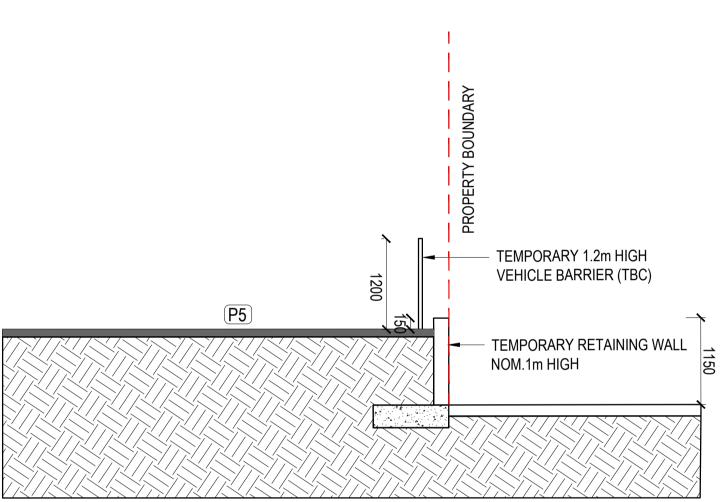
REVISION 01

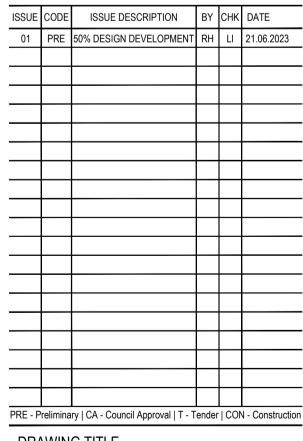


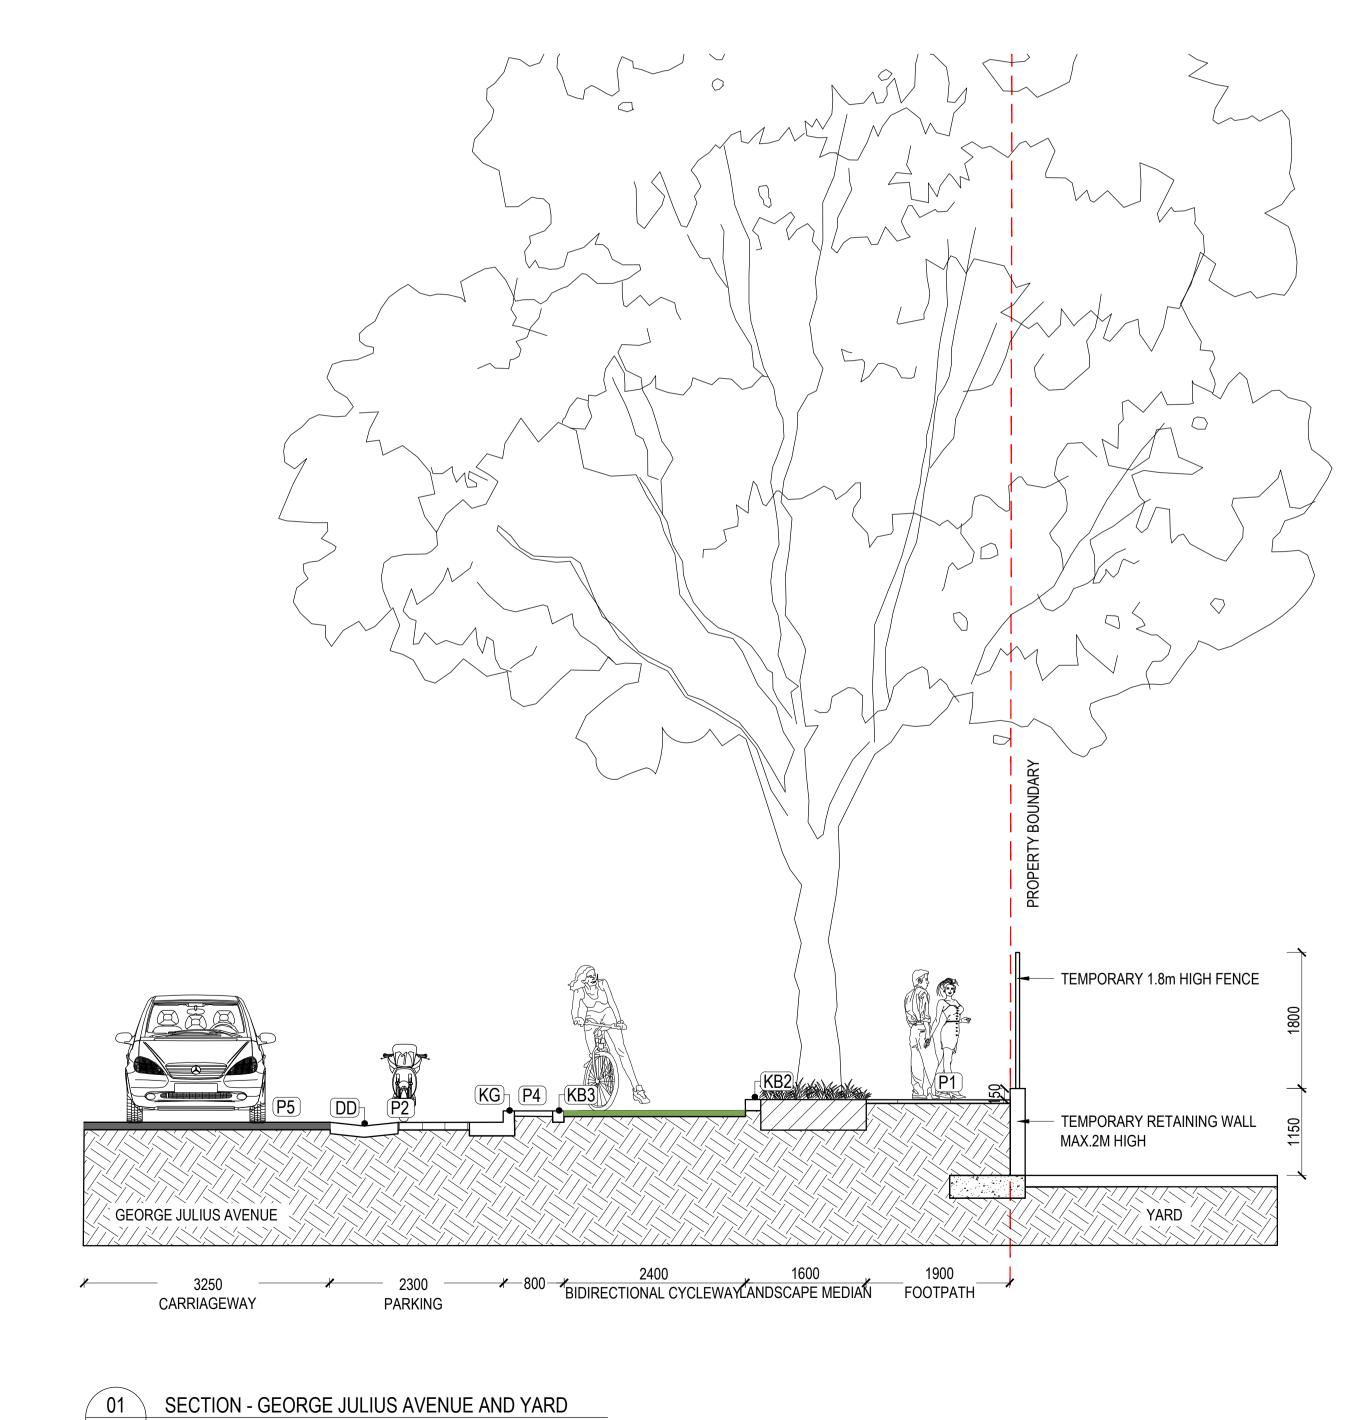SECTION - GEORGE JULIUS AVENUE AND YARD 803 SCALE 1:50



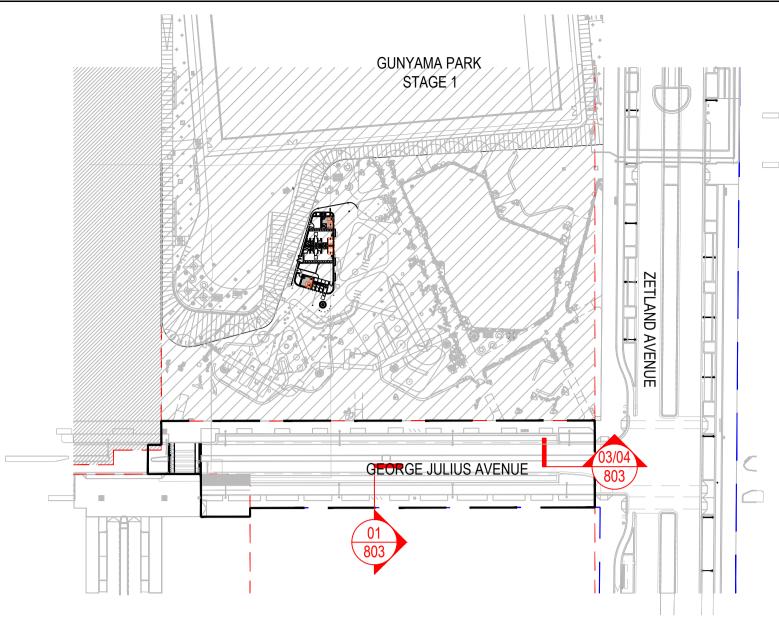



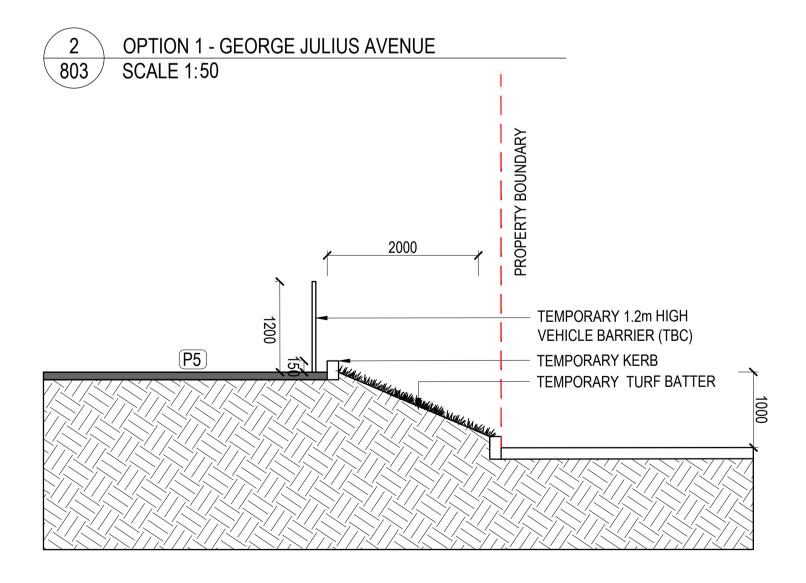



OPTION 2 - GEORGE JULIUS AVENUE

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PROJECT

GUNYAMA PARK STAGE 2

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ISSUE CODE ISSUE DESCRIPTION BY CHK DATE						
01 PRE 50% DESIGN DEVELOPMENT RH LI 21.06.2023	}					
PRE - Preliminary CA - Council Approval T - Tender CON - Construction						

DRAWING TITLE

SECTIONS

DESIGN : BP DOCUMENT : RH PROJECT : 2522146



SCALE AS SHOWN @ A1 DRAWING NUMBER GJA_2522146-803

REVISION 01

	2522146_GJA_GUNYAMA PARK
CODE	DESCRIPTION
SOFTWORKS - PLA	NTING
TP1	TREE PIT BLISTER
TP2	TREE PIT IN PAVING
TP3	TREE IN MASS PLATING
MP1	MASS PLANTING - VERGE
MP2	MASS PLANTING - MEDIAN
MP3	SWALES/ RAIN GARDEN PLANTING
HARDWORKS - KER	BS
KB1	BLUE STONE KERB
KB1	BLUE STONE FLUSH KERB
KB2	CONCRETE KERB
KB3	FLUSH CONCRETE KERB (150MM)
KB4	BROKEN KERB
KG	BROKEN KERB
G1	CONCRETE GUTTER
DD	DISH DRAIN
HARDWORKS - PAV	ING
P1	PAVING TYPE 1 - CONCRETE UNIT PAVING
P2	PAVING TYPE 2 - CAR PARKING BAYS HIGH ORDER
P3	PAVING TYPE 3 - SHARED ENVIRONMENT
P4	PAVING TYPE 4 - INSITU CONCRETE
P5	PAVING TYPE 5 - ASPHALT
HARDWORKS - FUR	NITURE
F1	OUTDOOR BENCH TYPE 1
B1	BIN TYPE 1
BL1	BOLLARD TYPE 1
BK1	BIKERAIL TYPE 1

*DETAILS TO BE DRAFTED FOR FUTURE ISSUE

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PROJECT

GUNYAMA PARK STAGE 2

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ISSUE	CODE	ISSUE DESCRIPTION	BY	СНК	DATE		
0101	PARKEE	STREDIESING ARDEVELOPMENT	限日	MLE	DDOUDDOZYYY		
					L. Construction		
PKE - P	PRE - Preliminary CA - Council Approval T - Tender CON - Construction						


DRAWING TITLE

DETAILS LIST

DESIGN : BP DOCUMENT : RH PROJECT : 2522146




SCALE AS SHOWN @ A1	
DRAWING NUMBER	RE۱
GJA_2522146-901	01

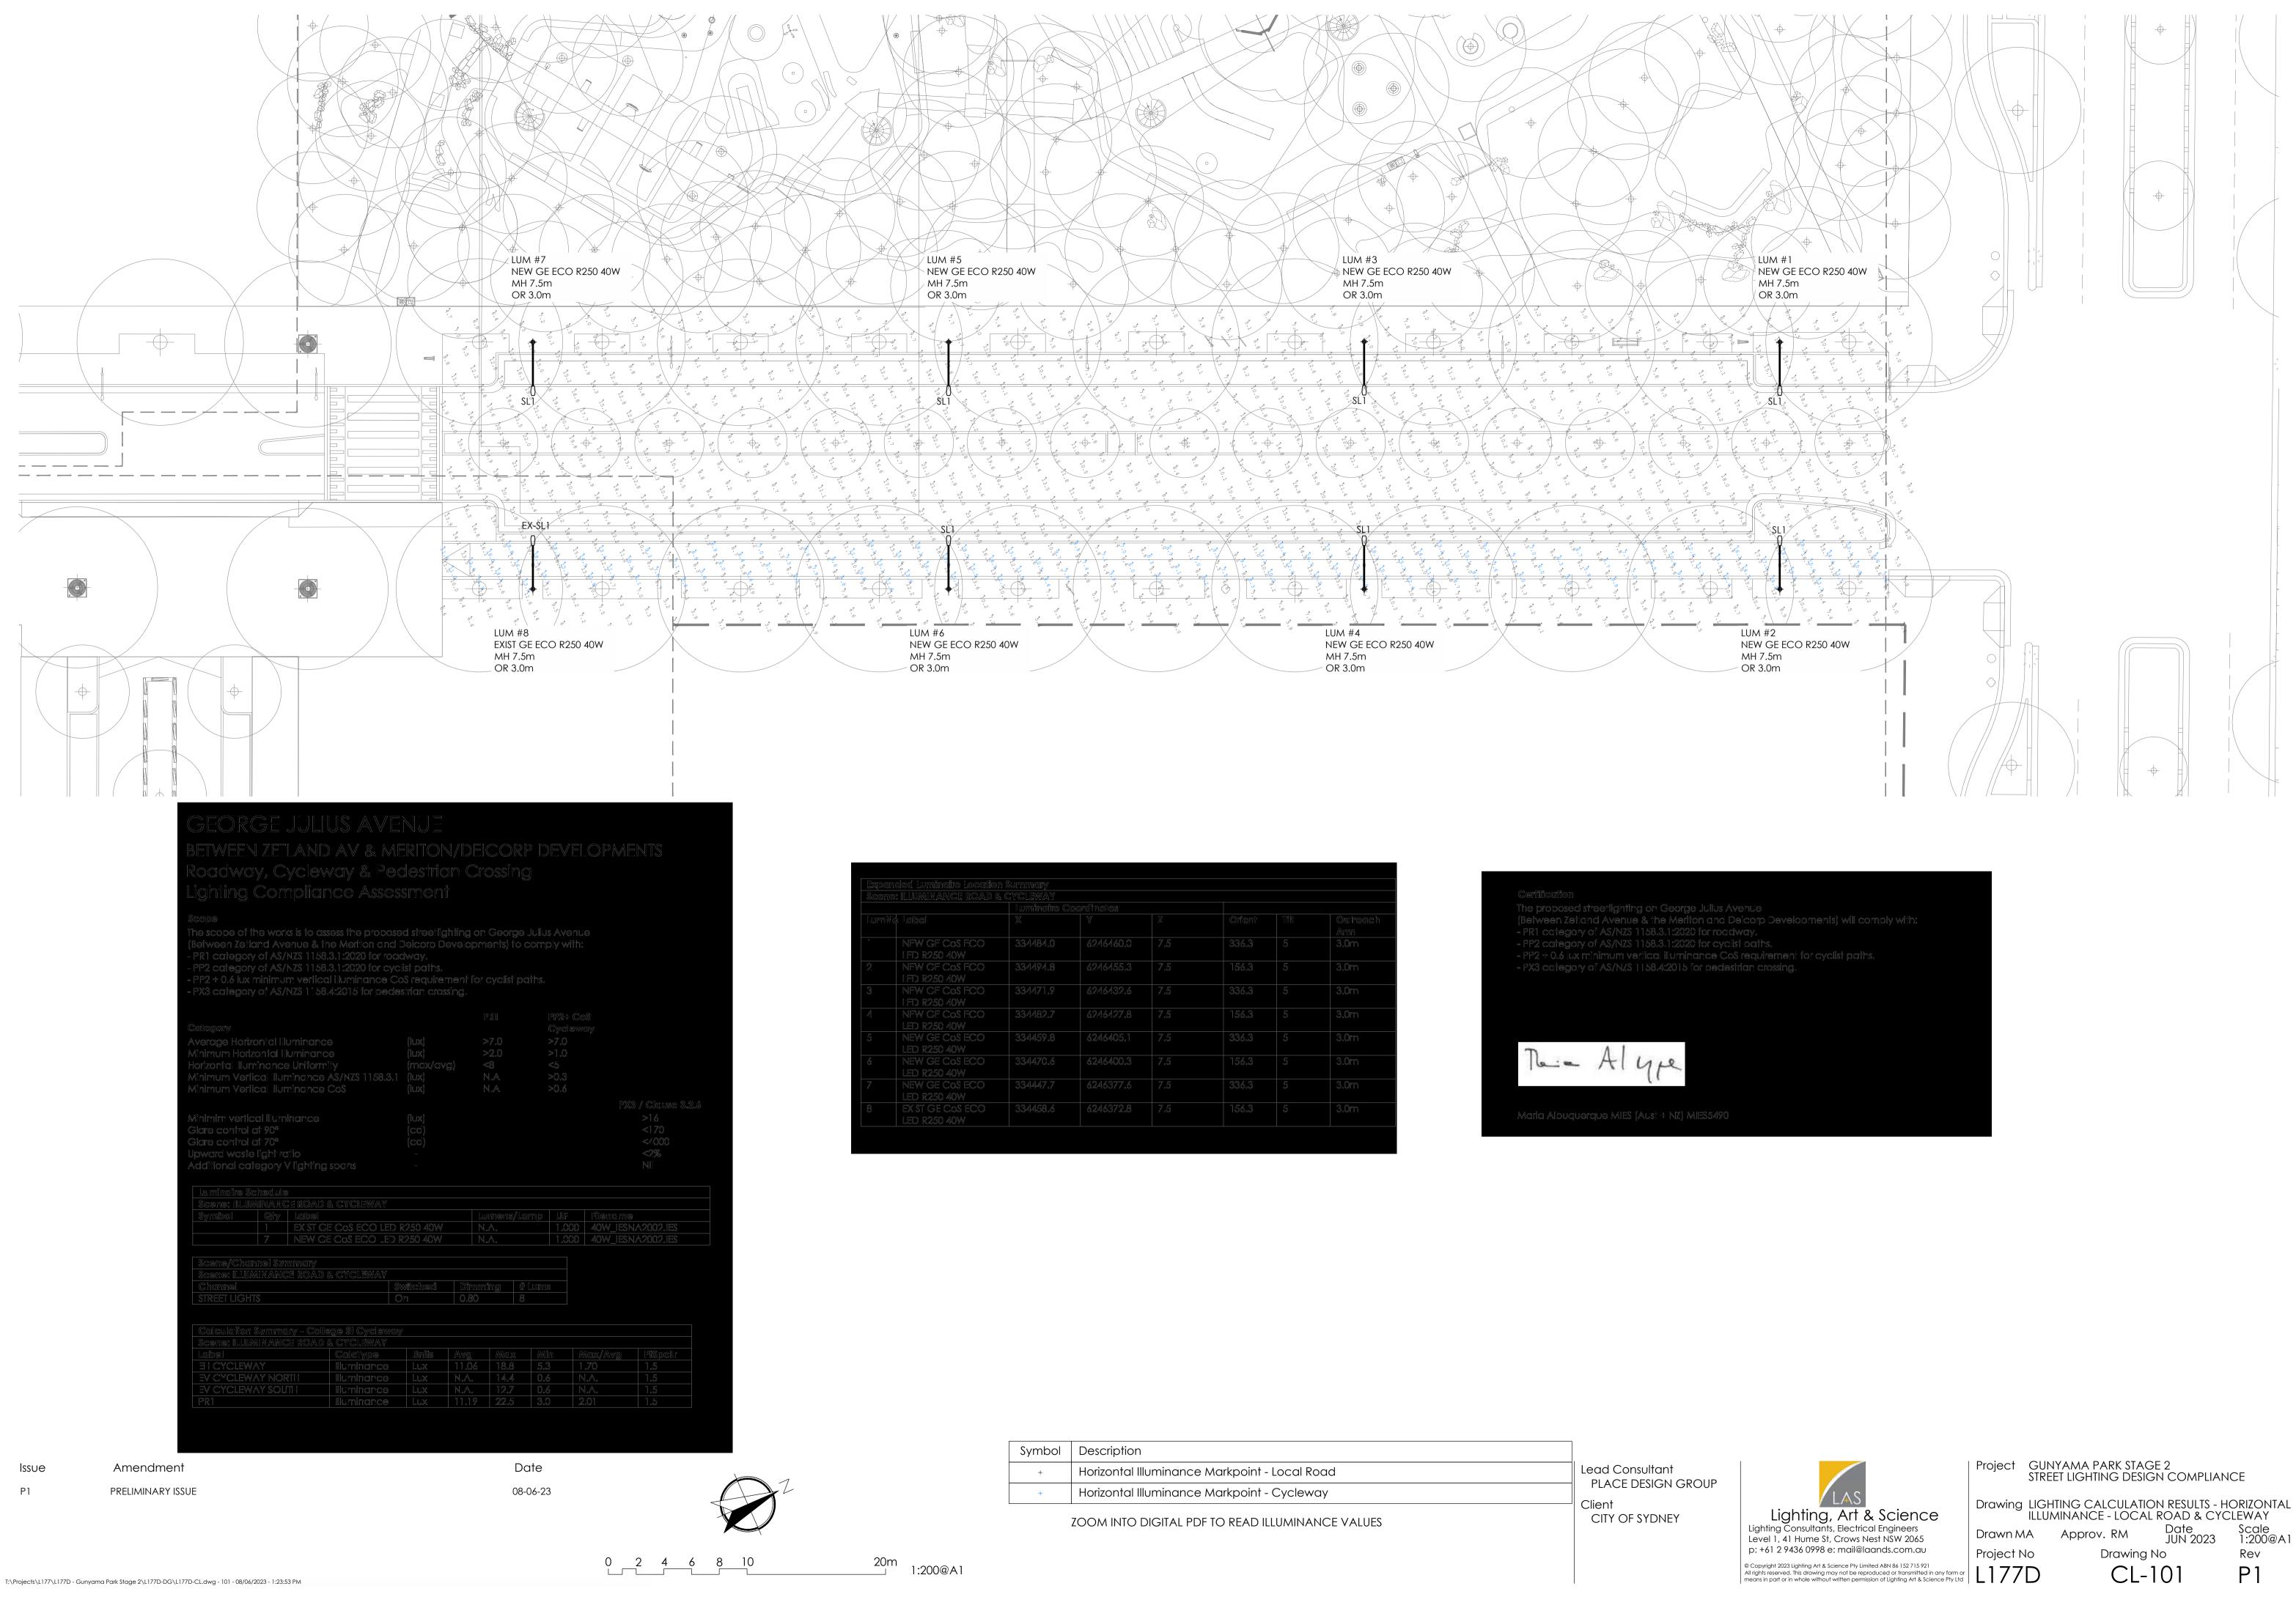

Expan	ded Luminaire Locatior) Summary					
Scene	ILLUMINANCE ROAD &	CYCLEWAY					
		Luminaire C	oordinates				
umNe	label	X	Y	72	Orfent	TîKi	Outreach Arm
er 	NEW GE CoS ECO LED R250 40W	334484.0	6246460.0	7.5	336.3		3.0m
2	NFW GE CoS ECO LED R250 40W	334494.8	6246455.3	7.5	156.3	5	3.0m
3	NEW GE CoS ECO LED R2.50 40W	334471.9	6246432.6	7.5	336.3	5	3.0m
4	NFW GE CoS ECO LED R250 40W	334482.7	62464.27.8	7.5	156.3	5	3.0m
5	NEW GE CoS ECO LED R250 40W	334459.8	6246405.1		336.3		3.0m
5	NEW GE CoS ECO LED R250 40W	334470.6	6246400.3	7.5	156.3	5	3.0m
7	NEW GE COS ECO LED R250 40W	334447.7	6246377.6	7.5	336.3	5	3.0m
3	EX.ST GE CoS ECO LED R250 40W	334458.6	6246372.8	7.5	156.3	5	3.0m

Certification The proposed s (Between Zetla - PR1 category - PP2 category - PP2 ÷ 0.6 lux n - PX3 category	nd Avenu of AS/NZS of AS/NZS ninimum v	ue & the Meri 5 1158.3.1:202 5 1158.3.1:202 /eritical illumir	ton and Deic 0 for roadwa 0 for cyclist p hance CoS re
- PP2 + 0.6 lux n	ninimum v of AS/NZS	veriical illumir 5 1158.4:2015	nance Cos re
Maria Albuque		(,	MIES5490


Sym	bol Description	
-	Horizontal Illuminance Markpoint - Local Road	Lead Consultant
-	Horizontal Illuminance Markpoint - Cycleway	PLACE DESIGN GROUP
		Client

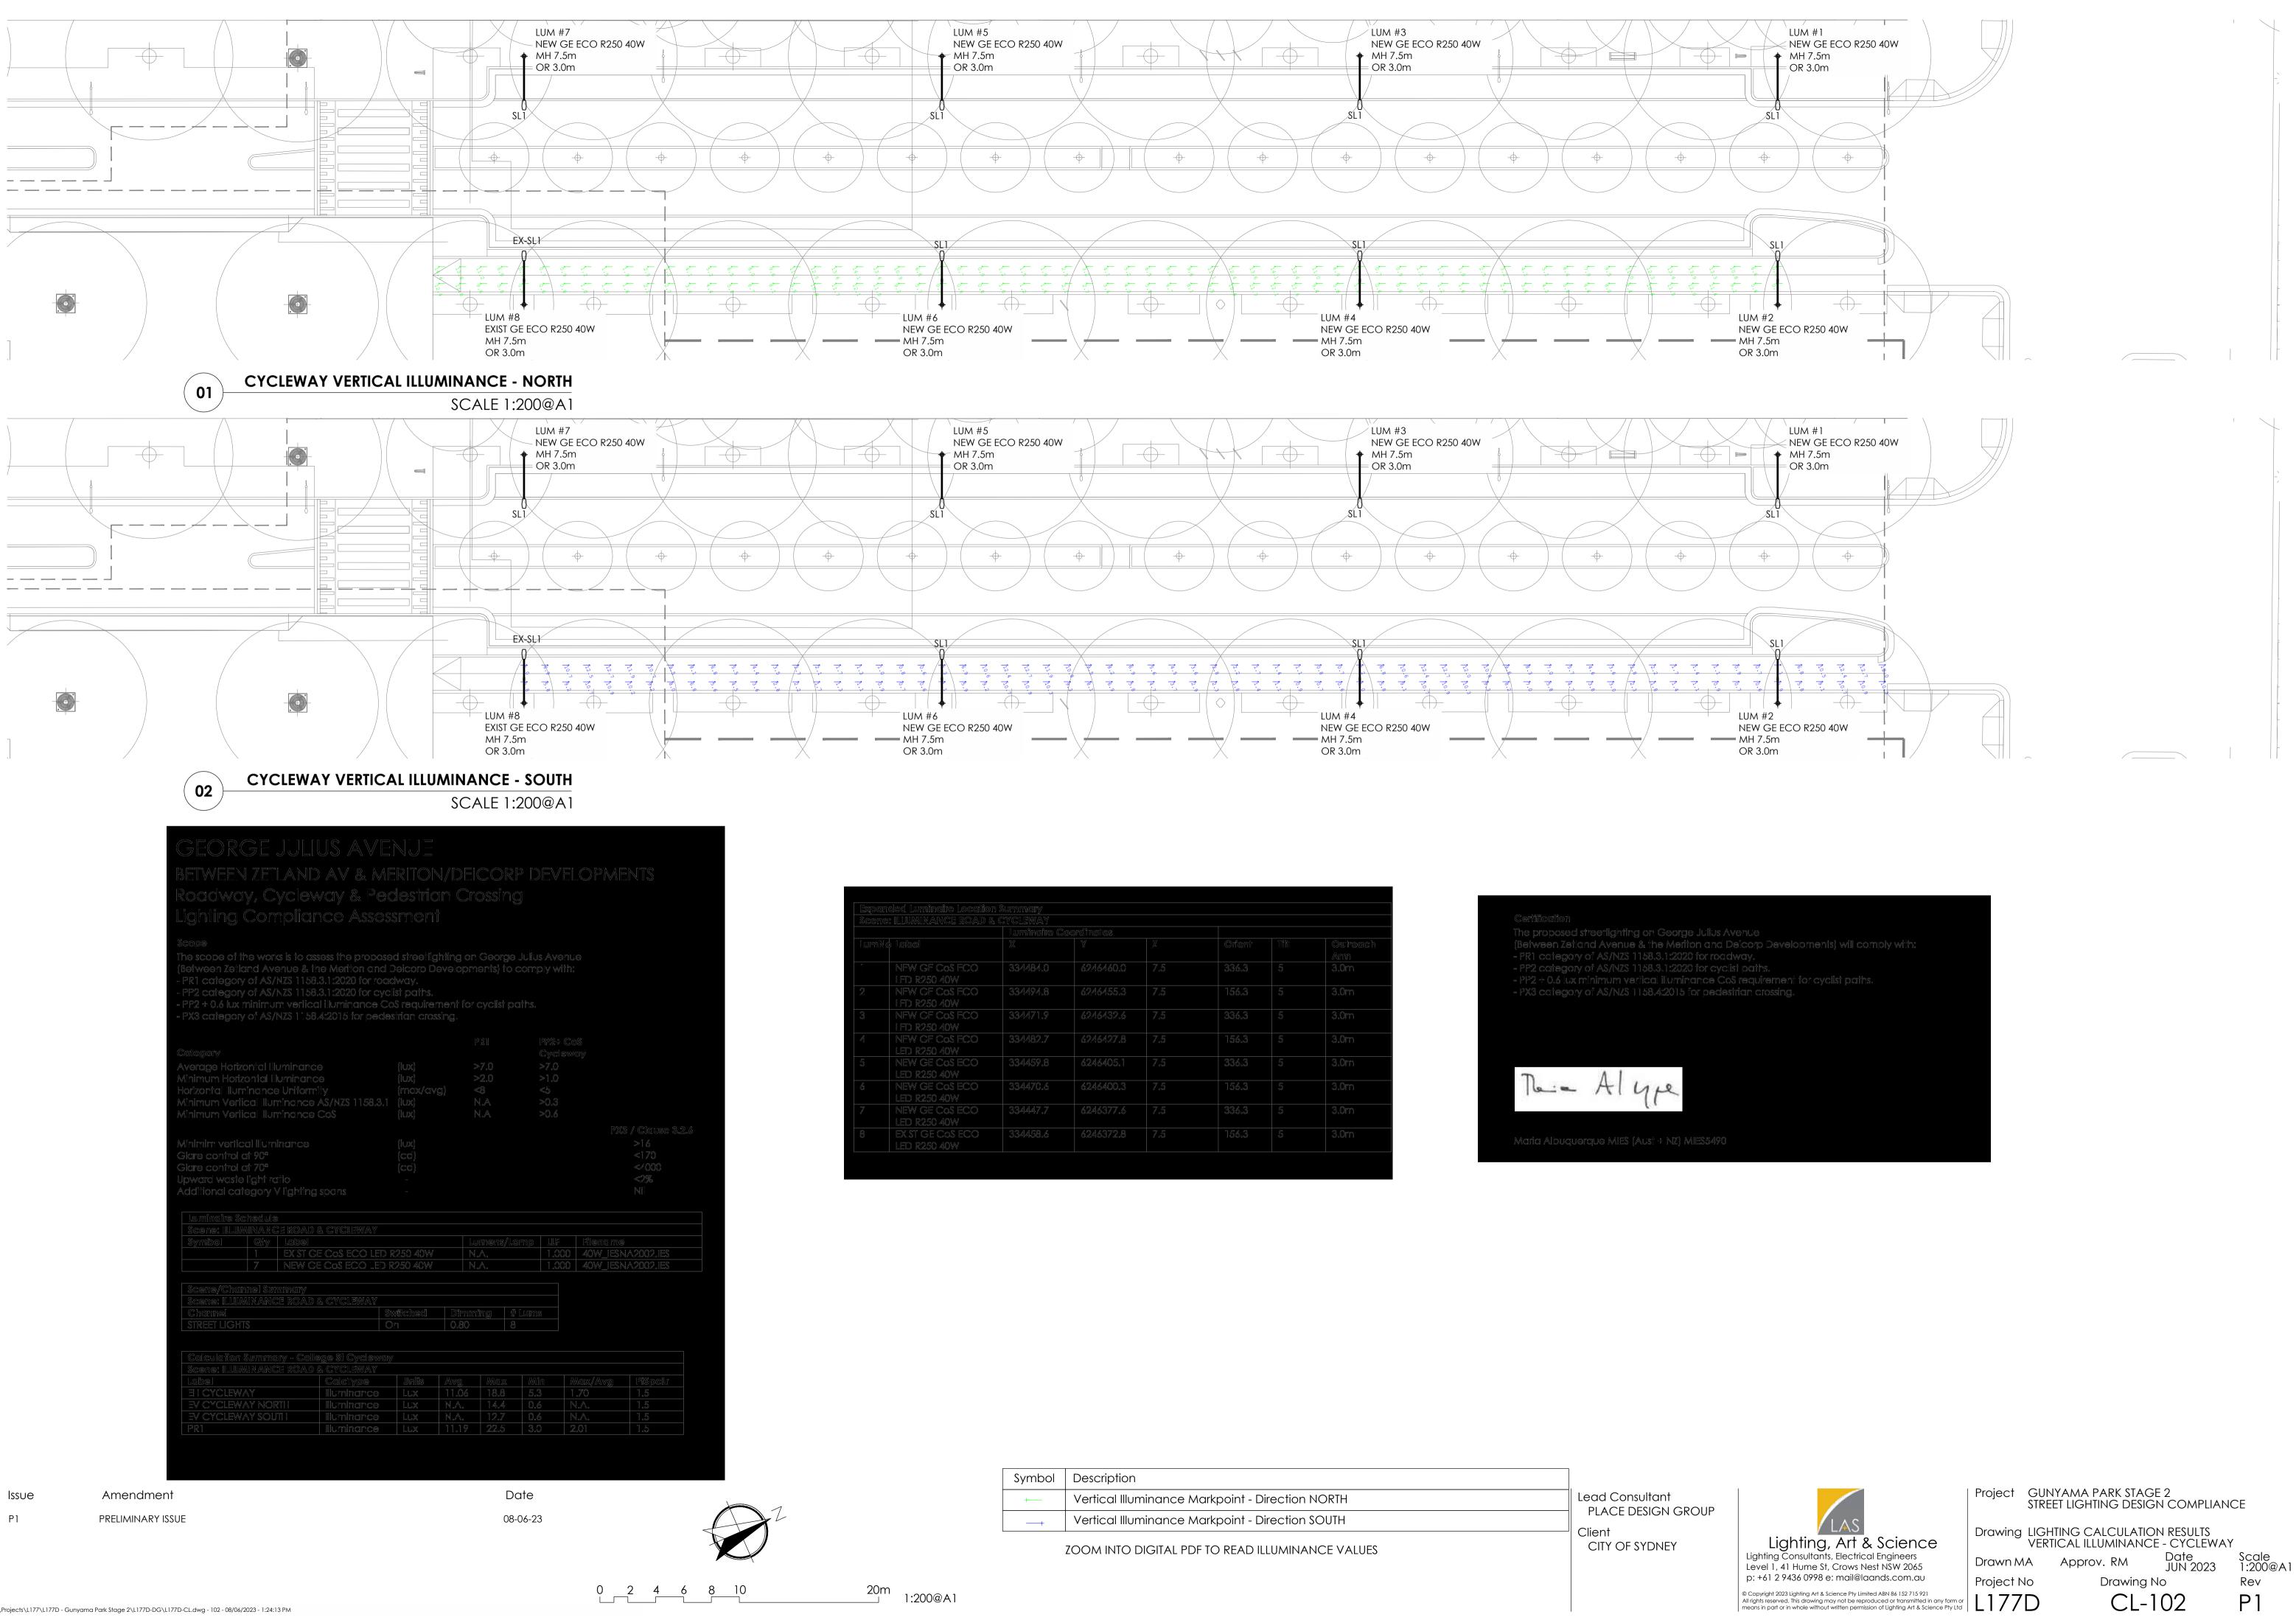

Exroant	ded Luminaire Locatior	n Summaanv					
	: ILLUMINANCE ROAD &						
0001101		Luminaire C	oordinates				
l.umNc		×	Y		Orieni'		Outreach Arm
1	NFW GE CoS ECO LED R258 40W	334484.0	6246460.0	7.5	336.3		3.0m
2	NFW GE CoS ECO LED R258 40W	334494.8	6246455.3	7.5	156.3	5	3.0m
3	NFW GE CoS ECO LED R250 40W	334471.9	62.46432.6	7.5	336.3	5	3.0m
A,	NFW GE CoS ECO LED R250 40W	334482.7	67,464,97.8	7.5	156.3		3.0m
5	NEW GE COS ECO LED R250 40W	334459.8	6246405.1		336.3		3.0m
6	NEW GE CoS ECO LED R250 40W	334470.6	6246400.3	7.5	156.3	5	3.0m
7	NEW GE CoS ECO LED R250 40W	334447.7	6246377.6	7.5	336.3	5	3.0m
8	EXIST GE COS ECO LED R250 40W	334458.6	6246372.8	7.5	156.3	5	3.0m


Certification The proposed streetlighting on George Julius Aver (Between Zetland Avenue & the Meriton and Deid - PR1 category of AS/NZS 1158.3.1:2020 for roadwa - PP2 category of AS/NZS 1158.3.1:2020 for cyclist p - PP2 + 0.6 lux minimum vertical illuminance CoS re - PX3 category of AS/NZS 1158.4:2015 for pedestric
Te- Alype
Maria Albuquerque MIES (Aust + NZ) MIES5490

Symbol	Description	
+	Vertical Illuminance Markpoint - Direction NORTH	Lead Consultant
+	Vertical Illuminance Markpoint - Direction SOUTH	PLACE DESIGN GROUP
		Client

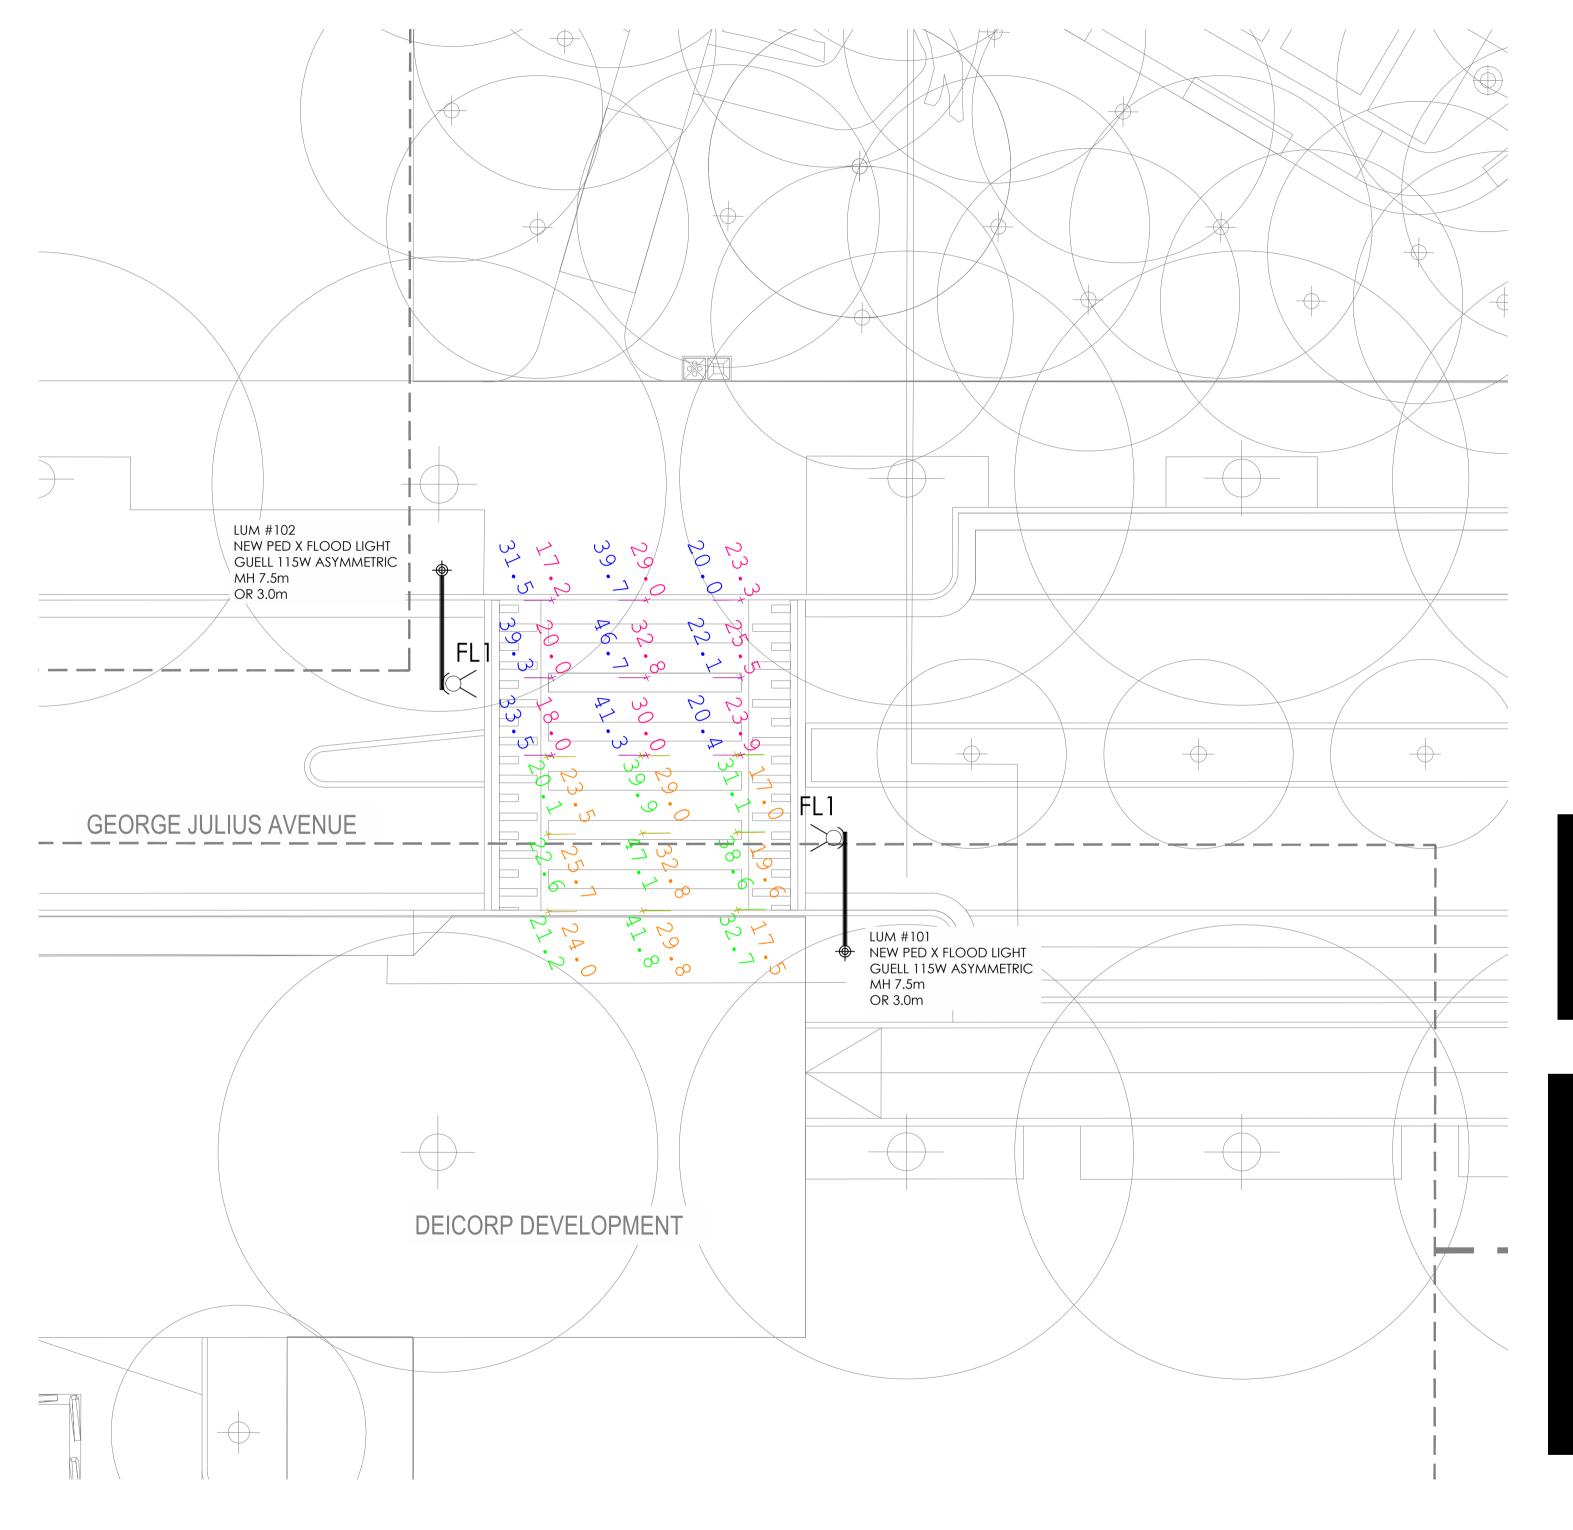

Issue	Amendment
P1	PRELIMINARY ISSUE



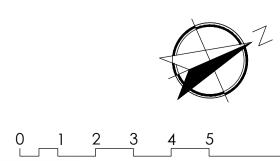

Provide an advenue & the Merfion and Deicorp Developments) to comply with: R1 category of AS/NZS 1158.3.1:2020 for roadway. P2 category of AS/NZS 1158.3.1:2020 for cyclist paths. P2 + 0.6 lux minimum vertical illuminance Cos requirement for cyclist paths.

		PRI	PP2+ CoS Cyclewdy	
Average Horizontal Illuminance	(lux)	>7.0	>7.0	
Minimum Horizontal Illuminance	(lux)	>2.0	>1.0	
Horizontal Illuminance Uniformity	(max/avg)	<8	<5	
Minimum Vertical Iluminance AS/NZS 1158.3.1		N.A	>0.3	
Minimum Verlical Illuminance CoS	(lux)	N.A	>0.6	
				PX3 / Clause 3.2.6
Minimim vertical illuminance	(lux)			>7.0
Glare control at 90°	(cd)			>1.0
Glare control at 70°	(cd)			<5
Upward waste light ratio				>0.3
Additional category V lighting spans				>0.6
Luminaire Schedule				
Scene: Illuminance ped X				

- oy muser	~~~~~~~//	Li Kau laan taan taan ji						of centrals			11191101110
	2	PEDX G	uell2 115W LE	12115W LED 4000K		8933.71		1.00	00	173105-Cuell2-114W-LED-	
		ASYMM									4000K-Asymm-WB.ies
Scene/Chan	nel Sur	nmary									
Scene: ILLUM											
					tiched	Dîr	nming	# Lums			
PED X LIGHTS	0			On		0.8	3.447	2			
Calculation S											
Project: PX3 (
Scene: ILLUM	INANC	se ped X									
Label			Calciype		Units	Min	Leg	jend			
PX3 NORTH C	GROUN	D	Illuminance		Lux	17.0	*				
PX3 SOUTH G	ROUN	0	Illuminance		Lux	17.2					
Calculation S			ge St Cyclew								
Project: PX3 (
Scene: ILLU/M											
Label			Calcivoe				Lea	iend			

Expend	led Luminaire Location §	Summery					
Scene:	ILLUMINANCE PED X						
LumNo	label	*	Ŷ	Z	Orient	TÎLA	Ouireach Arm
101	PFDX Cueil2 115W LED 4000K ASYMM	334451.5	62.46369.9	7.5	66	0	3.0m
102	PEDX Cueil2 115W LED 4000K ASYMM	334443.4	62.46361.8	7.5	2.4.6	0	3.0m

K3 KORTH I S50mm — Illuminance Lux 20.1 * K3 SOUTH 1 500mm — Illuminance Lux 20.0 -



Glare Contro	77D-CL01-PEDX & ROAD				
Luminous Intensity (Cd) Per Luminaire Maximum Allowable Value: 4000 Cd Control Angle: 70 Degrees					
Luminaire Lo Test Results	cations Tested (2) : PASS				
All Luminaire	Locations (2):				
Lum.No. 101 102	i.abai PEDX Guell2 115W LED 4000K ASYMM PEDX Guell2 115W LED 4000K ASYMM	Cd 904 904	Tillî O O	Ro11 0 0	Spii 180 180
	/aste Light Ratio (UW/LIR)) owable Value: 2.0 %				
Calculated U Test Results					

Glare Contro Filename: L'	Obtrusive Light - Compliance Report Glare Control at 90deg Filename: L177D-CL01-PEDX & ROAD 5/06/2023 4:39:12 PM						
Maximum Al	Luminous Intensity (Cd) Per Luminaire Maximum Allowable Value. 170 Cd Control Angle: 90 Degrees						
Luminaire Lo Tost Results	ocations Tested (2) s: PASS						
All Luminairs	All Luminaire Locations (2):						
Lum.No. 101 102	Labol PEDX Guell2 115W LED 4000K ASYMM PEDX Guell2 115W LED 4000K ASYMM	Cd 0 0	Tik O O	Roll 0 0	Spin 180 180		
Upward Waste Light Ratio (UWLR) Maximum Allowable Value: 2.0 %							

'est Results: **PASS**



Project GUNYAMA PARK STAGE 2 STREET LIGHTING DESIGN COMPLIANCE

Drawing LIGHTING CALCULATION RESULTS PEDESTRIAN CROSSING Date JUN 2023 Approv. RM Drawn MA Drawing No Project No L177D


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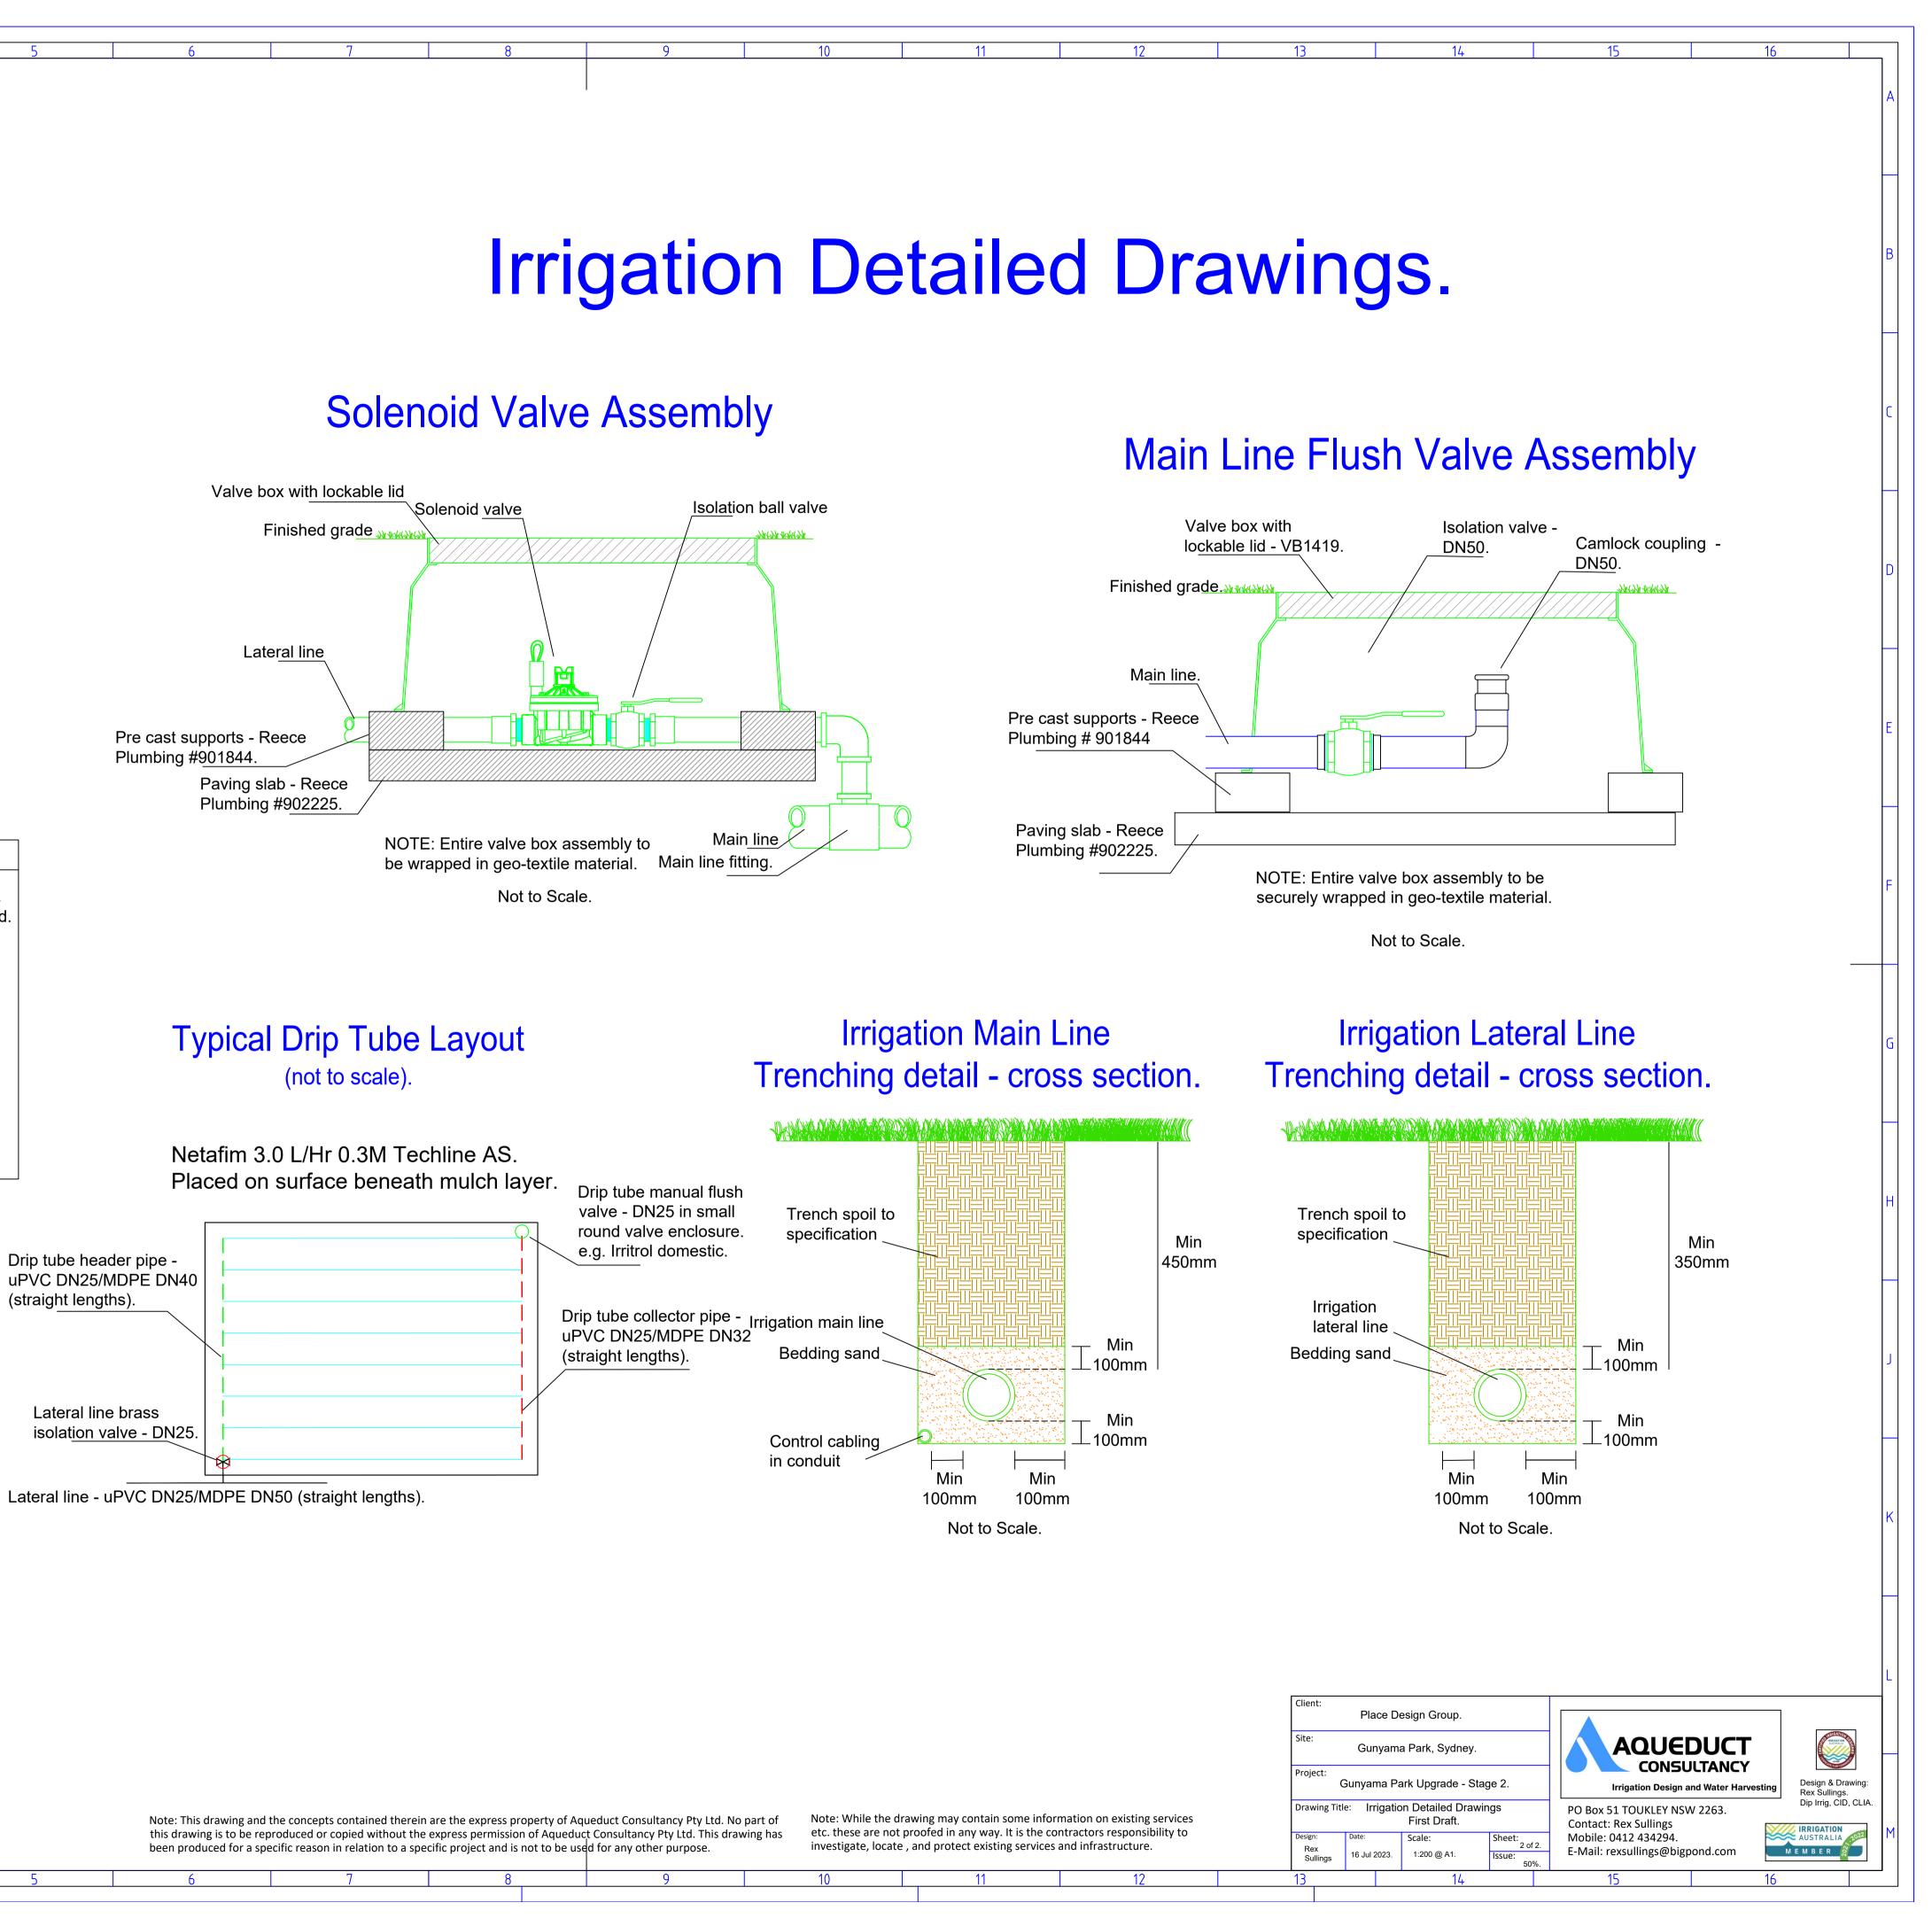



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e:		esign Group.			DUCT	Sector and the sector	
oject:		a Park, Sydney.		CONS	ULTANCY		
(awing Titl		ark Upgrade - St tion Detailed Des		Irrigation Design	and Water Harvesting	g Design & Drawing: Rex Sullings. Dip Irrig, CID, CLIA	.
sign:	Date:	First Draft.	Sheet: 1 of 2.	Contact: Rex Sullings Mobile: 0412 434294.		IRRIGATION AUSTRALIA	М
Rex Sullings	16 Jul 2023.	1:200 @ A1. 14	Issue: 50% - issue.	E-Mail: rexsullings@big 15	gpond.com	MEMBER	
		1.0					








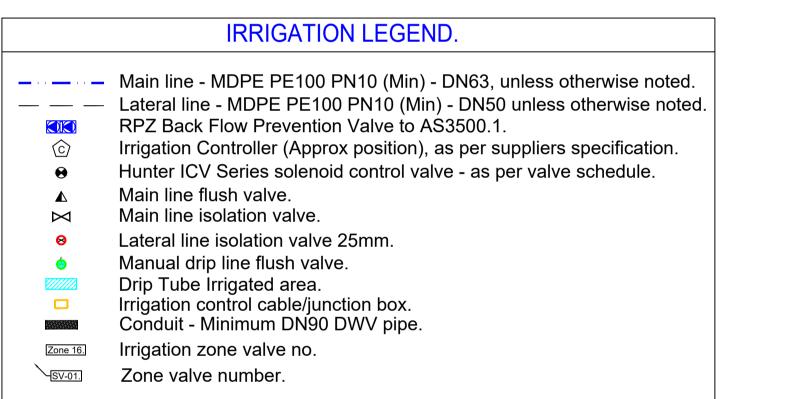

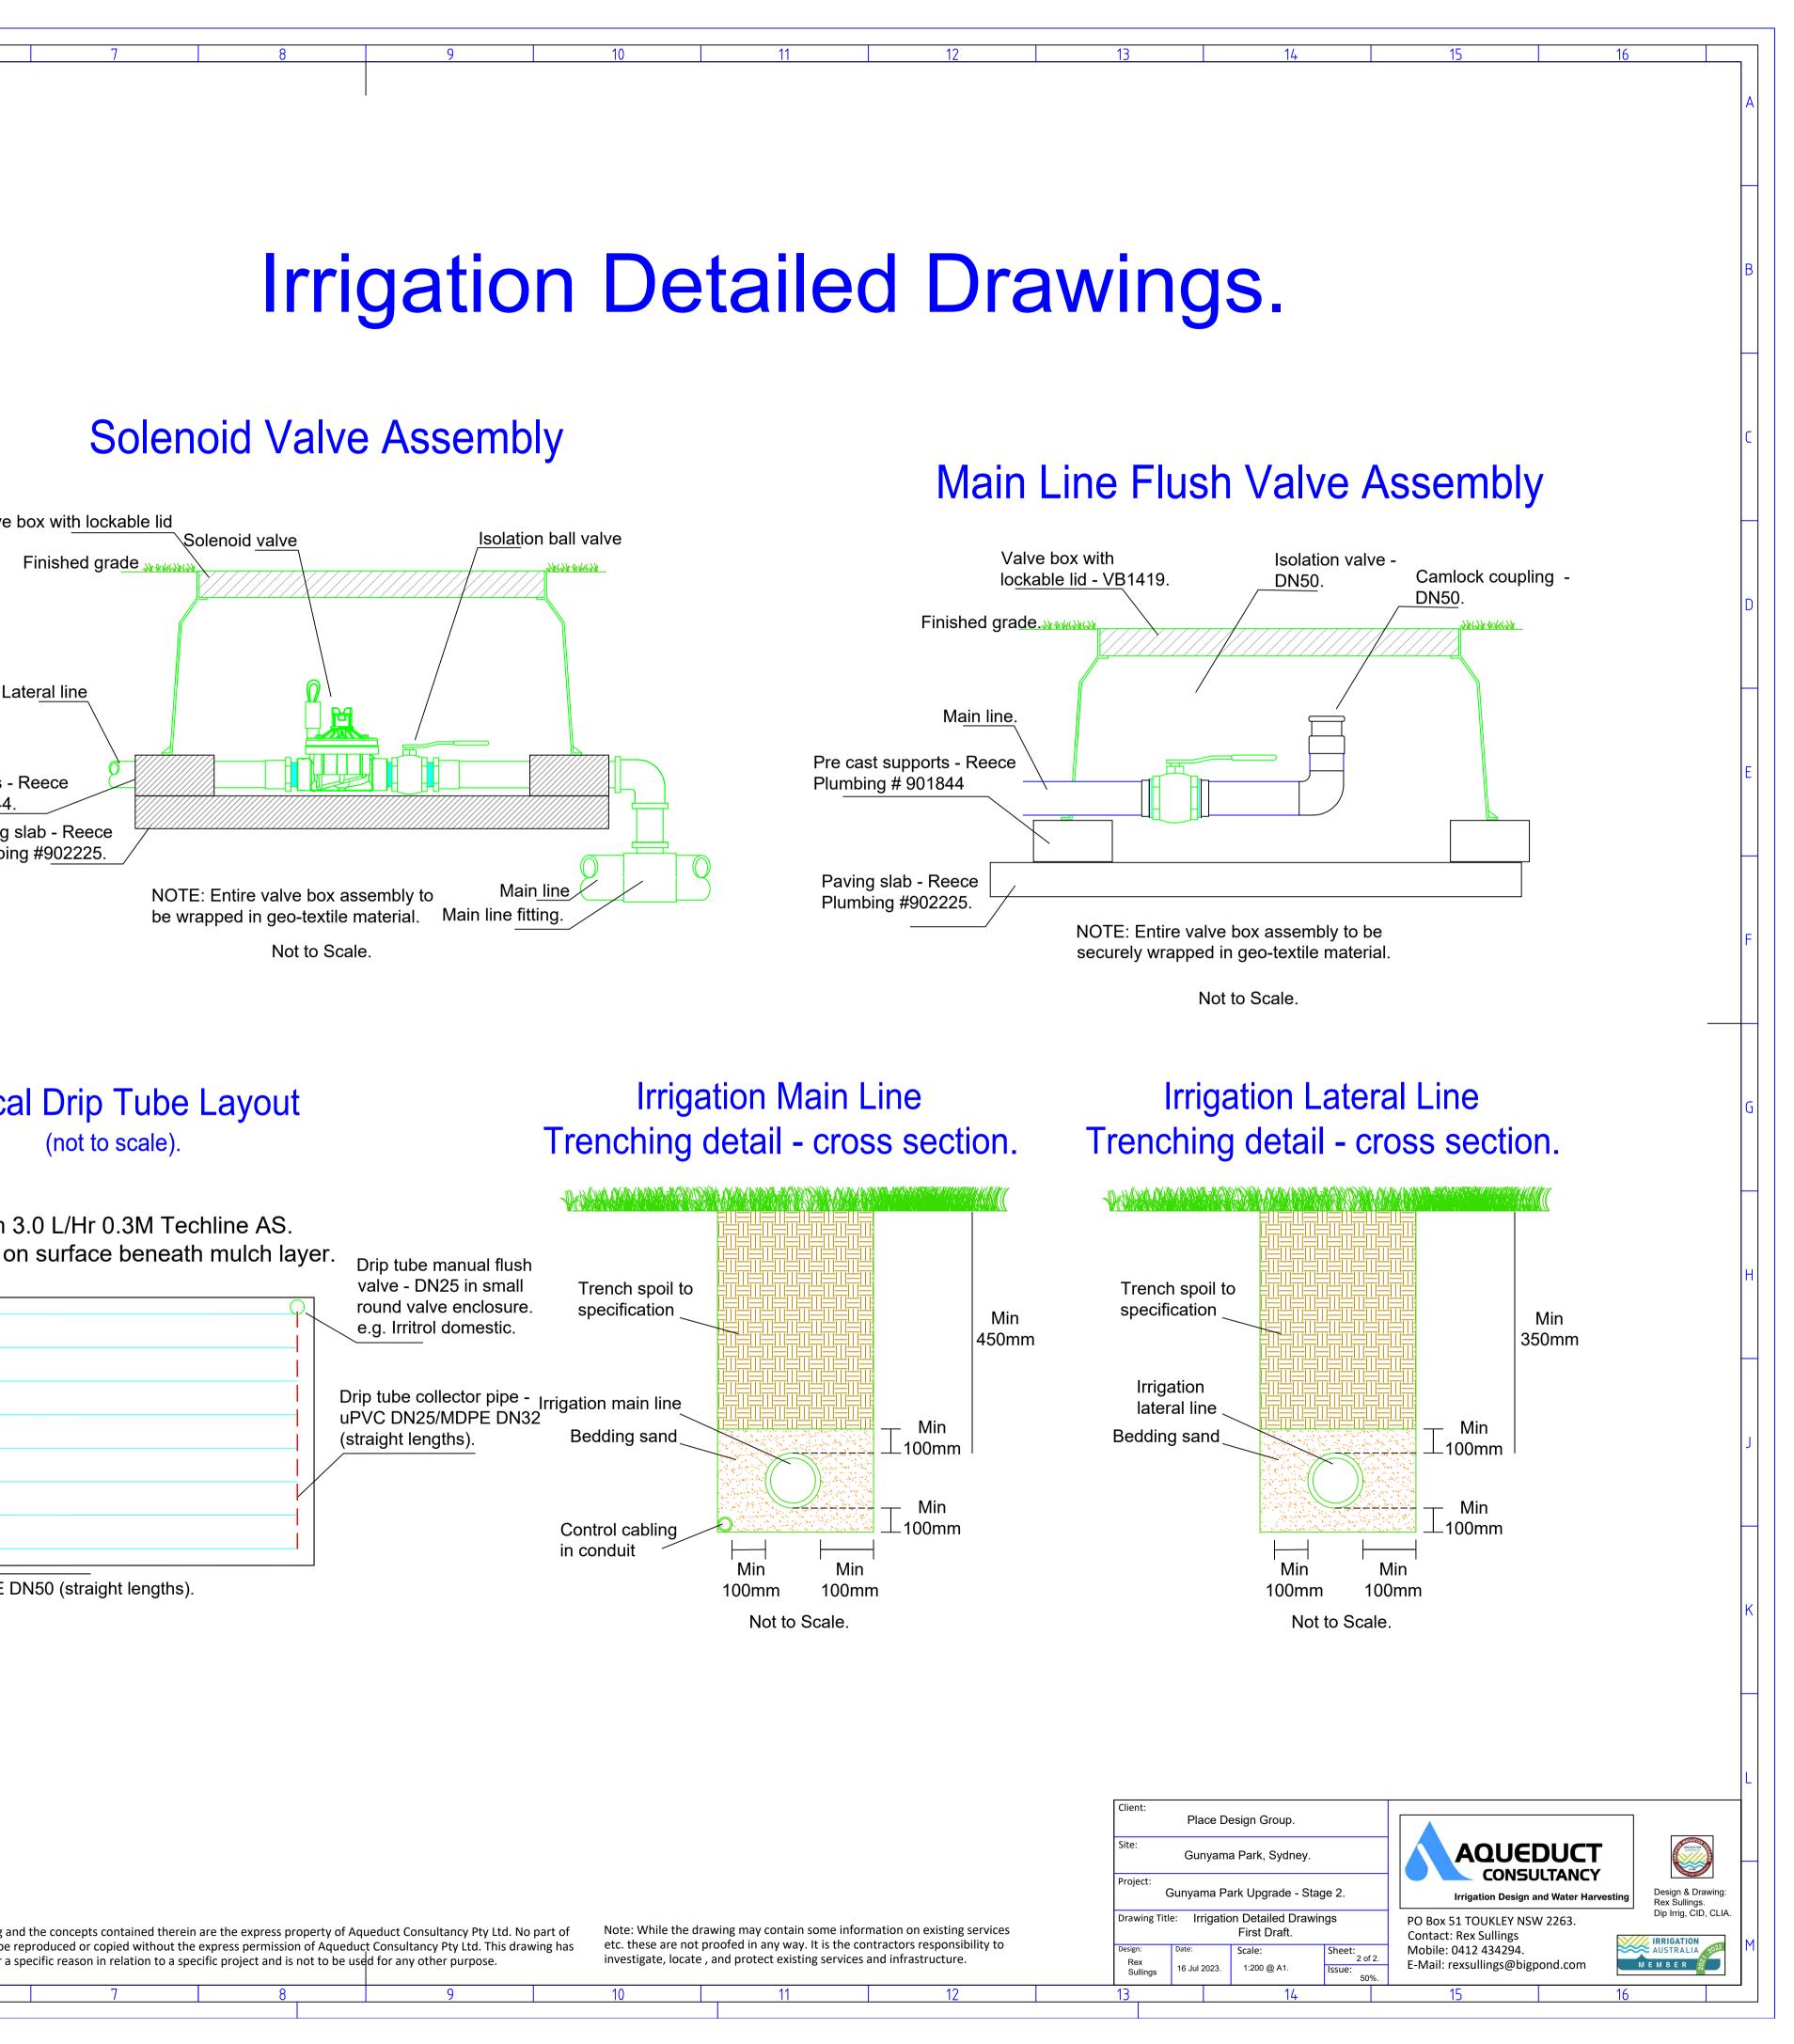

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GUNYAMA PARK FOR PLACE DESIGN GROUP 7106GP01

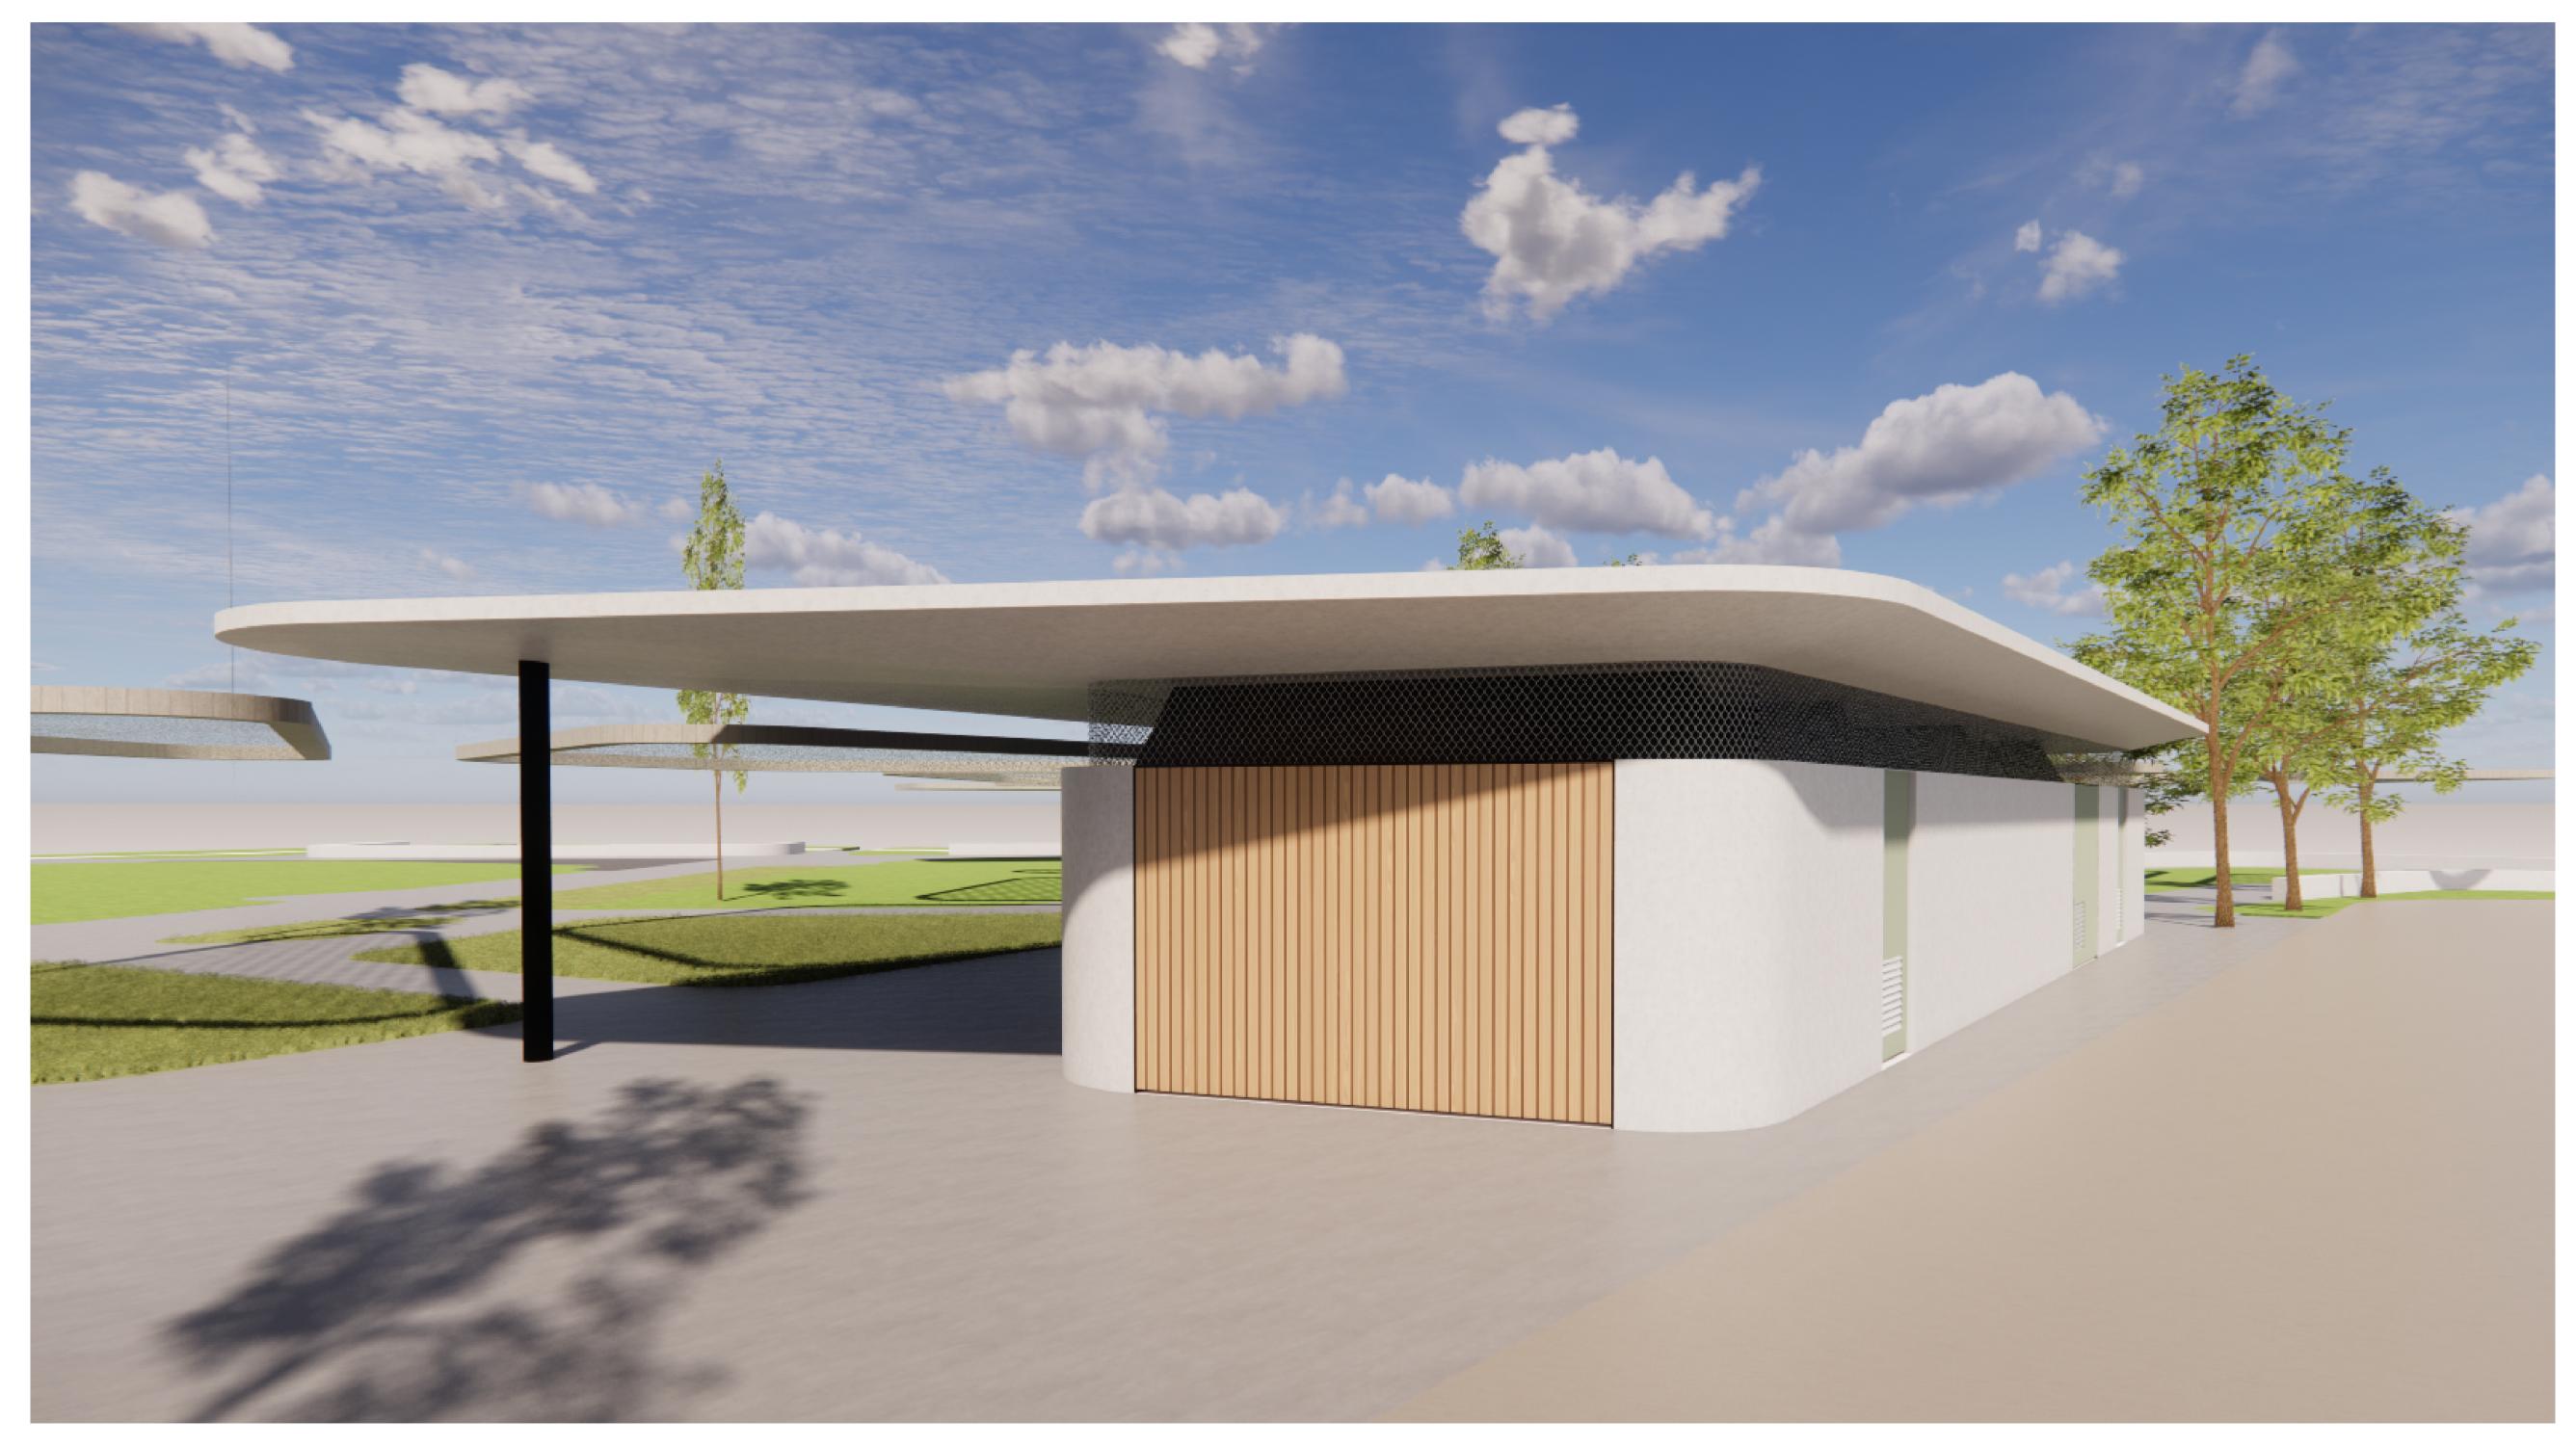

Drawing No.	Drawing Name	Rev
ACD-101	PROPOSED SITE PLAN	01
ACD-200	FLOOR PLAN	01
ACD-203	CEILING PLAN	01
ACD-204	ROOF PLAN	01
ACD-301	ELEVATION	01
ACD-302	SECTION	01
ACD-501	ROOM LAYOUT 1	01
ACD-502	ROOM LAYOUT 2	01
ACD-601	DOOR SCHEDULE	01

DRAWING & SPECIFICATION MATERIAL CODE LEGEND

The Codes below represent the Specification Trade Section where detailed selection information is to be obtained for elements nominated in the drawings. The codes below will be followed by a two / three numeric trade selection reference for each different selection type.

TRADE SECTION	CODE
GENERAL Fire Stopping Termite Management Access Safety Systems	FS TM AS
SITE Landscape	LD
STRUCTURE Concrete Brick & Block Construction Structural Steel Light Steel Framing Timber Framing Decking & Flooring	CN MA SS SF TF FD
ENCLOSURE Waterproofing External Metal Roofing & Cladding Roof Tiling Cladding Glazing Doors, Windows & Hardware Insulation & Sarking Membranes	WE MR CL GL DW IS
INTERIOR Linings & Ceilings Joinery Metalwork Signs and display Miscellaneous Fitures Equipment & Appliances Furnishings & Furniture Hydraulic Fixtures	LC JY MW SD FX EQ FF HY
FINISH Rendering & Plastering Cementitious Toppings Waterproofing - Wet Areas Tiling Resilient finishes Carpets Painting Wall Coverings	RP CT WI TG RF CM PG WS

DRAWING & SPECIFICATION FINISHES / COLOUR CODES

The Codes below represent the Finish / Colour Type for the Specified Material Selections nominated in the drawings. The codes below will be followed by a two digit numeric reference for each different finish.

Acoustic Fabric Colour Brick Colour Block Colour Block Render Colorbond Concrete Finish Carpet Colour Epoxy Fabric Timber Flooring and Decking Laminate Landscape Metal Finishes Polycarbonate Paint Finish Stone Flooring Stone Joinery Element Timber Finishes Tiles - Wall / Floor Tiles - Roof Vinyl Wall Paper	AF BL CC EF BF LAD FC ST B TL TR N WP
Wall Coverings / Wall Paper	WS








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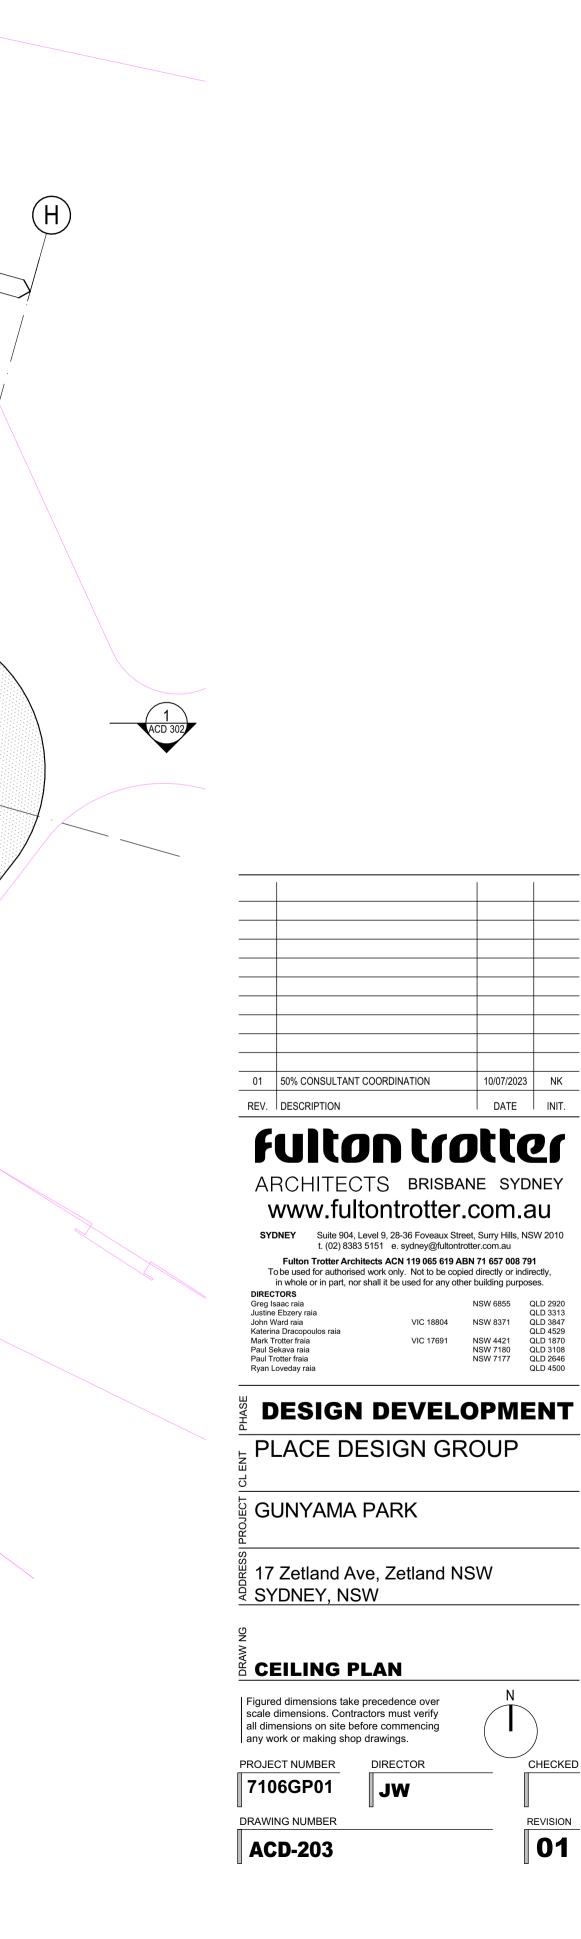
SITE PLAN LEGEND







LEGEND
DOOR LABEL
EXTERNAL WALL TYPE LABEL
INTERNAL WALL TYPE LABEL
TIL NG
EQUIPMENT AND APPLIANCE
HYDRAULIC FIXTURE
FURNISHING AND FURNITURE

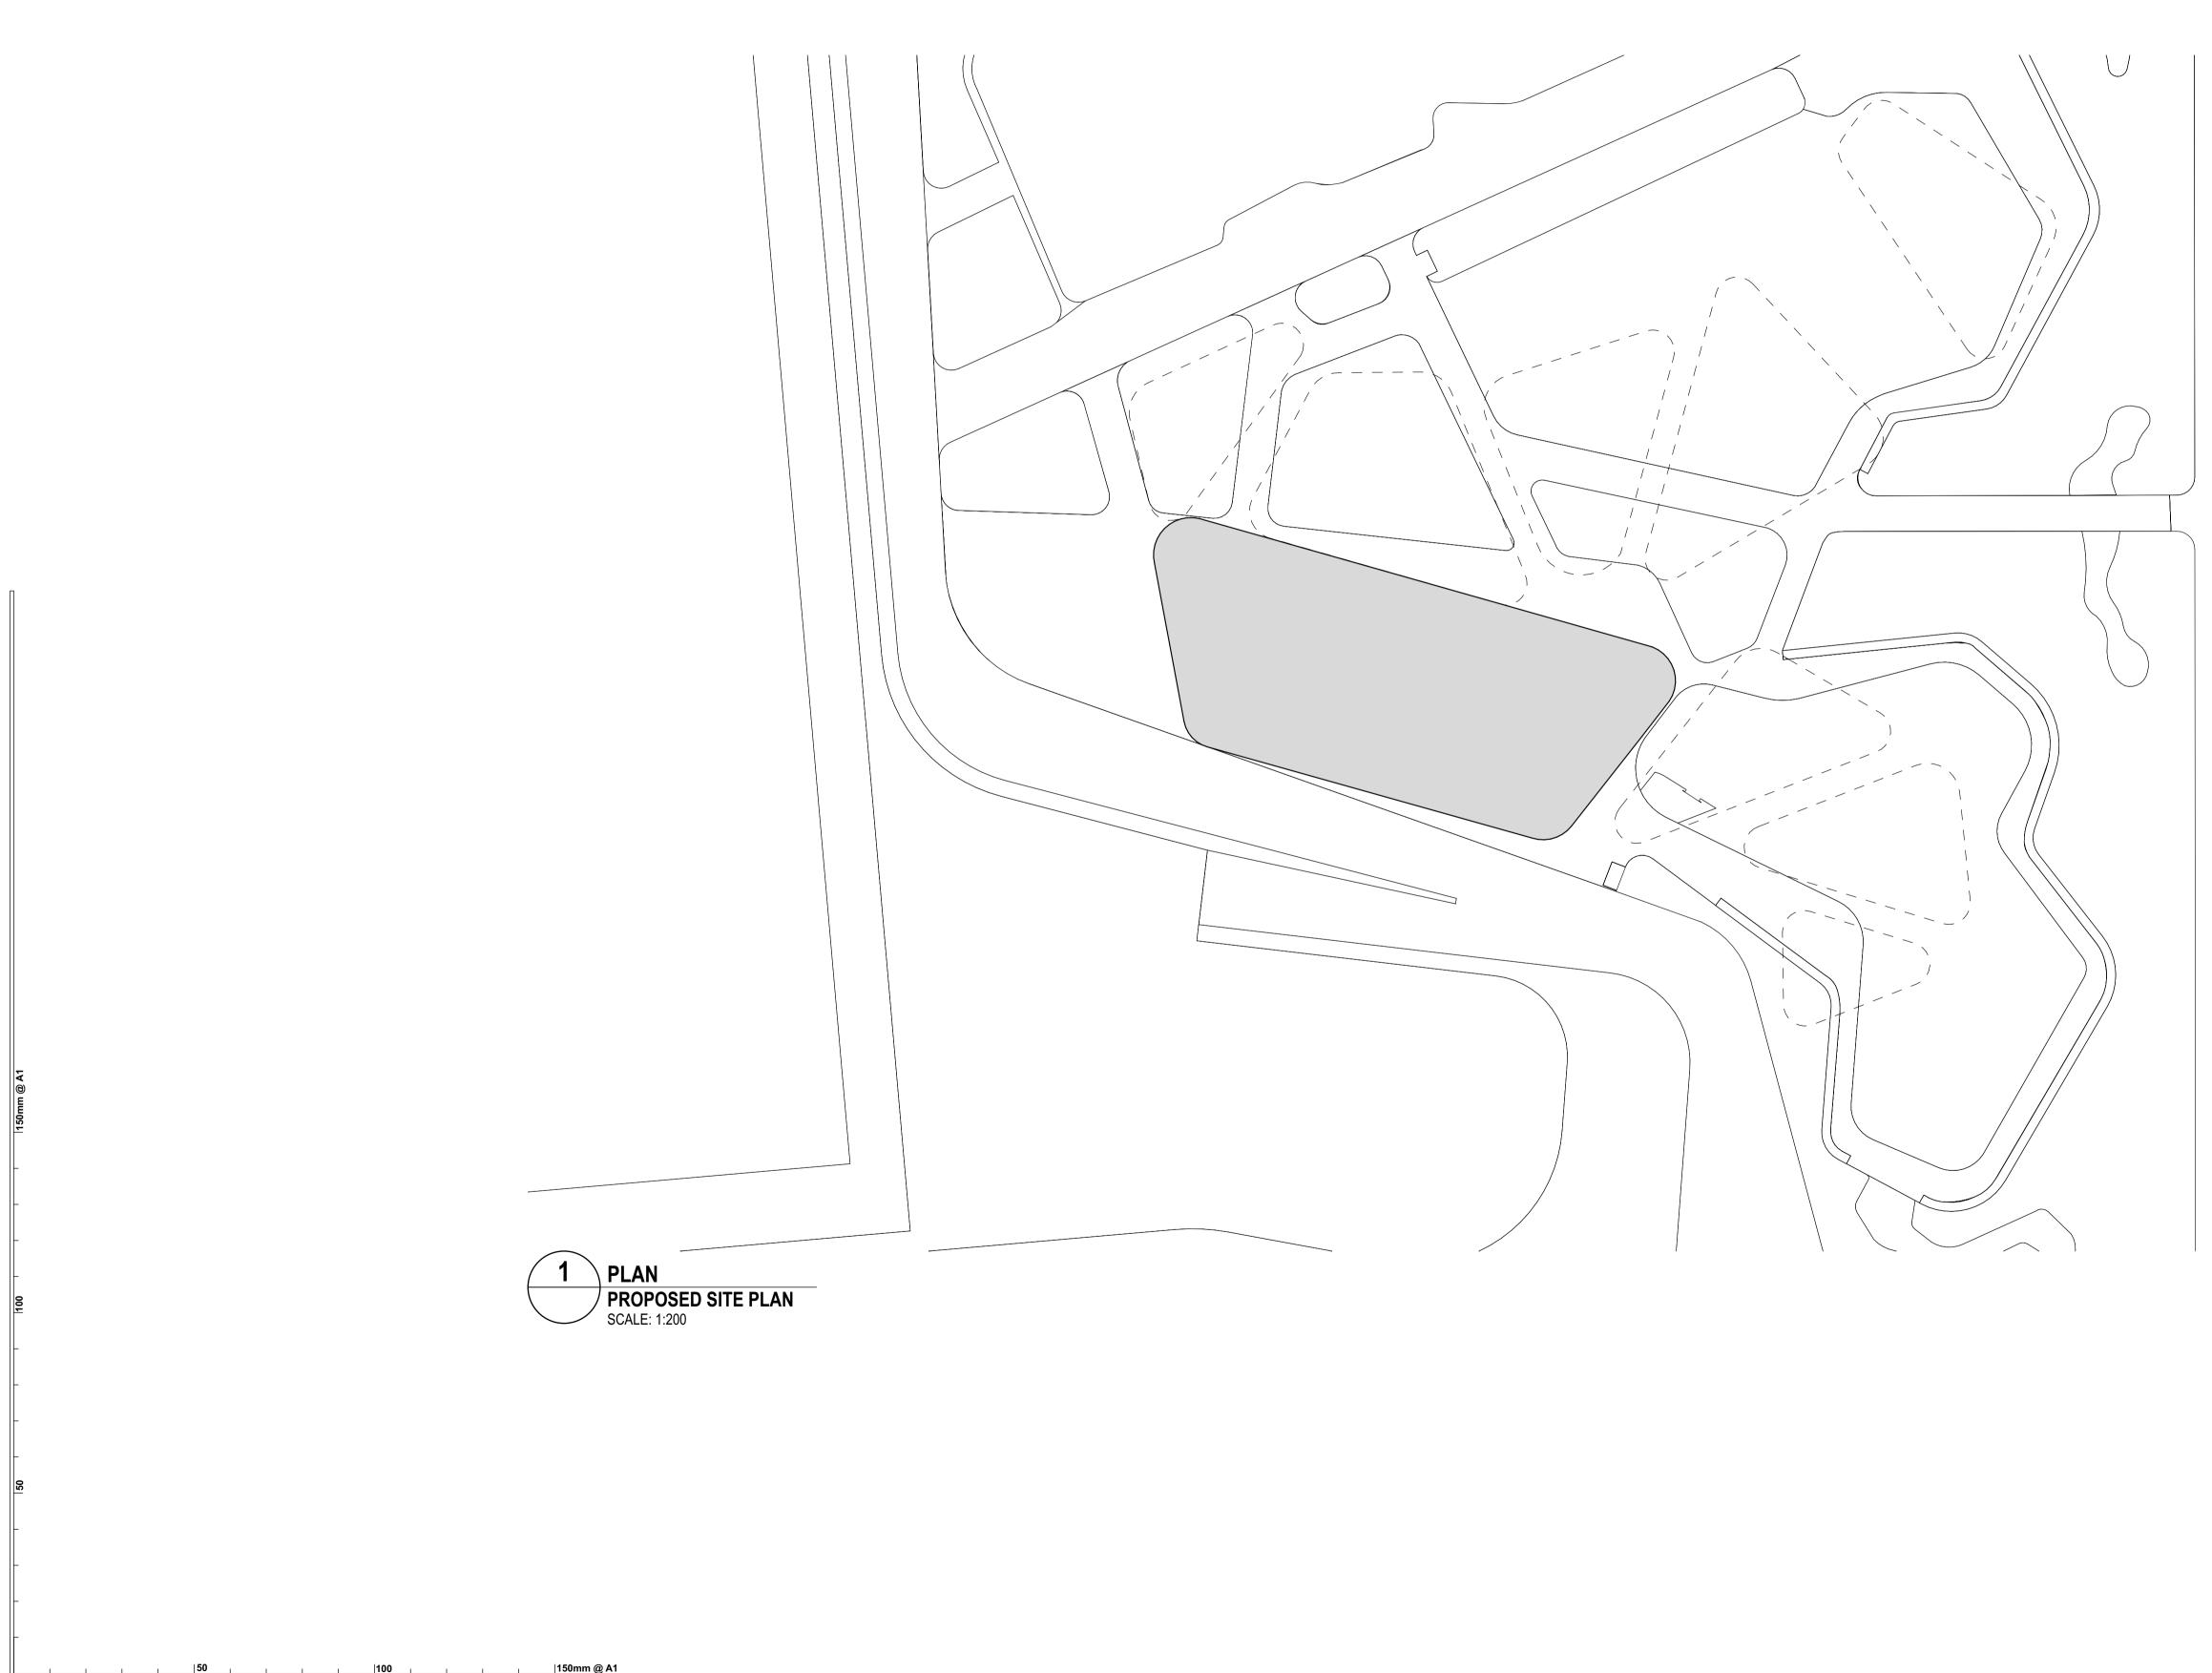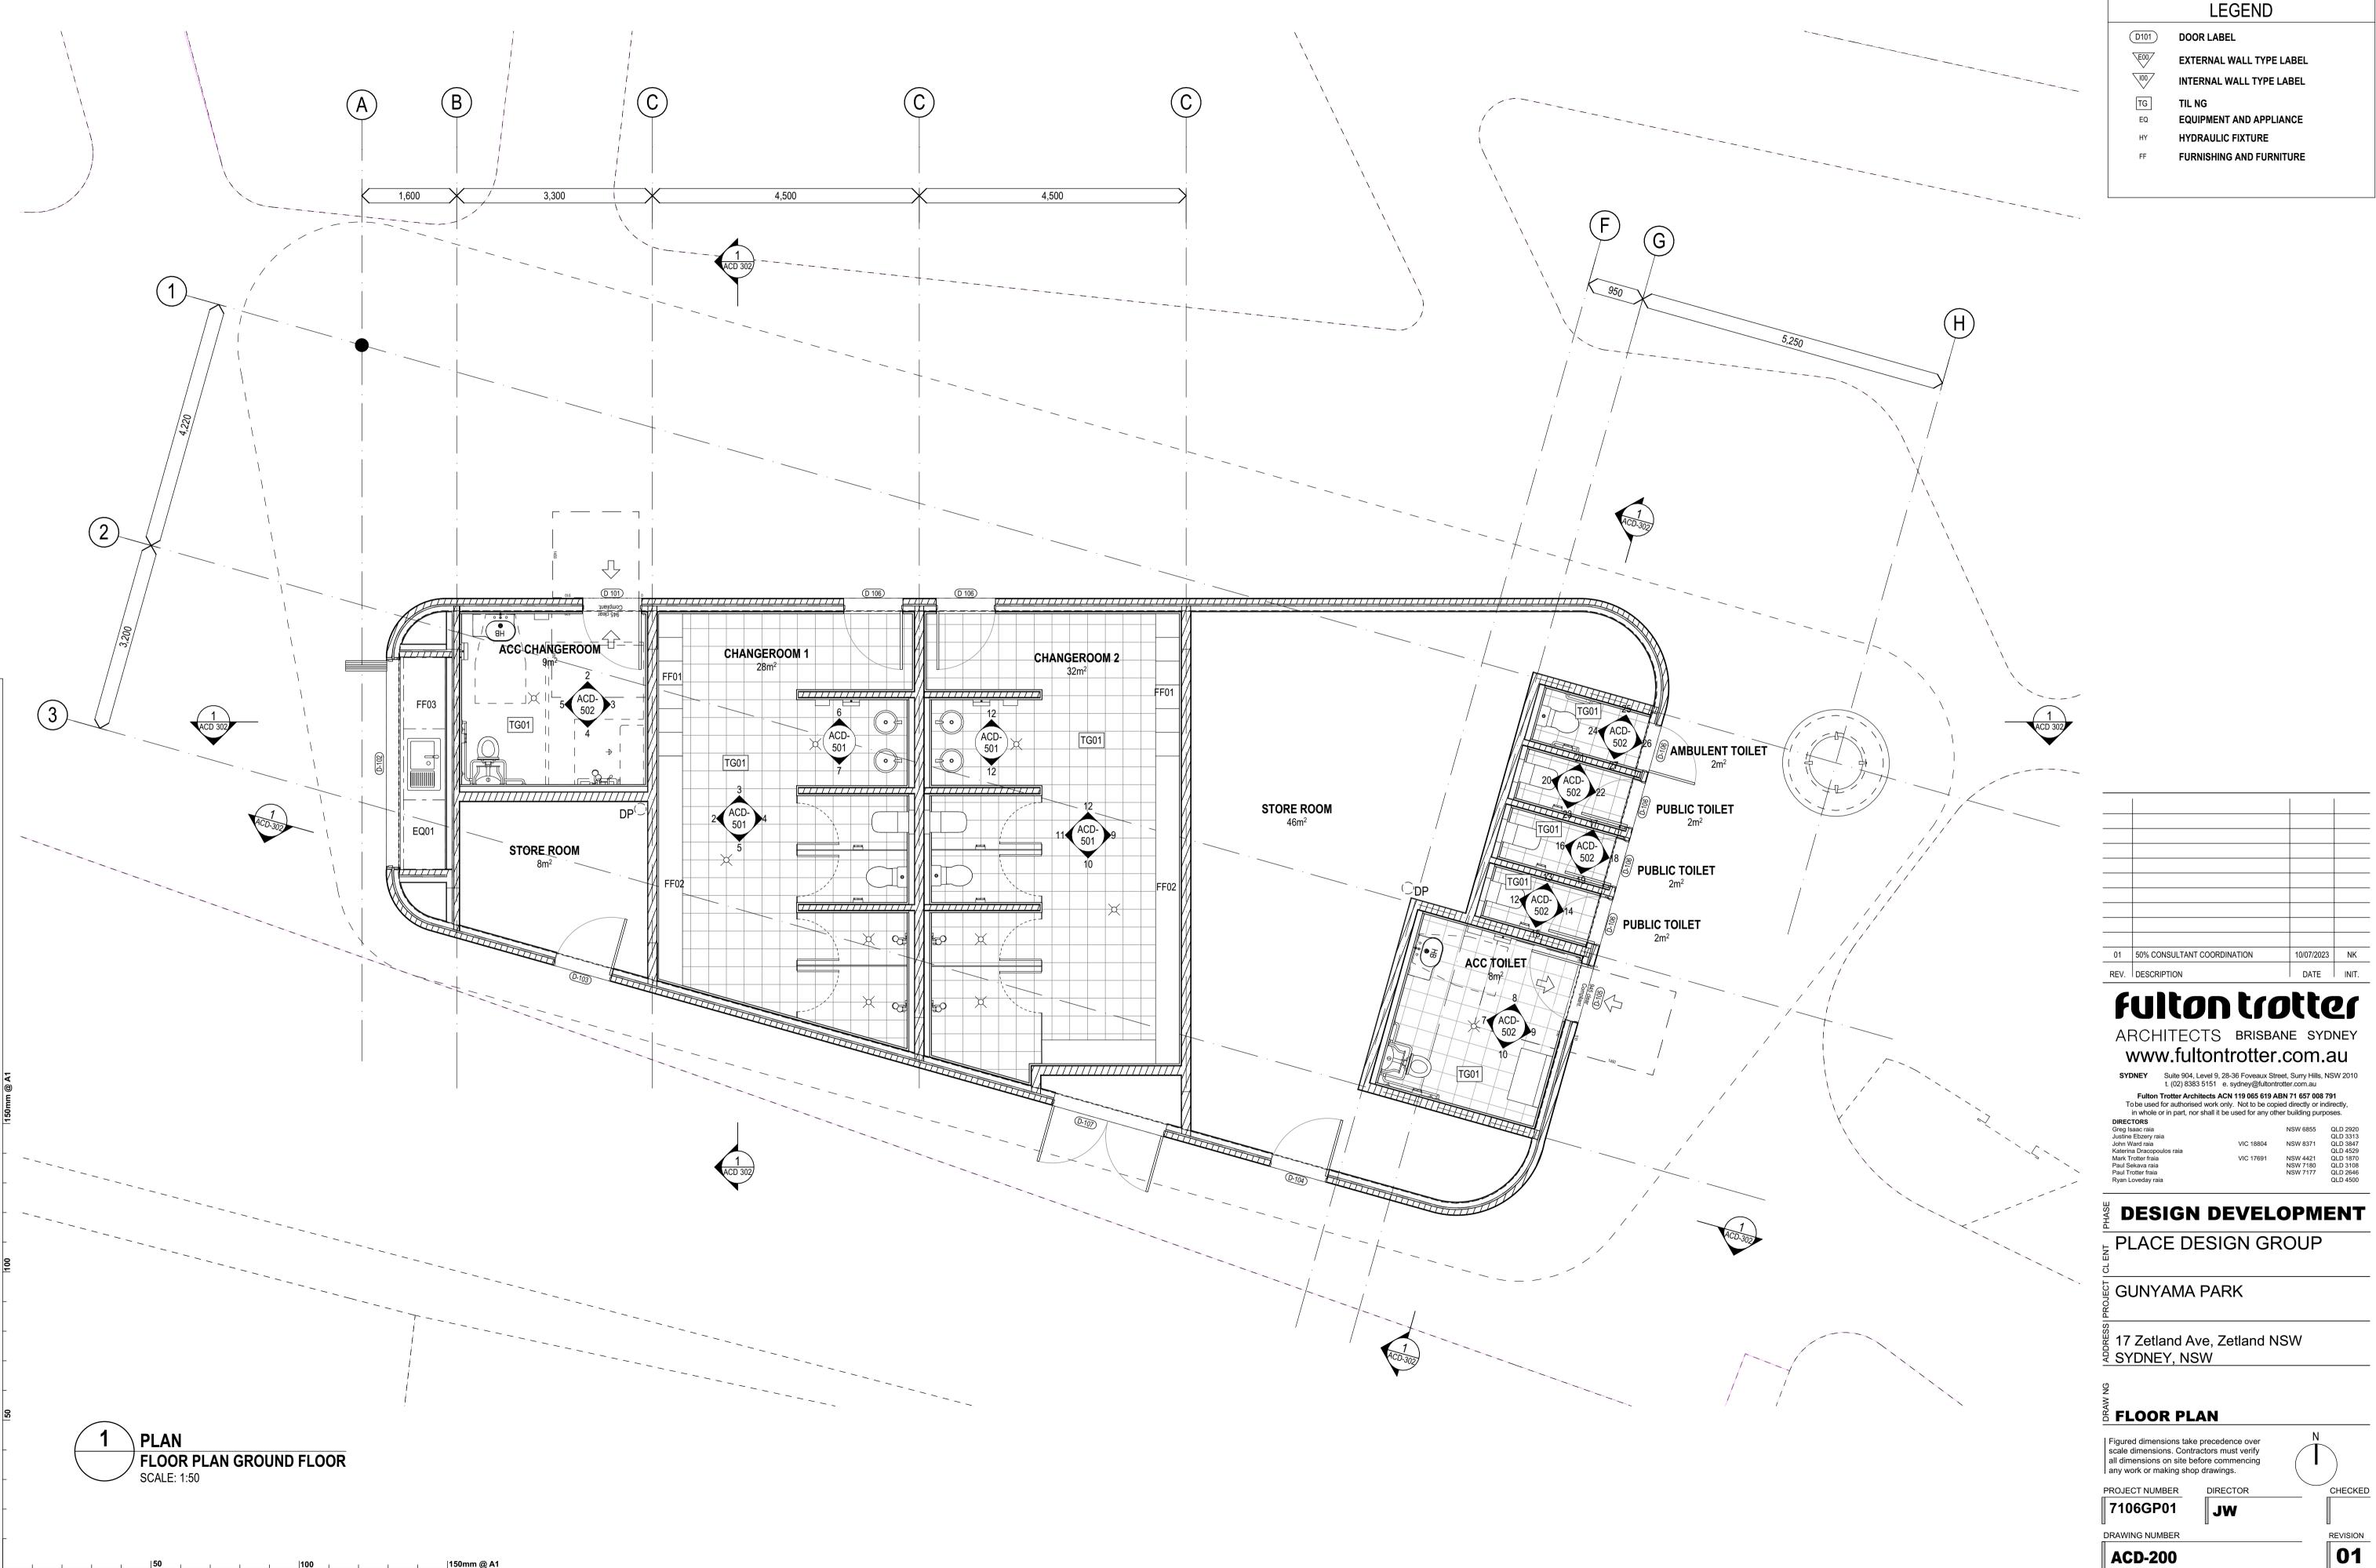

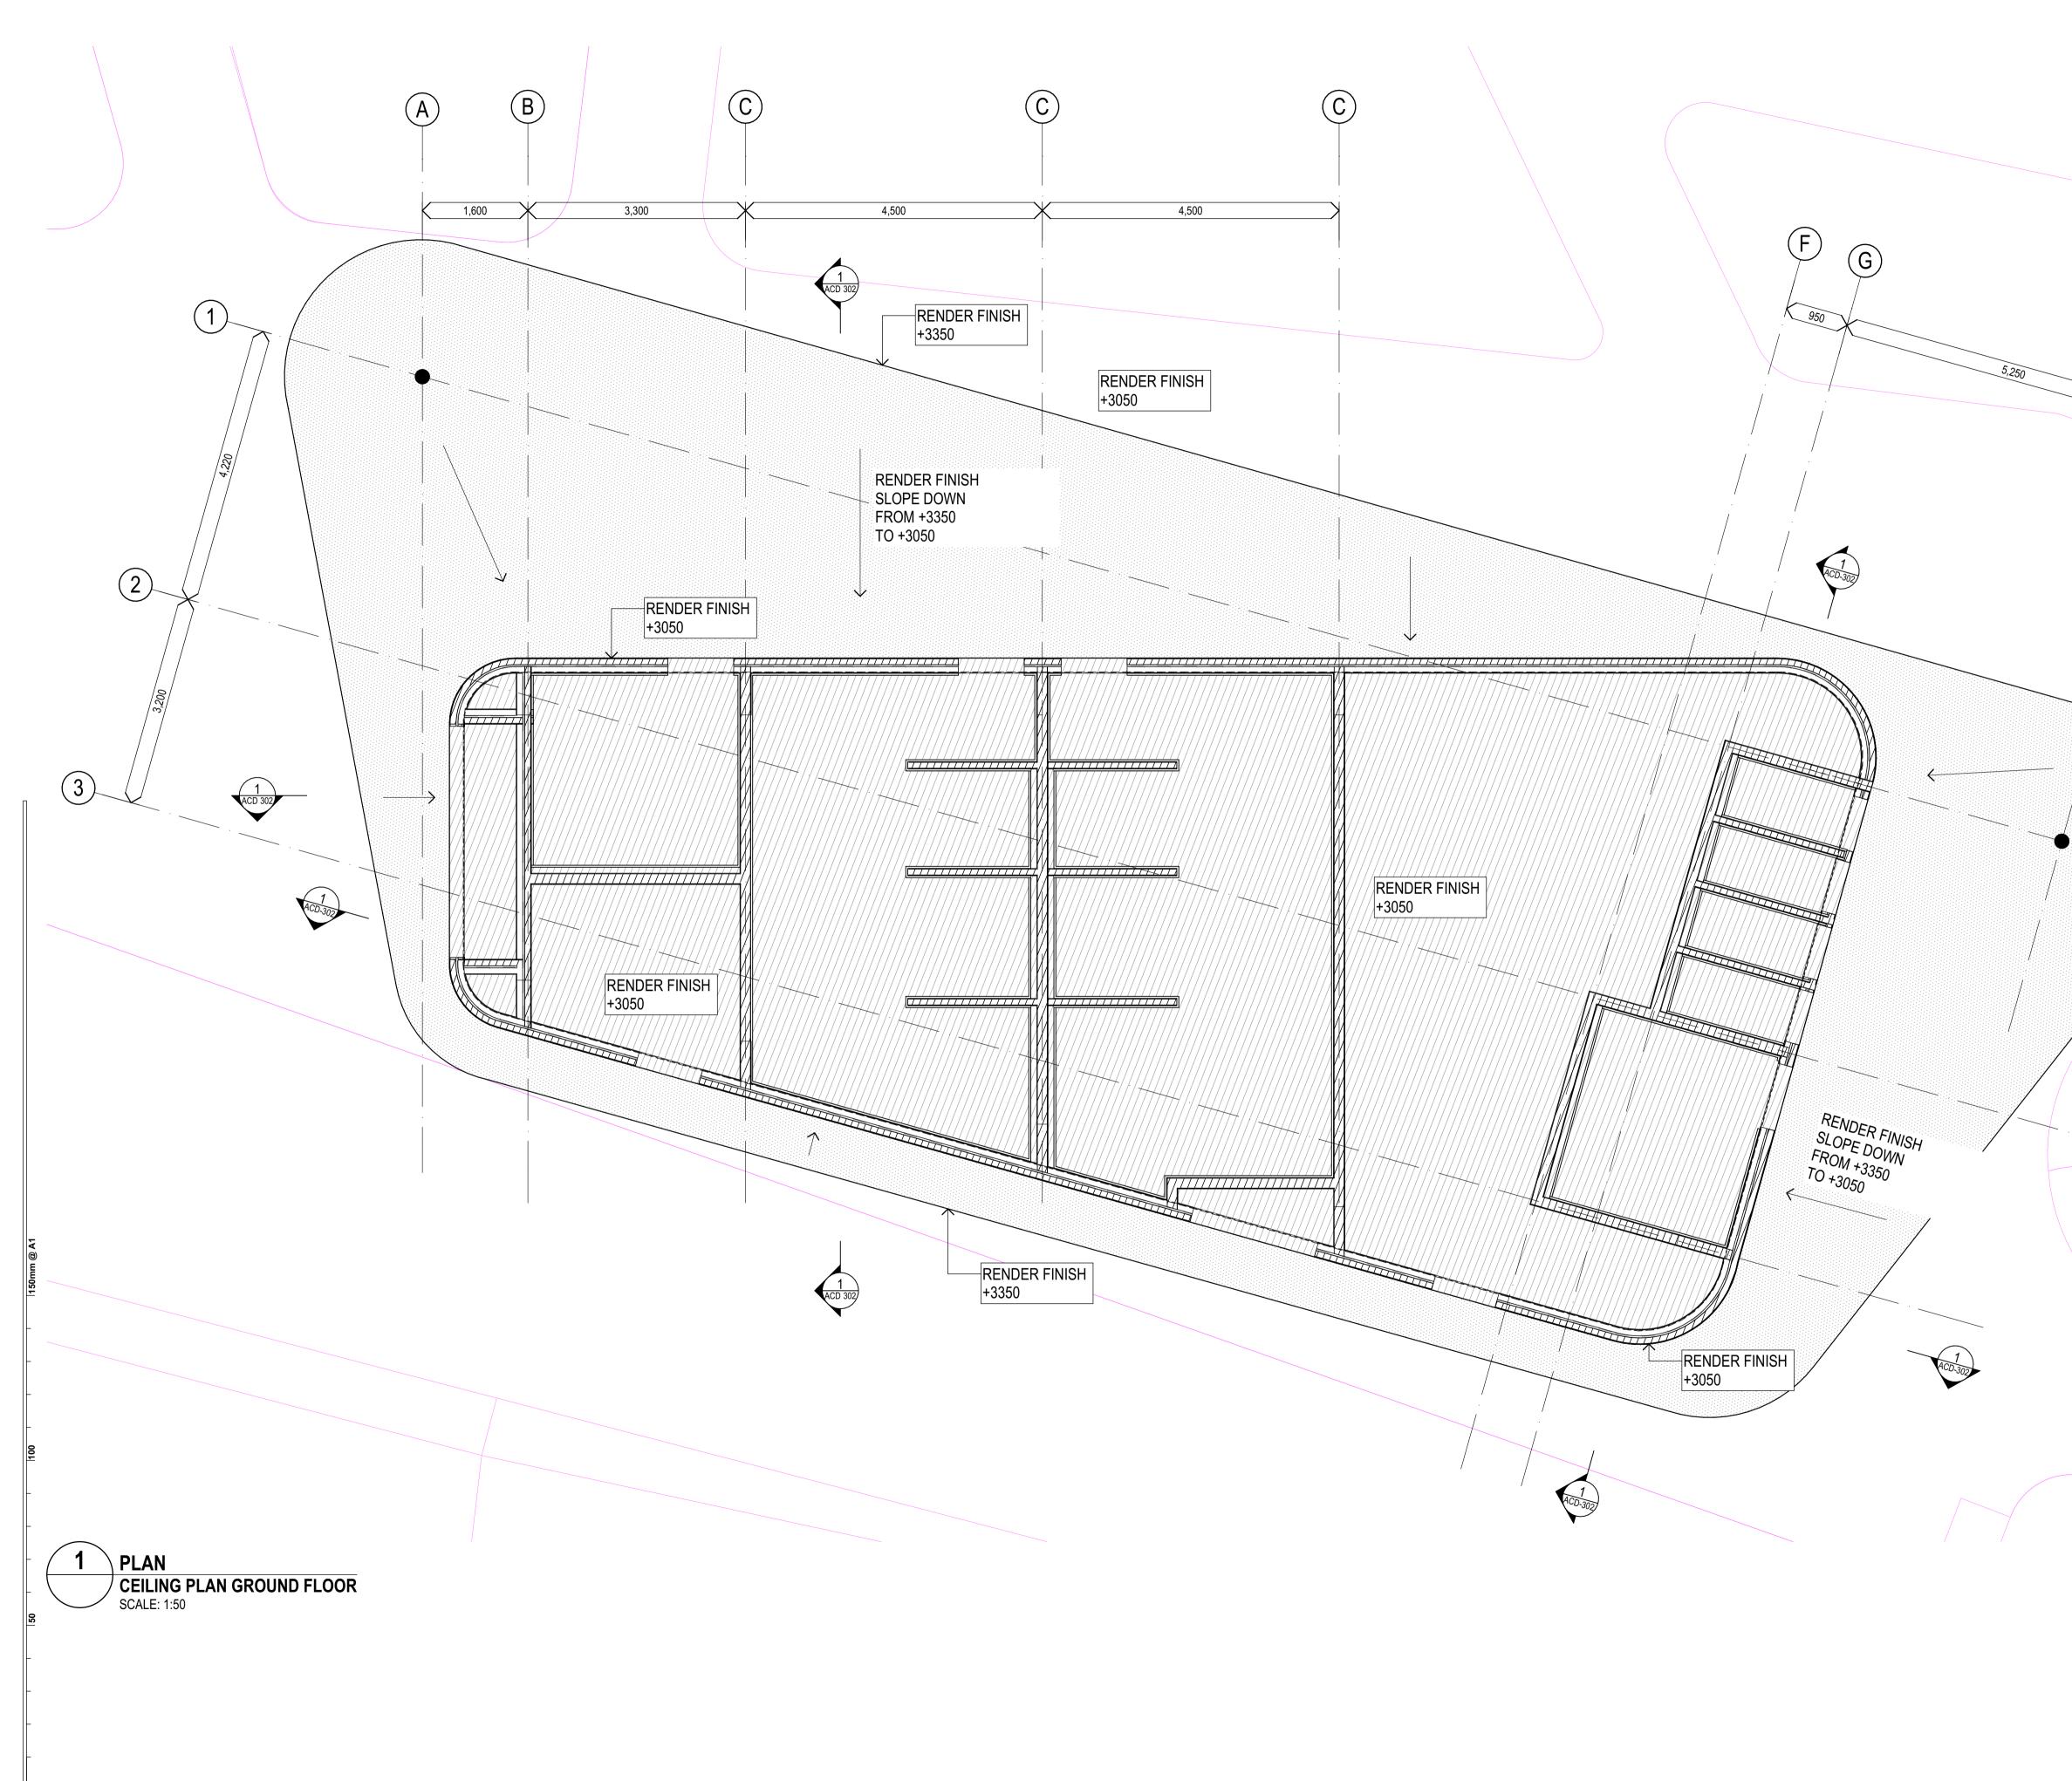

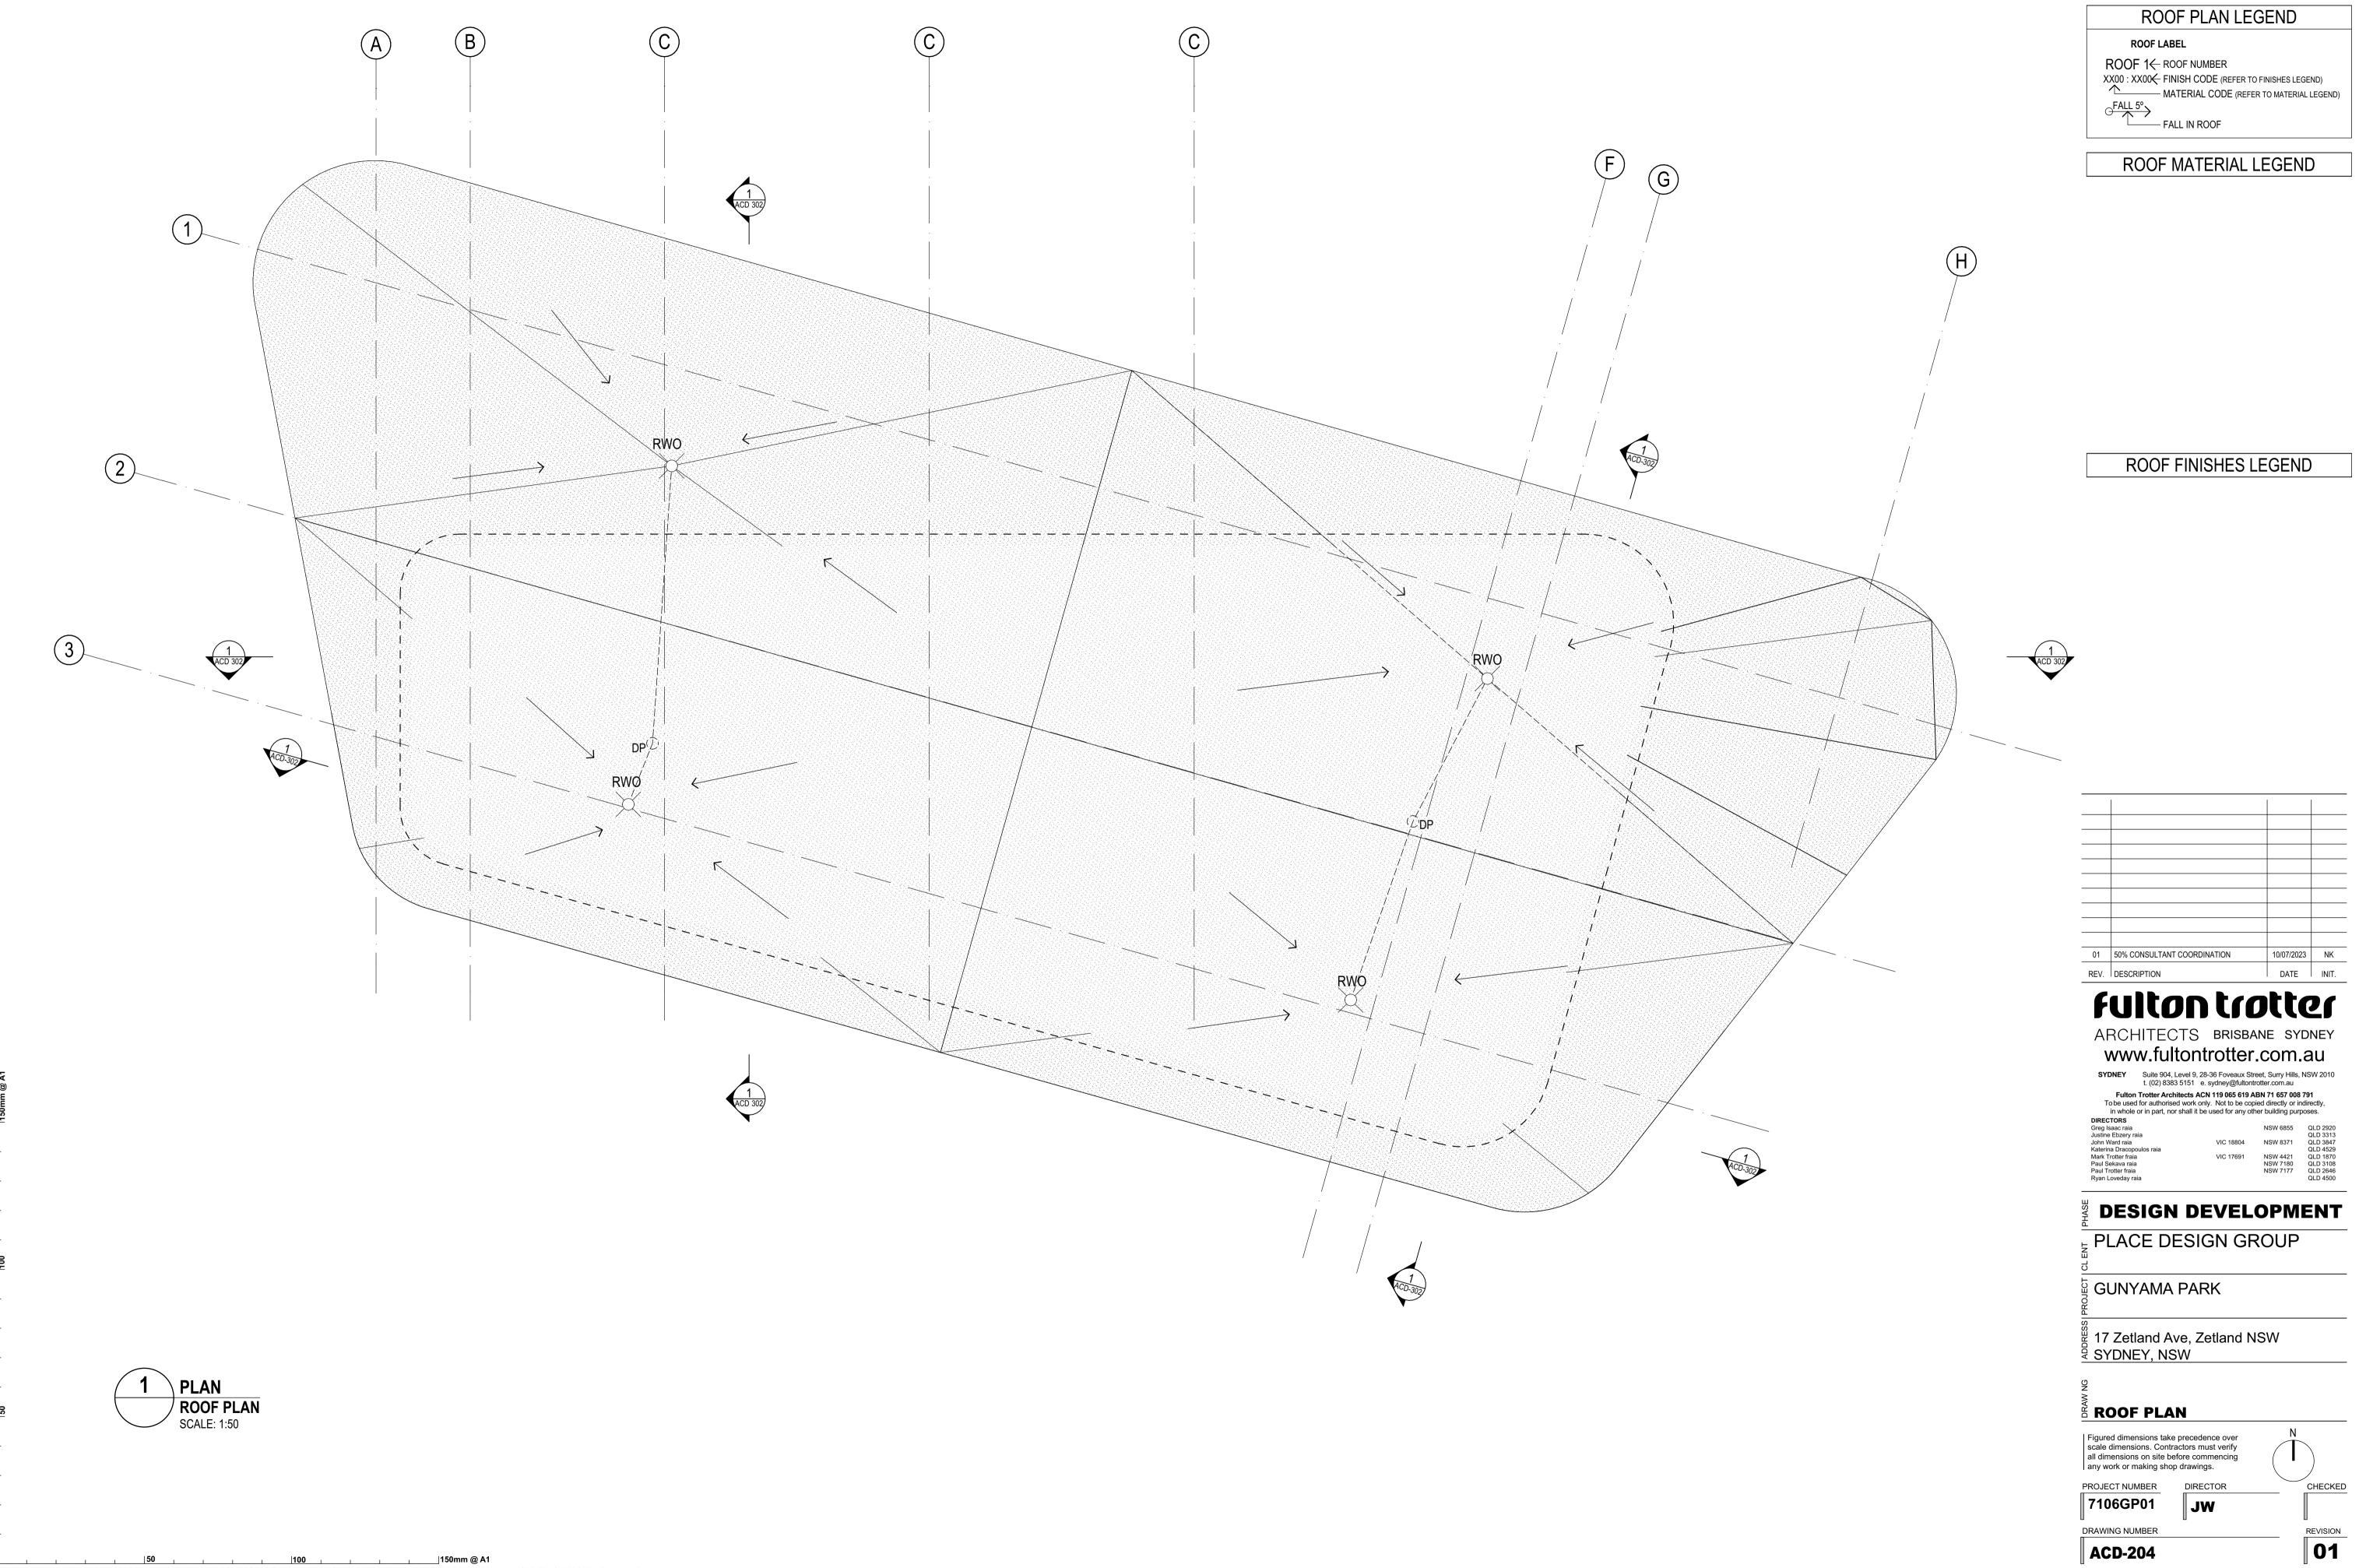

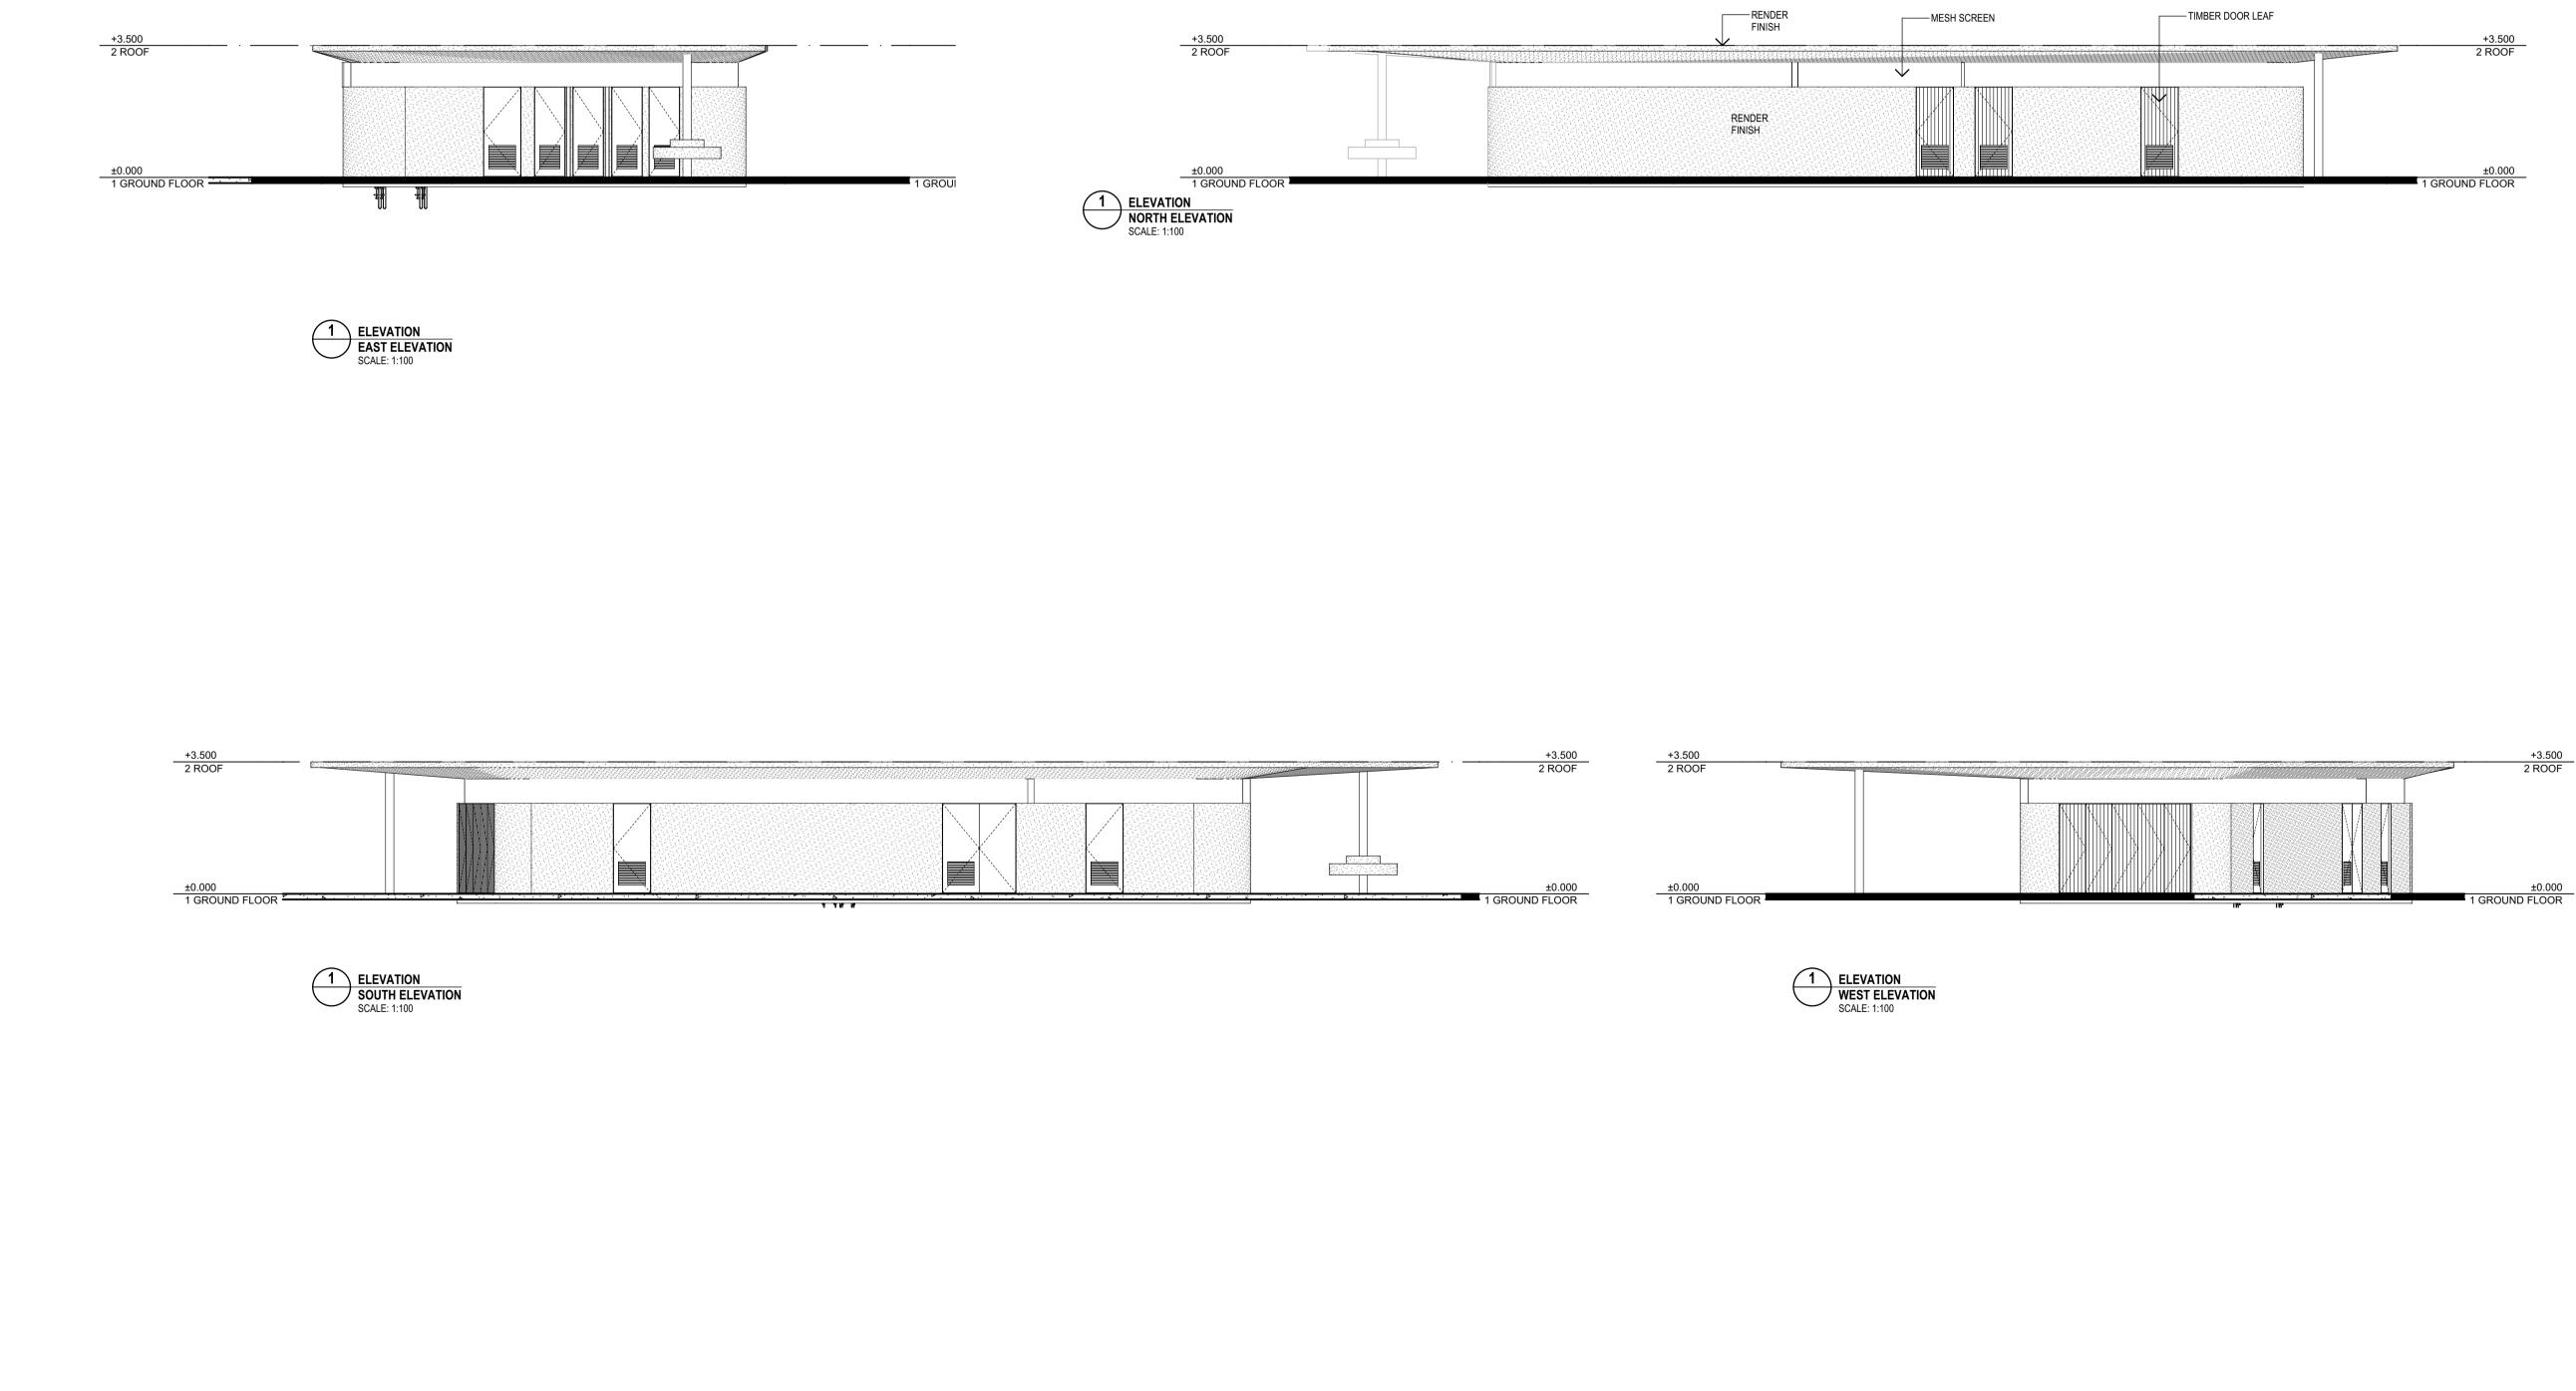

+3.500 2 ROOF	+3.500 2 ROOF	
±0.000	±0.000	

ELEVATION LEGEND				
D101	DOOR LABEL			
W101	WINDOW LABEL			
	— MATERIAL CODE (REFER TO MATERIAL LEGEND)			
XX99 XX99	WALL MATERIAL / FINISH LABEL			

ELEVATION MATERIAL LEGEND CN - CONCRETE

ELEVATION FINISH SCHEDULE

SK01 - WHITE SK55 - CONCRETE - Light SK55 - CONCRETE 1







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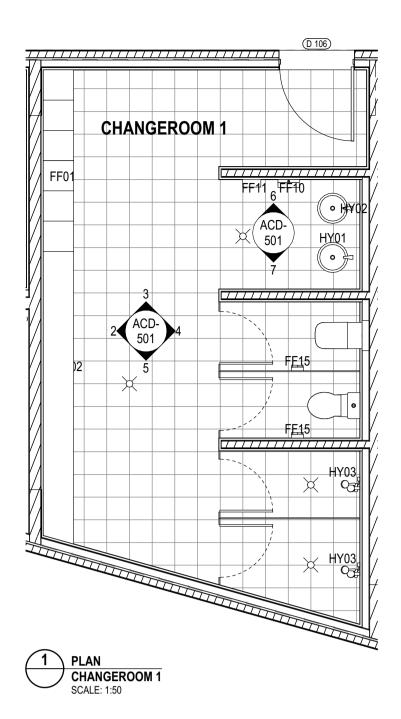



DI01 DOOR LABEL WI01 WINDOW LABEL MATERIAL CODE (REFER TO MATERIAL LEGE




WINDOW LABEL — MATERIAL CODE (REFER TO MATERIAL LEGEND) WALL MATERIAL / FINISH LABEL — FINISH CODE (REFER TO FINISHES LEGEND)

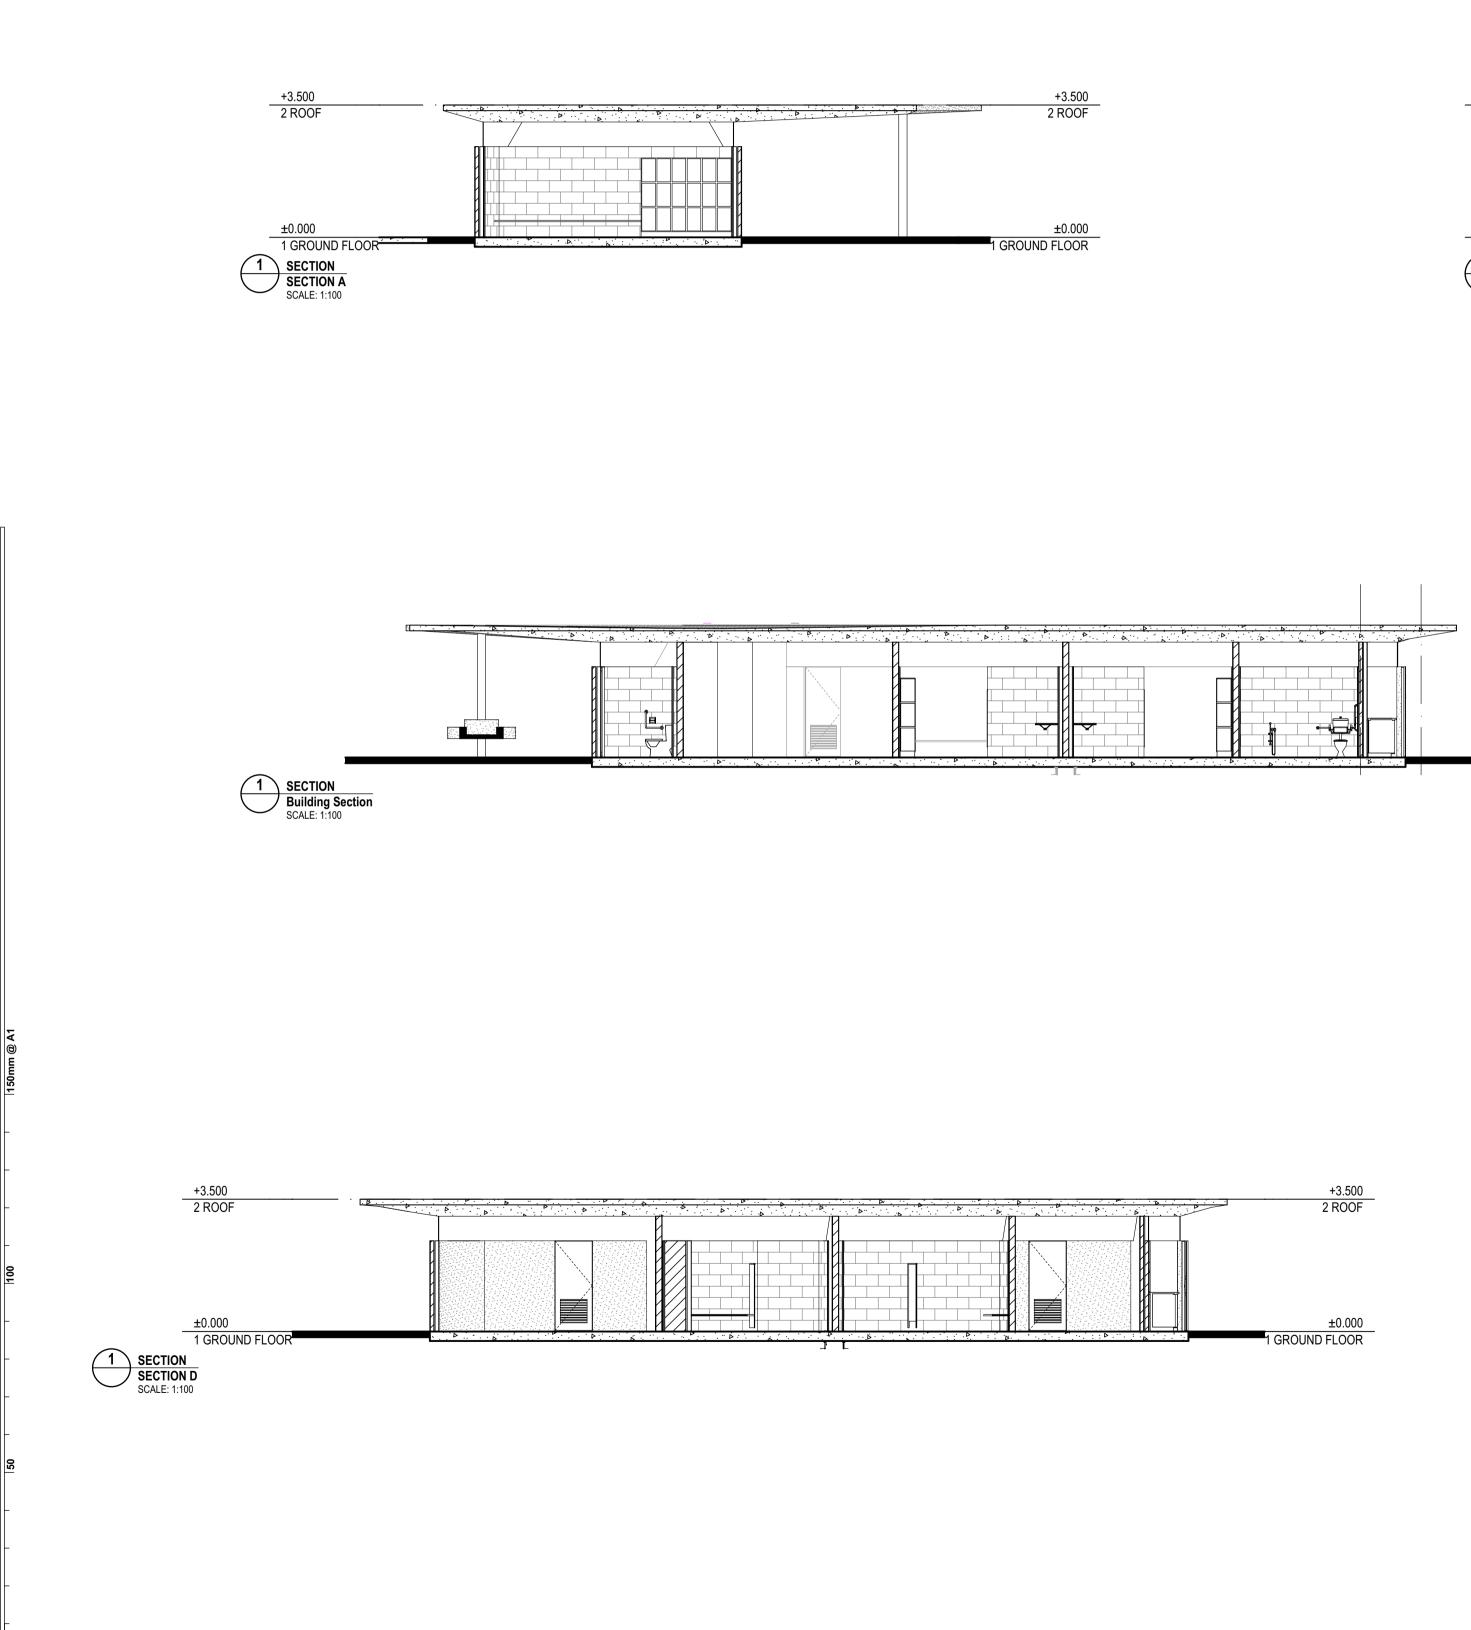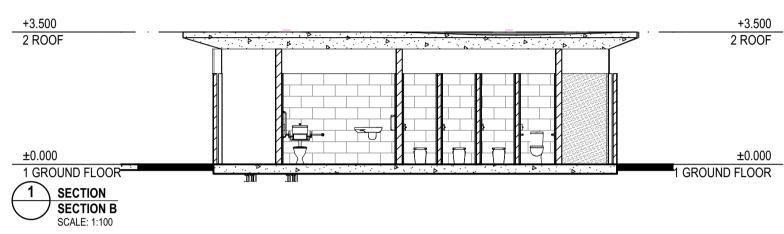





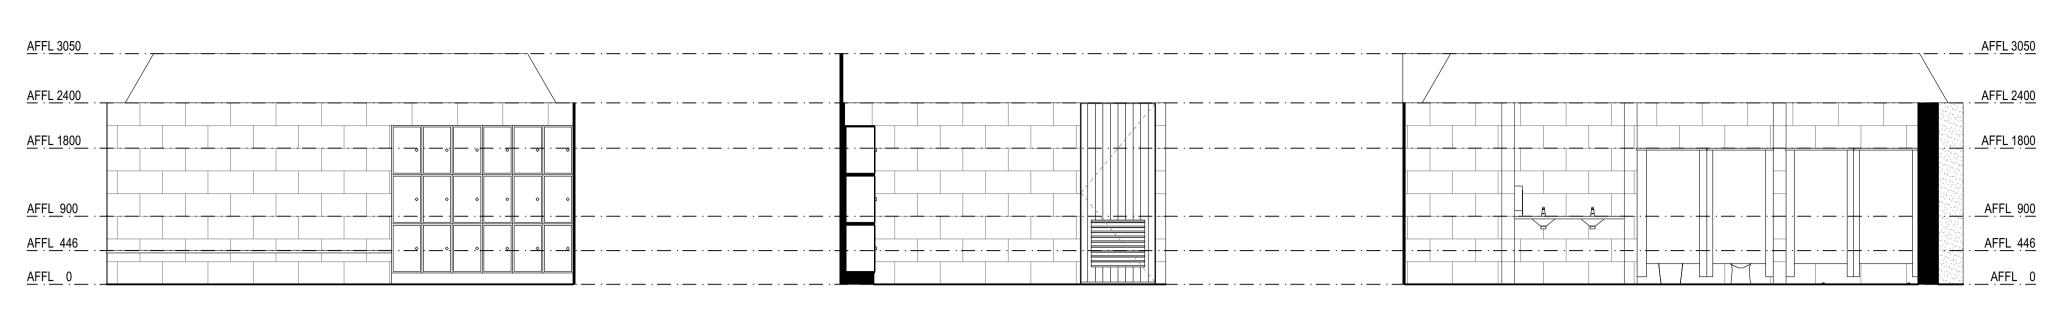




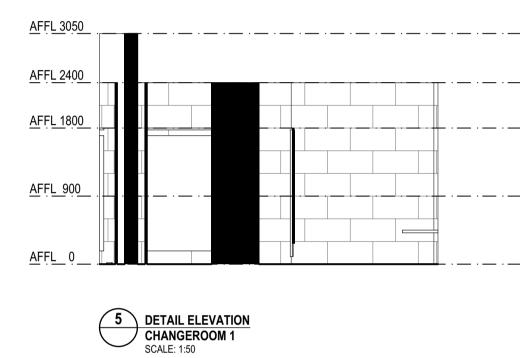

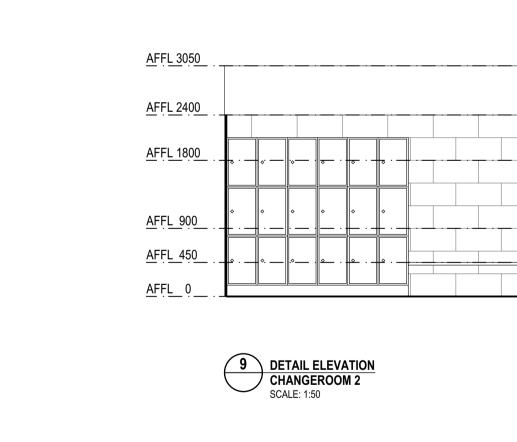

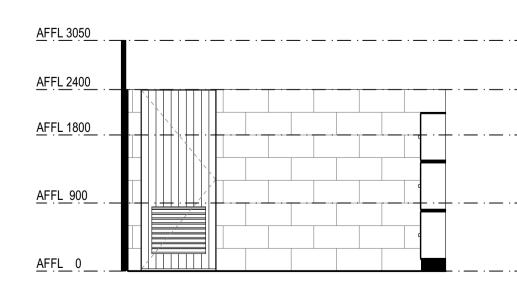



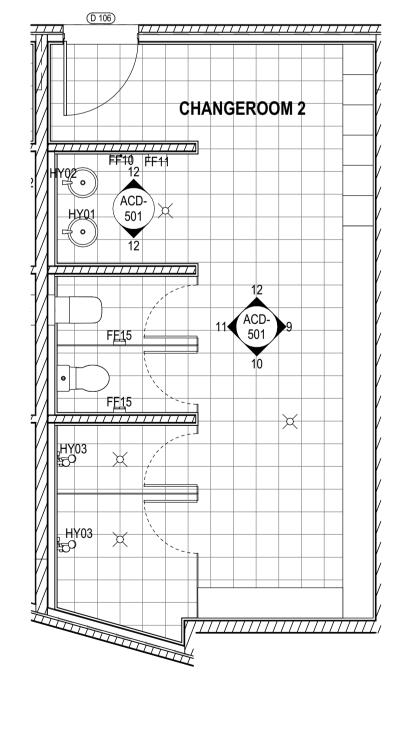

8 PLAN CHANGEROOM 2 SCALE: 1:50














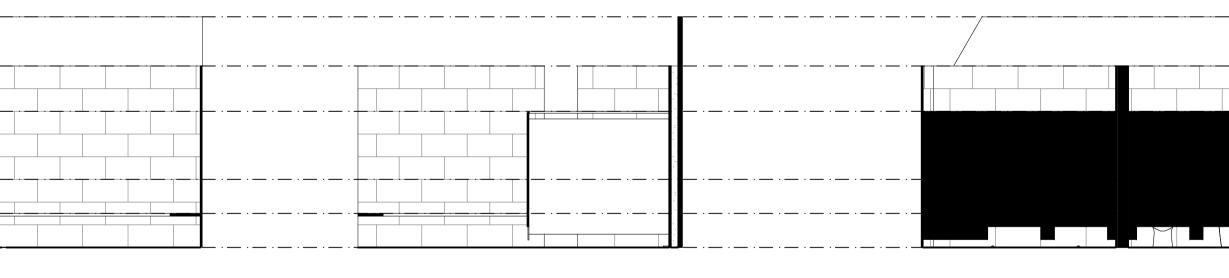





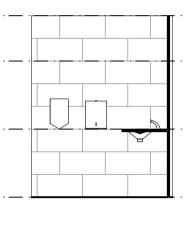

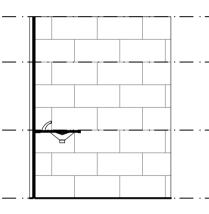


4 DETAIL ELEVATION CHANGEROOM 1 SCALE: 1:50




ROOM LAYOUT LEGEND


INTERNAL MATERIAL LEGEND

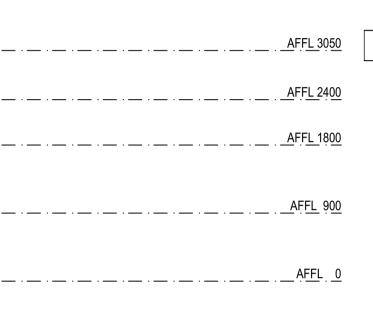





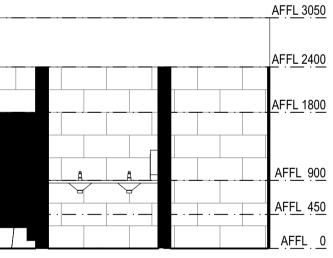

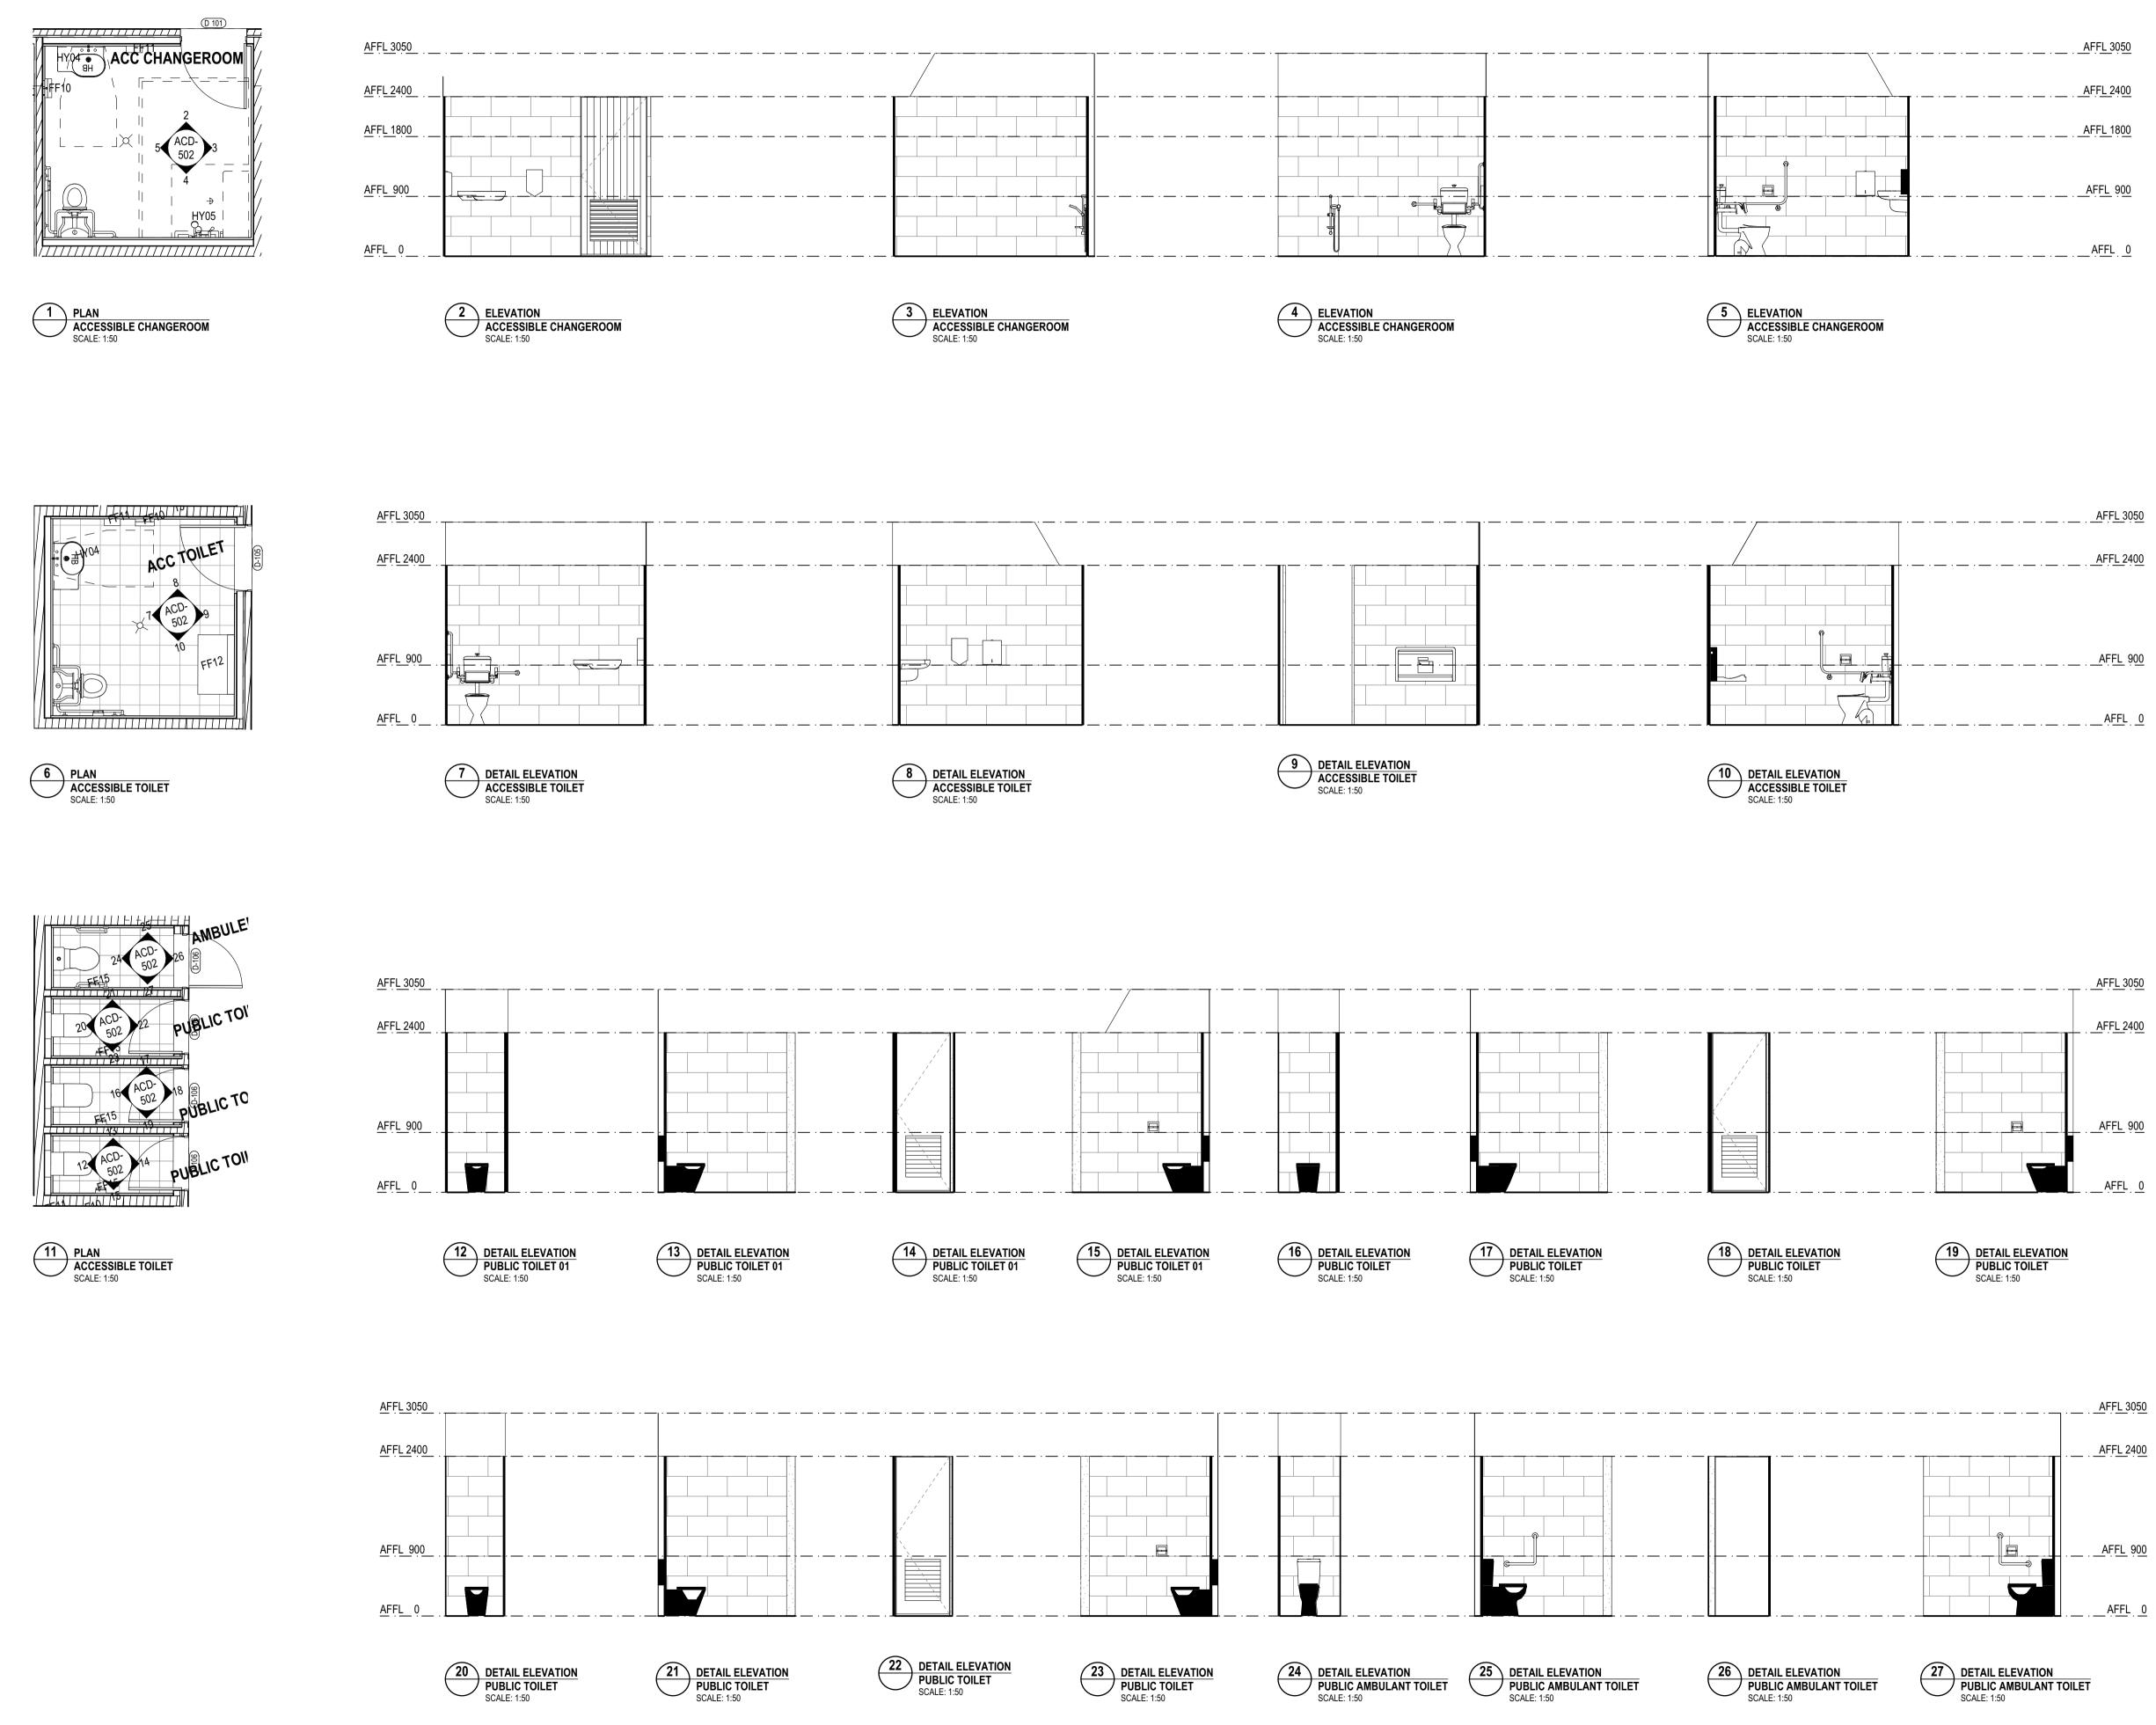

AFFL 3050	
AFFL 2400	
<u>AFFL 1800</u>	
AFFL 900	

AFFL 3050
AFFL 2400
AFFL 900
AFFL0

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		DATE	
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	www.fultontrotter.o		
SYI	DNEY Suite 904, Level 9, 28-36 Foveaux Stree t. (02) 8383 5151 e. sydney@fultontrot		NSW 2010
т	Fulton Trotter Architects ACN 119 065 619 ABN o be used for authorised work only. Not to be copied	l directly or in	directly,
DIREC			
Justine	saac raia e Ebzery raia Vard raia VIC 18804	NSW 6855 NSW 8371	QLD 2920 QLD 3313 QLD 3847
Katerir	a Dracopoulos raia rotter fraia VIC 17691	NSW 4421	QLD 3847 QLD 4529 QLD 1870
Paul T	ekava raia rotter fraia	NSW 7180 NSW 7177	QLD 3108 QLD 2646 QLD 4500
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ADDRESS PROJECT CL EN	UNYAMA PARK		
ADDRESS ADDRESS	Zetland Ave, Zetland NS DNEY, NSW	SW	
DRAW NG	DOM LAYOUT 2		
scale all dim	ed dimensions take precedence over dimensions. Contractors must verify nensions on site before commencing ork or making shop drawings.		
PROJE	CT NUMBER DIRECTOR		CHECKED
710	96GP01 JW		
DRAWI	NG NUMBER		
	D-502		01

NUMBER	D-101, D-106	D-102	D-103, D-104	D-105	D-106	D-107
LOCATION	[SET CUSTOM]	[SET CUSTOM]	[SET CUSTOM]	[SET CUSTOM]	[SET CUSTOM]	[SET CUSTOM]
ТҮРЕ	[SELECT OPERATION TYPE]	[SELECT OPERATION TYPE]	[SELECT OPERATION TYPE]	[SELECT OPERATION TYPE]	[SELECT OPERATION TYPE]	[SELECT OPERATION TYPE]
OVERALL & LEAF	Overall: 1,000mm W x 2,400mm H	Overall: 3,505mm W x 2,090mm H	Overall: 990mm W x 2,360mm H	Overall: 990mm W x 2,360mm H	Overall: 820mm W x 2,360mm H	Overall: 1,960mm W x 2,360mm H
SIZE (W X H)	Leaf: 1 x 980mm x 2,360mm	Leaves: 5 x 693mm x 2,350mm	Leaf: 1 x 980mm x 2,360mm	Leaf: 1 x 980mm x 2,360mm	Leaf: 1 x 800mm x 2,360mm	Leaves: 1 x 970mm + 1 x 970mm x 2,360mm
	Type: ARCH - SD	Type: ARCH - SD	Type: ARCH - SD	Type: ARCH - SD	Type: ARCH - SD	Type: ARCH - SD
	Finish: SK02 - BLACK	Finish: SK02 - BLACK	Finish: SK03 - LIGHT GREY	Finish: SK02 - BLACK	Finish: SK02 - BLACK	Finish: SK02 - BLACK
	Notes:	Notes:	Notes:	Notes:	Notes:	Notes:
LEAF	Type: ARCH - SD	Type: ARCH - SD	Type: ARCH - SD	Type: ARCH - SD	Type: ARCH - SD	Type: ARCH - SD
	Notes:	Notes:	Notes:	Notes:	Notes:	Notes:
LEAF FINISH	Internal: SK63 - Timber Cladding	Internal: SK63 - Timber Cladding	Internal: SK68 - CHARCOAL	Internal: SK68 - CLAY	Internal: SK68 - CLAY	Internal: SK68 - CHARCOAL
	External: SK63 - Timber Cladding	External: SK63 - Timber Cladding	External: SK68 - CHARCOAL	External: SK68 - CLAY	External: SK68 - CLAY	External: SK68 - CHARCOAL
	Notes:	Notes:	Notes:	Notes:	Notes:	Notes:





DOOR SCHEDULE LEGEND

Product Specifications noted below comply with current Standards and Codes. Any alternatives need to comply with current Standards and Codes 1. All Window and Door dimensions are nominal only and are to

- be checked on site prior to placing order. 2. All Windows and Doors to External Walls are viewed from
- External Side 3. All Windows and Doors to Internal Walls are viewed from the
- Nominated Room 4. All Glazing to comply with BCA Volume 1 Part B1.4 (h), Part
- F1.13 (access compliant low profile thresholds will not comply with Part F1.13), Part J2 Glazing and referenced current Australian Standards.
 Full Height Glazing to be provided with Contrasting Decal to
- comply with AS1428.1 Section 6.6. Lincoln Sentry Safety Decal Trend Large 3-712-045.
- 6. External Glass to be Viridian ComfortPlus SuperGreen 49, U Value 3.6 & SHGC 0.37
- Internal Glass to be Viridian VTough Clear
 Key Locks to be provided to all openable windows
- Provide Manual Window Winder to all Openable Windows with a sill above 1800mm AFFL. Manual Winder to be Unique Window Services MDCR or approved equivalent. Winders to be located at 1000mm AFFL and located horizontally where shown on Room Elevation Drawings or otherwise agreed location with Architect.
- Door Thresholds to comply with AS1428.1 Section 5.1.2
 All Aluminium Windows and Doors are to be powder coat finish to AS 3715. Grade: Architectural Finish.
- 12. All timber door sets that have multiple leaves to have rebated stiles
- All Hollow Core Doors fitted with Mortice Locks require a Mortice Lock Block.
- Provide to doors Hoop Pine Edge Strips with mitred corners
 External Faces of doors to be lined with Durocote hardboard
- 4.8mm thick with paint finish or equal equivalent16. Internal Faces of doors to be lined with Redicote hardboard
- 4.8mm thick with paint finish or equal equivalent17. Fire and Smoke Doors to comply with BCA Volume 1 Spec C3.4 and AS 1905.1
- Fire Door and Frame cavities are to be fire rated to -/120/30
 Fire and Smoke Doors Seals shall be Raven Door Seals or
- equal equivalent a. Bottom Seal - RP8Si (Concealed in base)
- b. Jamb & Head RP78Si
 c. Stiles 2 x RP71Si
- 20. External Doors and Windows are to be fitted with Raven Seals or equivalent to meet the requirements of Volume 1 BCA Part J3.
- 21. Refer to Mechanical Engineers Documents for Doors that
- require Grilles or require to be undercut. 22. No midrails to Glazed Doors unless noted otherwise.
- 22. No midrails to Glazed Doors unless not 23. Flyscreens - Not Applicable
- 24. Security Screens Not Applicable

01	50% CONSULTANT C	OORDINATION	10/07/202	3 NK
REV.	DESCRIPTION		DATE	INIT.
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	be used for authorised		ied directly or in	directly,
DIREC		hall it be used for any oth		
Justine	saac raia Ebzery raia /ard raia	VIC 18804	NSW 6855 NSW 8371	QLD 2920 QLD 3313 QLD 3847
Katerin	a Dracopoulos raia rotter fraia	VIC 17691	NSW 4421	QLD 4529 QLD 1870
	ekava raia rotter fraia	NSW 7177	NSW 7180 QLD 2646	QLD 3108
Ryan L	oveday raia			QLD 4500
DHASE	ESIGN	DEVEL	ОРМ	ENT
~	_ACE DE	SIGN GF	ROUP	
	JNYAMA F	PARK		
DRESS 17	Zetland Ave DNEY, NSV	,	SW	
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scale of all dim	ed dimensions take p dimensions. Contrac iensions on site befo ork or making shop c	tors must verify re commencing		
PROJE	CT NUMBER	DIRECTOR		CHECKED
710	6GP01	JM	—	
DRAWI	NG NUMBER			REVISION
AC	D-601			01

GUNYAMA PARK STAGE 2

LIGHTING LEGEND

Symbol	DESCRIPTION	HOUSING/COLOUR	REFLECTOR	LAMP	CONTROL GEAR	SUPPLIER	PRODUCT No.
\$	GE ECO R250 40W LED STREETLIGHT MOUNTED ON STEEL POLE 7.5m MOUNTING HEIGHT, 3.0m OUTREACH ARM	GREY FINISH	N/A	41.14W LED 5229 lm 4000K	ELECTRONIC CONTROL GEAR	Solutions (GE LIGHT)	GE ECO 250 40W 4000K 40W_IESNA2002
FL1 X	IP66, IK07, PEDESTRIAN CROSSING FLOODLIGHT MOUNTED AT 7.5m HEIGHT, 3.0m OUTREACH ARM EYE GUELL	GREY FINISH	WIDE ASYMMETRIC	115W LED 8934 lm 4000K	ELECTRONIC CONTROL GEAR		EYE GUELL 2 115W 8934lm 173105-Guell2-114W-LED -4000K-Asymm-WB
D A	POST TOP LUMINAIRE MOUNTED ON A 4.5m POLE - FACING PLATE LIGHT POLE, BRONZE POWDERCOATED ALUMINIUM	BRONZE	ASYMMETRIC	44.41W LED 2824 Im 4000K	INTEGRAL ELECTRONIC CONTROL GEAR		HUB - CoS PEDESTRIAN TZANNES LIGHT POLE GA3 180434PH
	EXISTING STAGE 1 POST TOP LUMINAIRE MOUNTED ON A 4.5m POLE - FACING PLATE LIGHT POLE, BRONZE POWDERCOATED ALUMINIUM TO REMAIN	BRONZE	ASYMMETRIC	44.41W LED 2824 Im 4000K	INTEGRAL ELECTRONIC CONTROL GEAR		HUB - CoS PEDESTRIAN TZANNES LIGHT POLE GA3 180434PH
	IP65, IK07, CEILING MOUNTED DOWNLIGHT SURFACE MOUNTED UNDERSIDE OF SHADE STRUCTURES	GRAPHITE	WIDE BEAM	9.2W LED 915 lm 3000K	INTEGRAL ELECTRONIC CONTROL GEAR	LIGHT CULTURE / BEGA	BEGA 24 404 + K3
BT1	IK08 IP66 LED LUMINAIRE 1200mm SURFACE MOUNTED	DIFFUSED	DIFFUSER	13.4W LED 1630 lm 3000K	ELECTRONIC CONTROL GEAR	LIGHT CULTURE	ARAGON-1200-S-B-1630 830 13W (AD)
BT2	IK08 IP66 LED LUMINAIRE 1200mm SURFACE MOUNTED	DIFFUSED	DIFFUSER	16W LED 1950 lm 3000K	ELECTRONIC CONTROL GEAR	LIGHT CULTURE	ARAGON-1200-S-B-1950 830 16W (AD)
LN1	IP55, IK10, LINEAR LED EXTRUSION CEILING SURFACE MOUNTED. COMPLETE WITH SURFACE MOUNTING BRACKETS. LENGTHS AS SHOWN IN PLAN.	WHITE TBC	SYMMETRIC LEDOPTEK	LED 9.1W/m 1000 lm/m 3000K	INTEGRAL ELECTRONIC CONTROL GEAR		KALLI 080 BEAM D KAL080BMD-Dir-LPC-W -Sym-LED1000lm-90CRI-3K
LN2	IP55, IK10, LINEAR LED EXTRUSION CEILING SURFACE MOUNTED. COMPLETE WITH SURFACE MOUNTING BRACKETS. LENGTHS AS SHOWN IN PLAN.	ТВС	Symmetric Ledoptek	LED 23.5W/m 1575 lm/m 3000K	INTEGRAL ELECTRONIC CONTROL GEAR		KALLI 080 BEAM D KAL080BMD-Dir-LPC-W -Sym-LED2250Im-90CRI-3K
Ю _{WL1}	INSTALLED AT 2000mm FROM FFL.	RAL 9004 SIGNAL BLACK TBC	FORWARD [A60]	11W LED 386.4 lm 3000K	INTEGRAL ELECTRONIC CONTROL GEAR	ILLUMINATION / WE-EF	
O→ SP1	IP66, IK07, MEDIUM BEAM SPOTLIGHT COMPLETE WITH COLUMN FITTER INSTALLED ON STRUCTURE COLUMN	RAL 9004 SIGNAL BLACK TBC	MEDIUM BEAM	5W LED 398.4 lm 3000K	INTEGRAL ELECTRONIC CONTROL GEAR	BUCKFORD ILLUMINATION / WE-EF	FLC301 SPIGOT MOUNTED 145-7184 + 145-9536

POWER LEGEND

SYMBOL	DESCRIPTION	HOUSING/COLOUR	SUPPLIER
	EXISTING DISTRIBUTION SWITCH BOARD MODIFY AS NOTED	ORANGE X15	-
— – E – –	IN-GROUND HD ELECTRICAL CONDUIT — REFER TO LAYOUT FOR SIZES	ORANGE	-
-E/C	IN-GROUND HD ELECTRICAL & COMMS CONDUITS — REFER TO LAYOUT FOR SIZES	ORANGE/WHITE	-
	600x600 CLASS C PIT WITH PAVING INFILL LID	PAVING IN FILL LID WITH STEEL EDGE	ACO
$D_{\overline{IP}}$	240V 10A IP66 SOCKET OUTLET	WHITE	CLIPSAL
1PH X A	240V ISOLATOR, RATING AS NOTED	WHITE	CLIPSAL

Issue P1 P2

Amendment Preliminary issue 50% ISSUE

T:\Projects\L177\L177D - Gunyama Park Stage 2\L177D-DG\L177D-EL.dwg - 001 - 17/07/2023 - 4:44:18 PM

Date 12-07-23 17-07-23



DRAWING LIST EL-001	LEGEND, DRAWING LIST AND LOCATION PLA
EL-101	LIGHTING & ELECTRICAL LAYOUT - LANDSCA
EL-102	LIGHTING & ELECTRICAL LAYOUT - AMENITIES
EL-201	LIGHTING DETAILS - SHEET 01
EL-202	LIGHTING DETAILS - SHEET 02
EL-300	SINGLE LINE DIAGRAM

PRODUCT No.
-
-
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66H + DI66C
56C310
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p: +61 2 9436 0998 e: mail@laands.com.au


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100m ___ 1:1000@A1

LAN

CAPE & STREETSCAPE TES BUILDING



Drawn MA

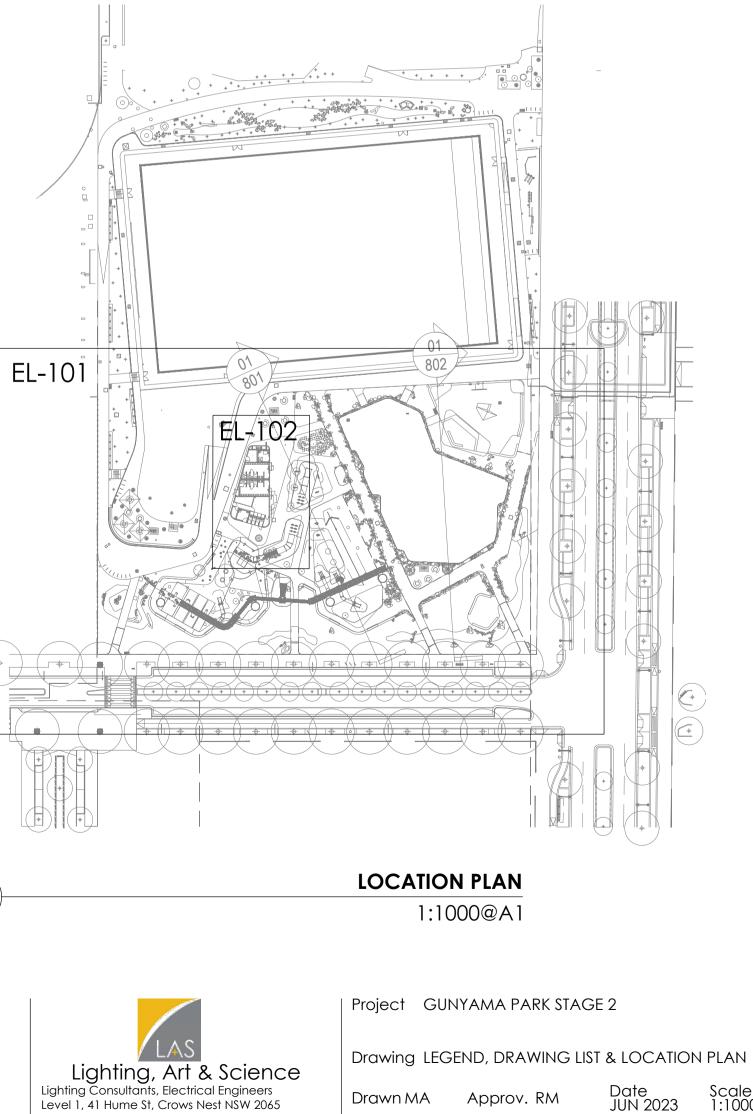Project No


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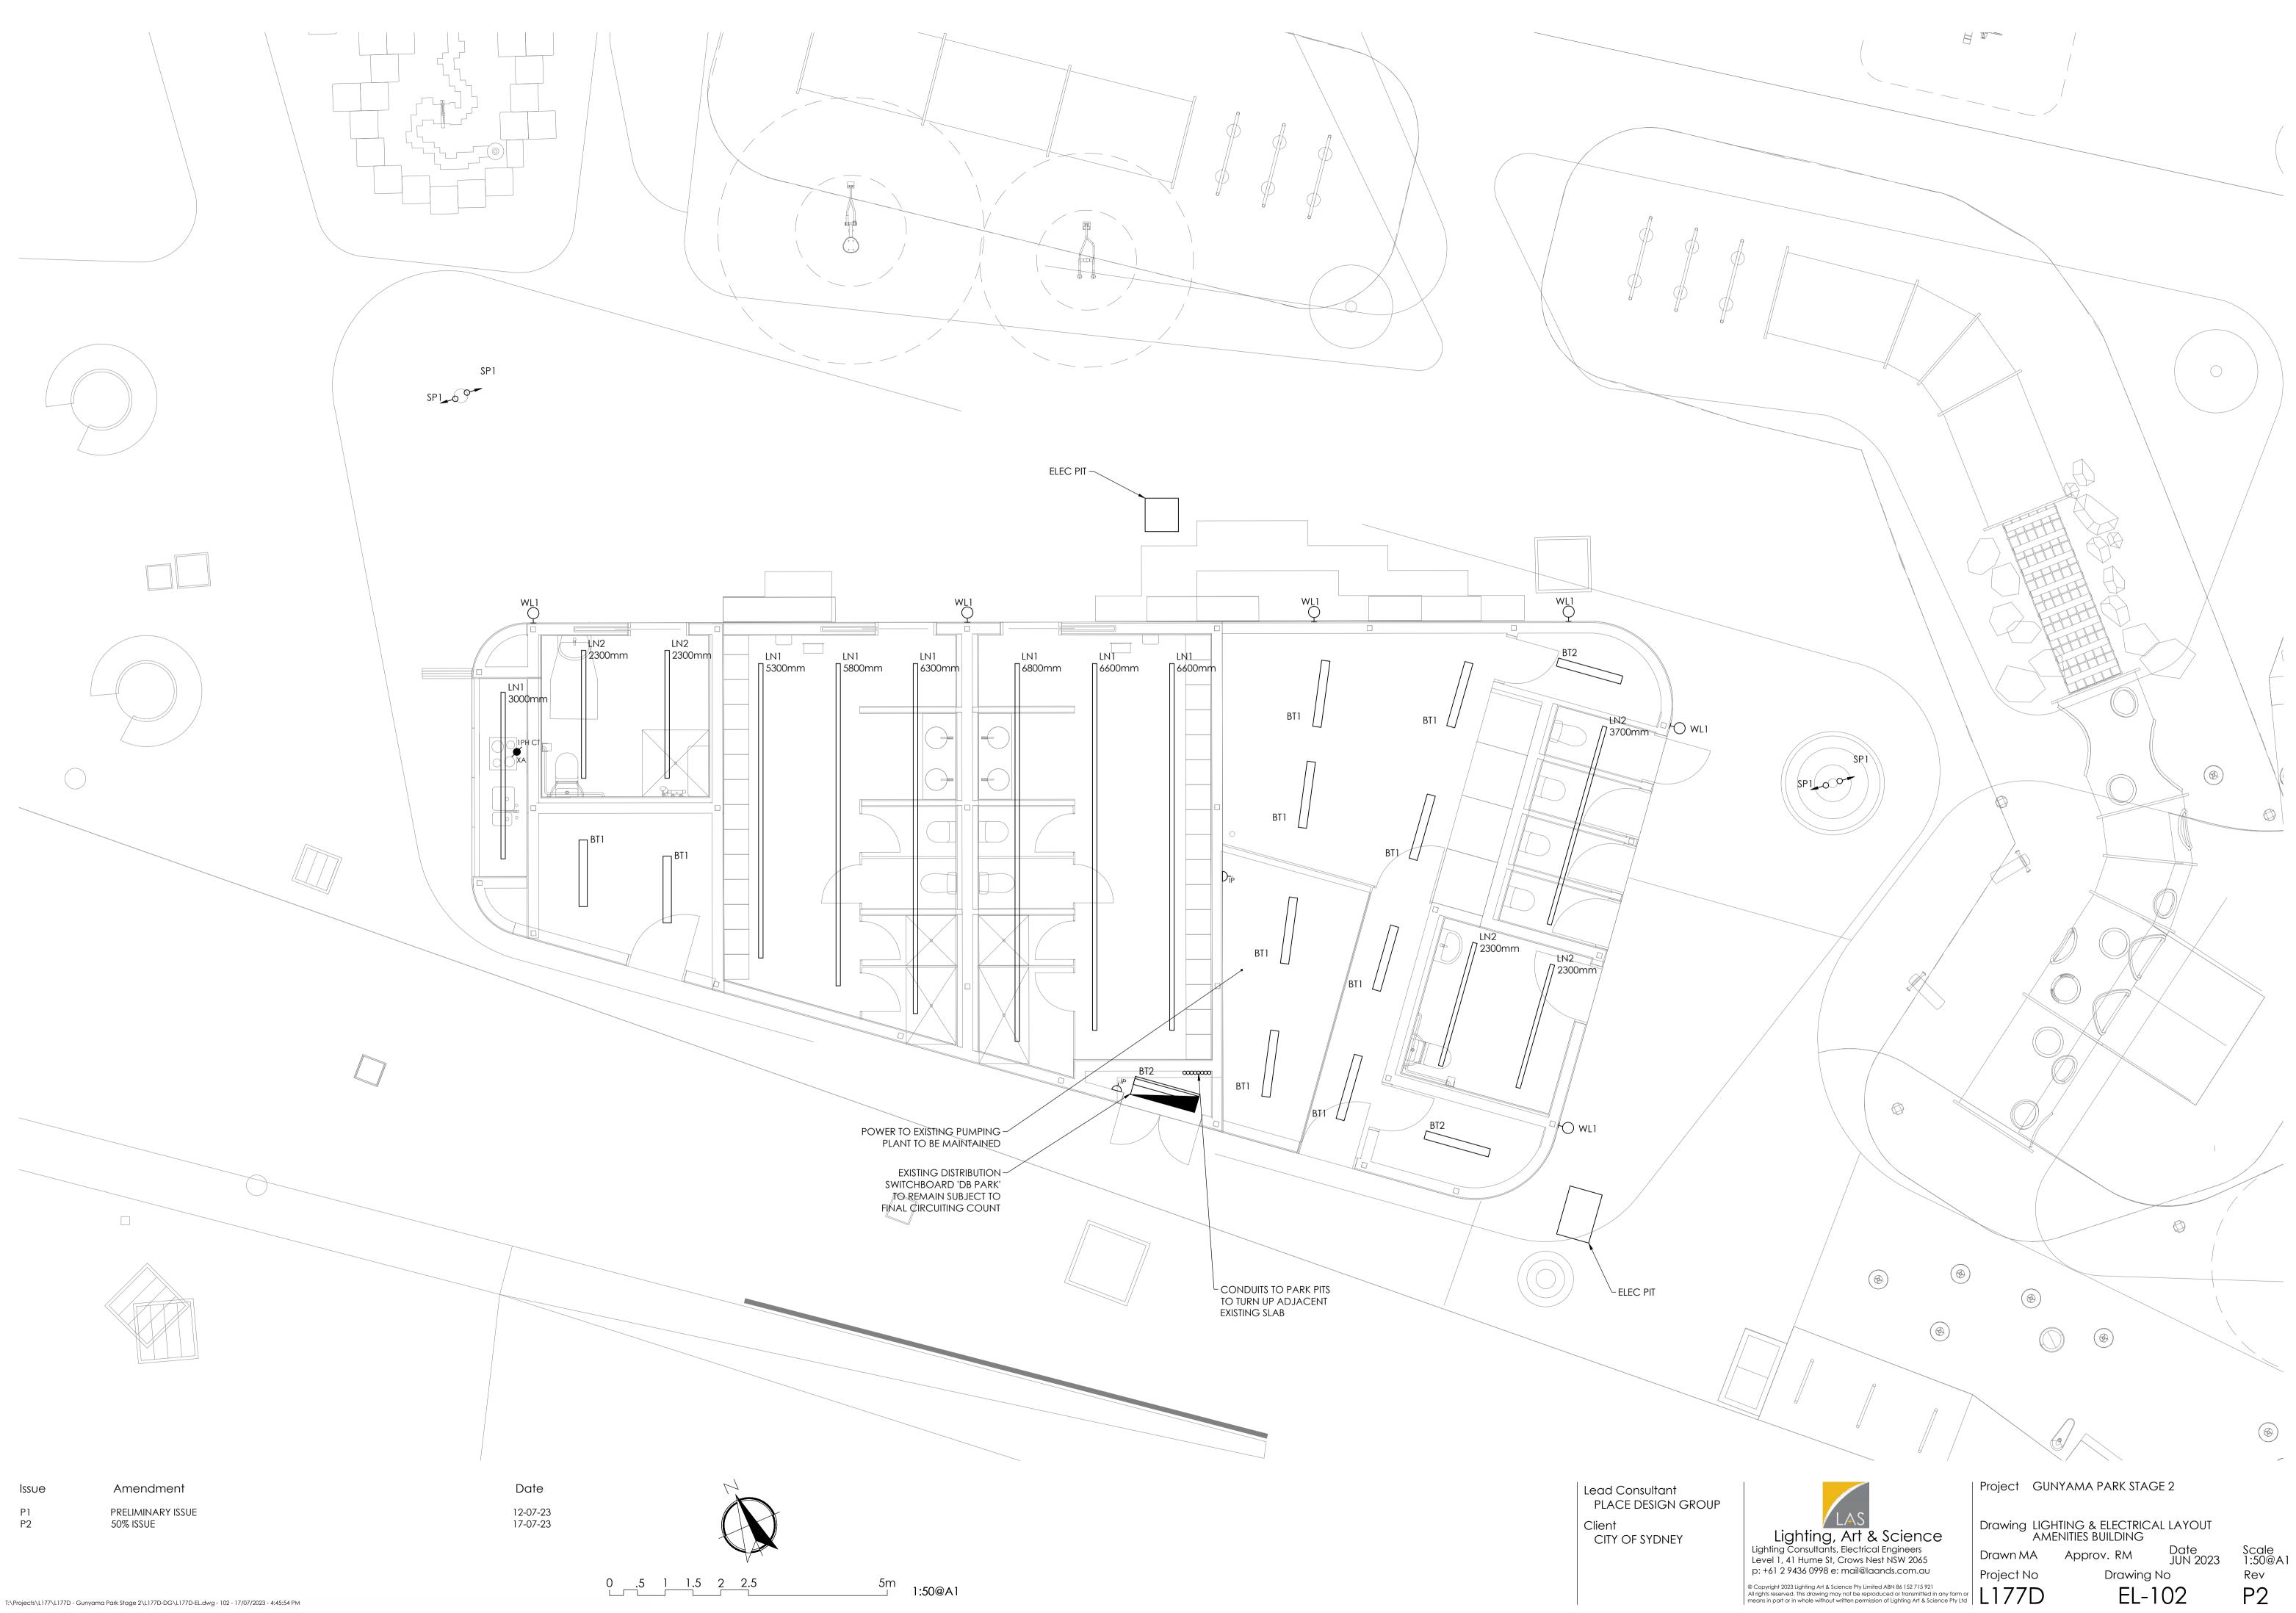
Approv. RM


Drawing No

EL-001

Date JUN 2023 Scale 1:1000@A1 Rev P2



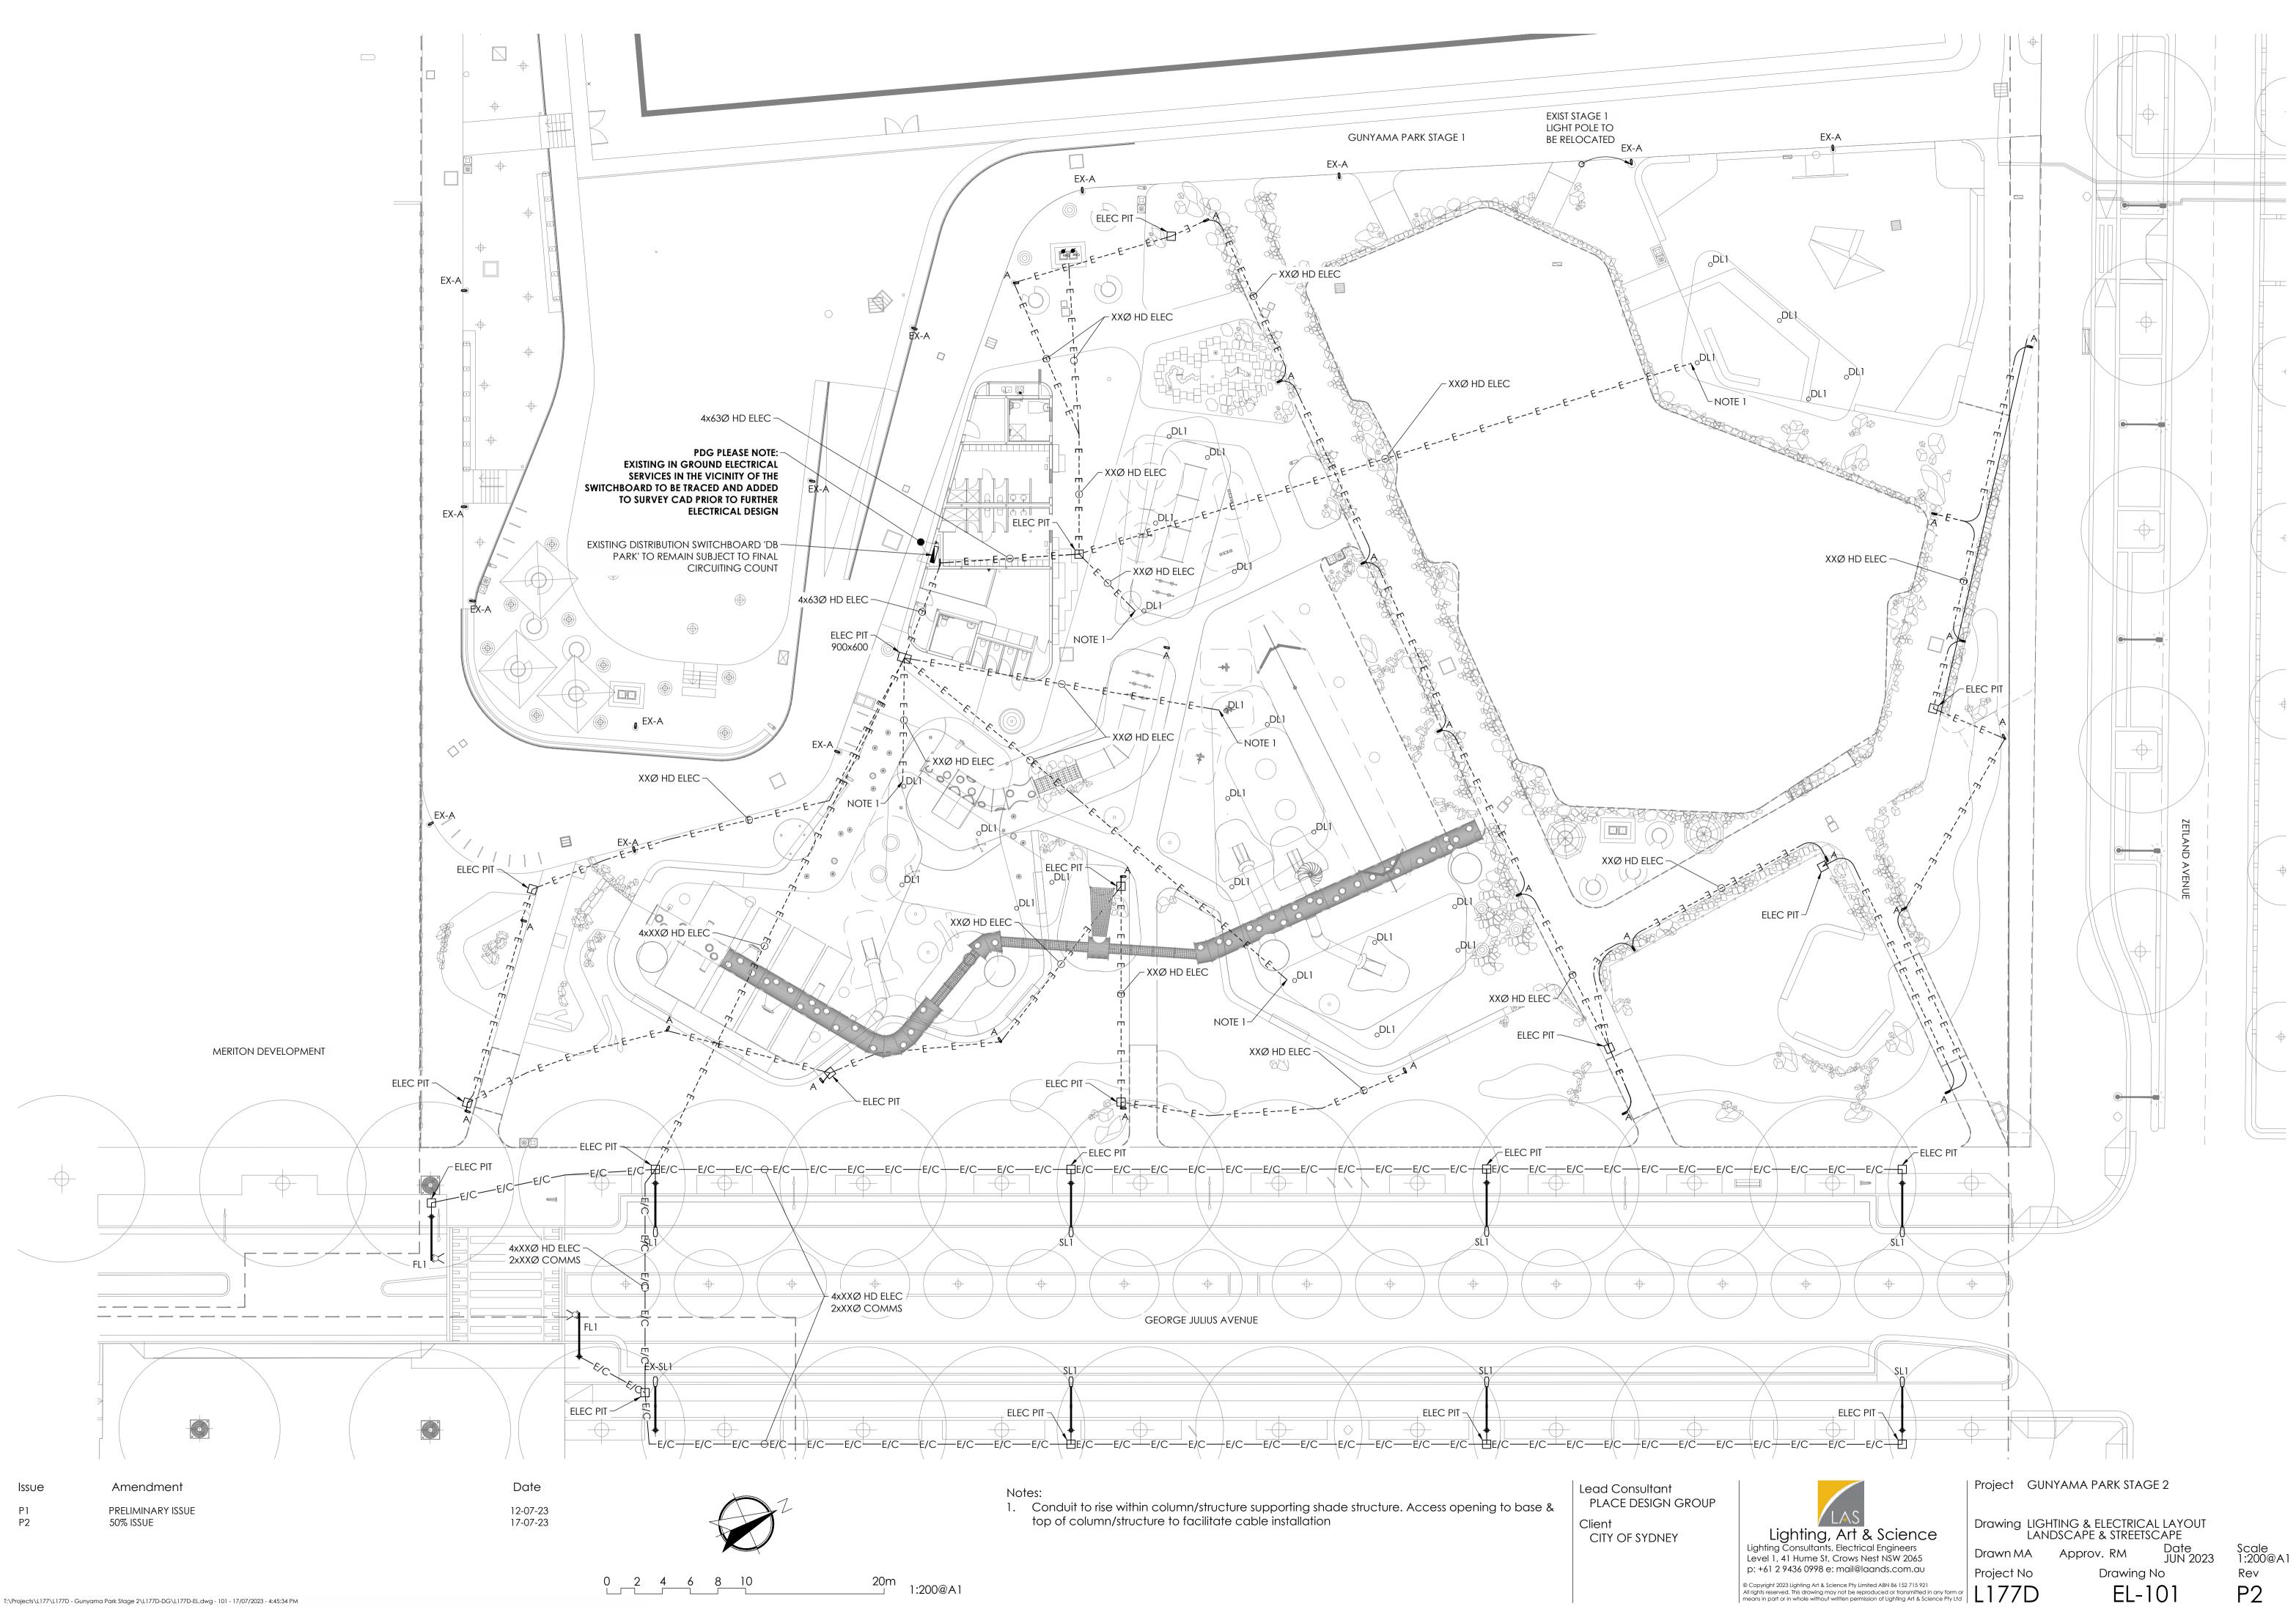

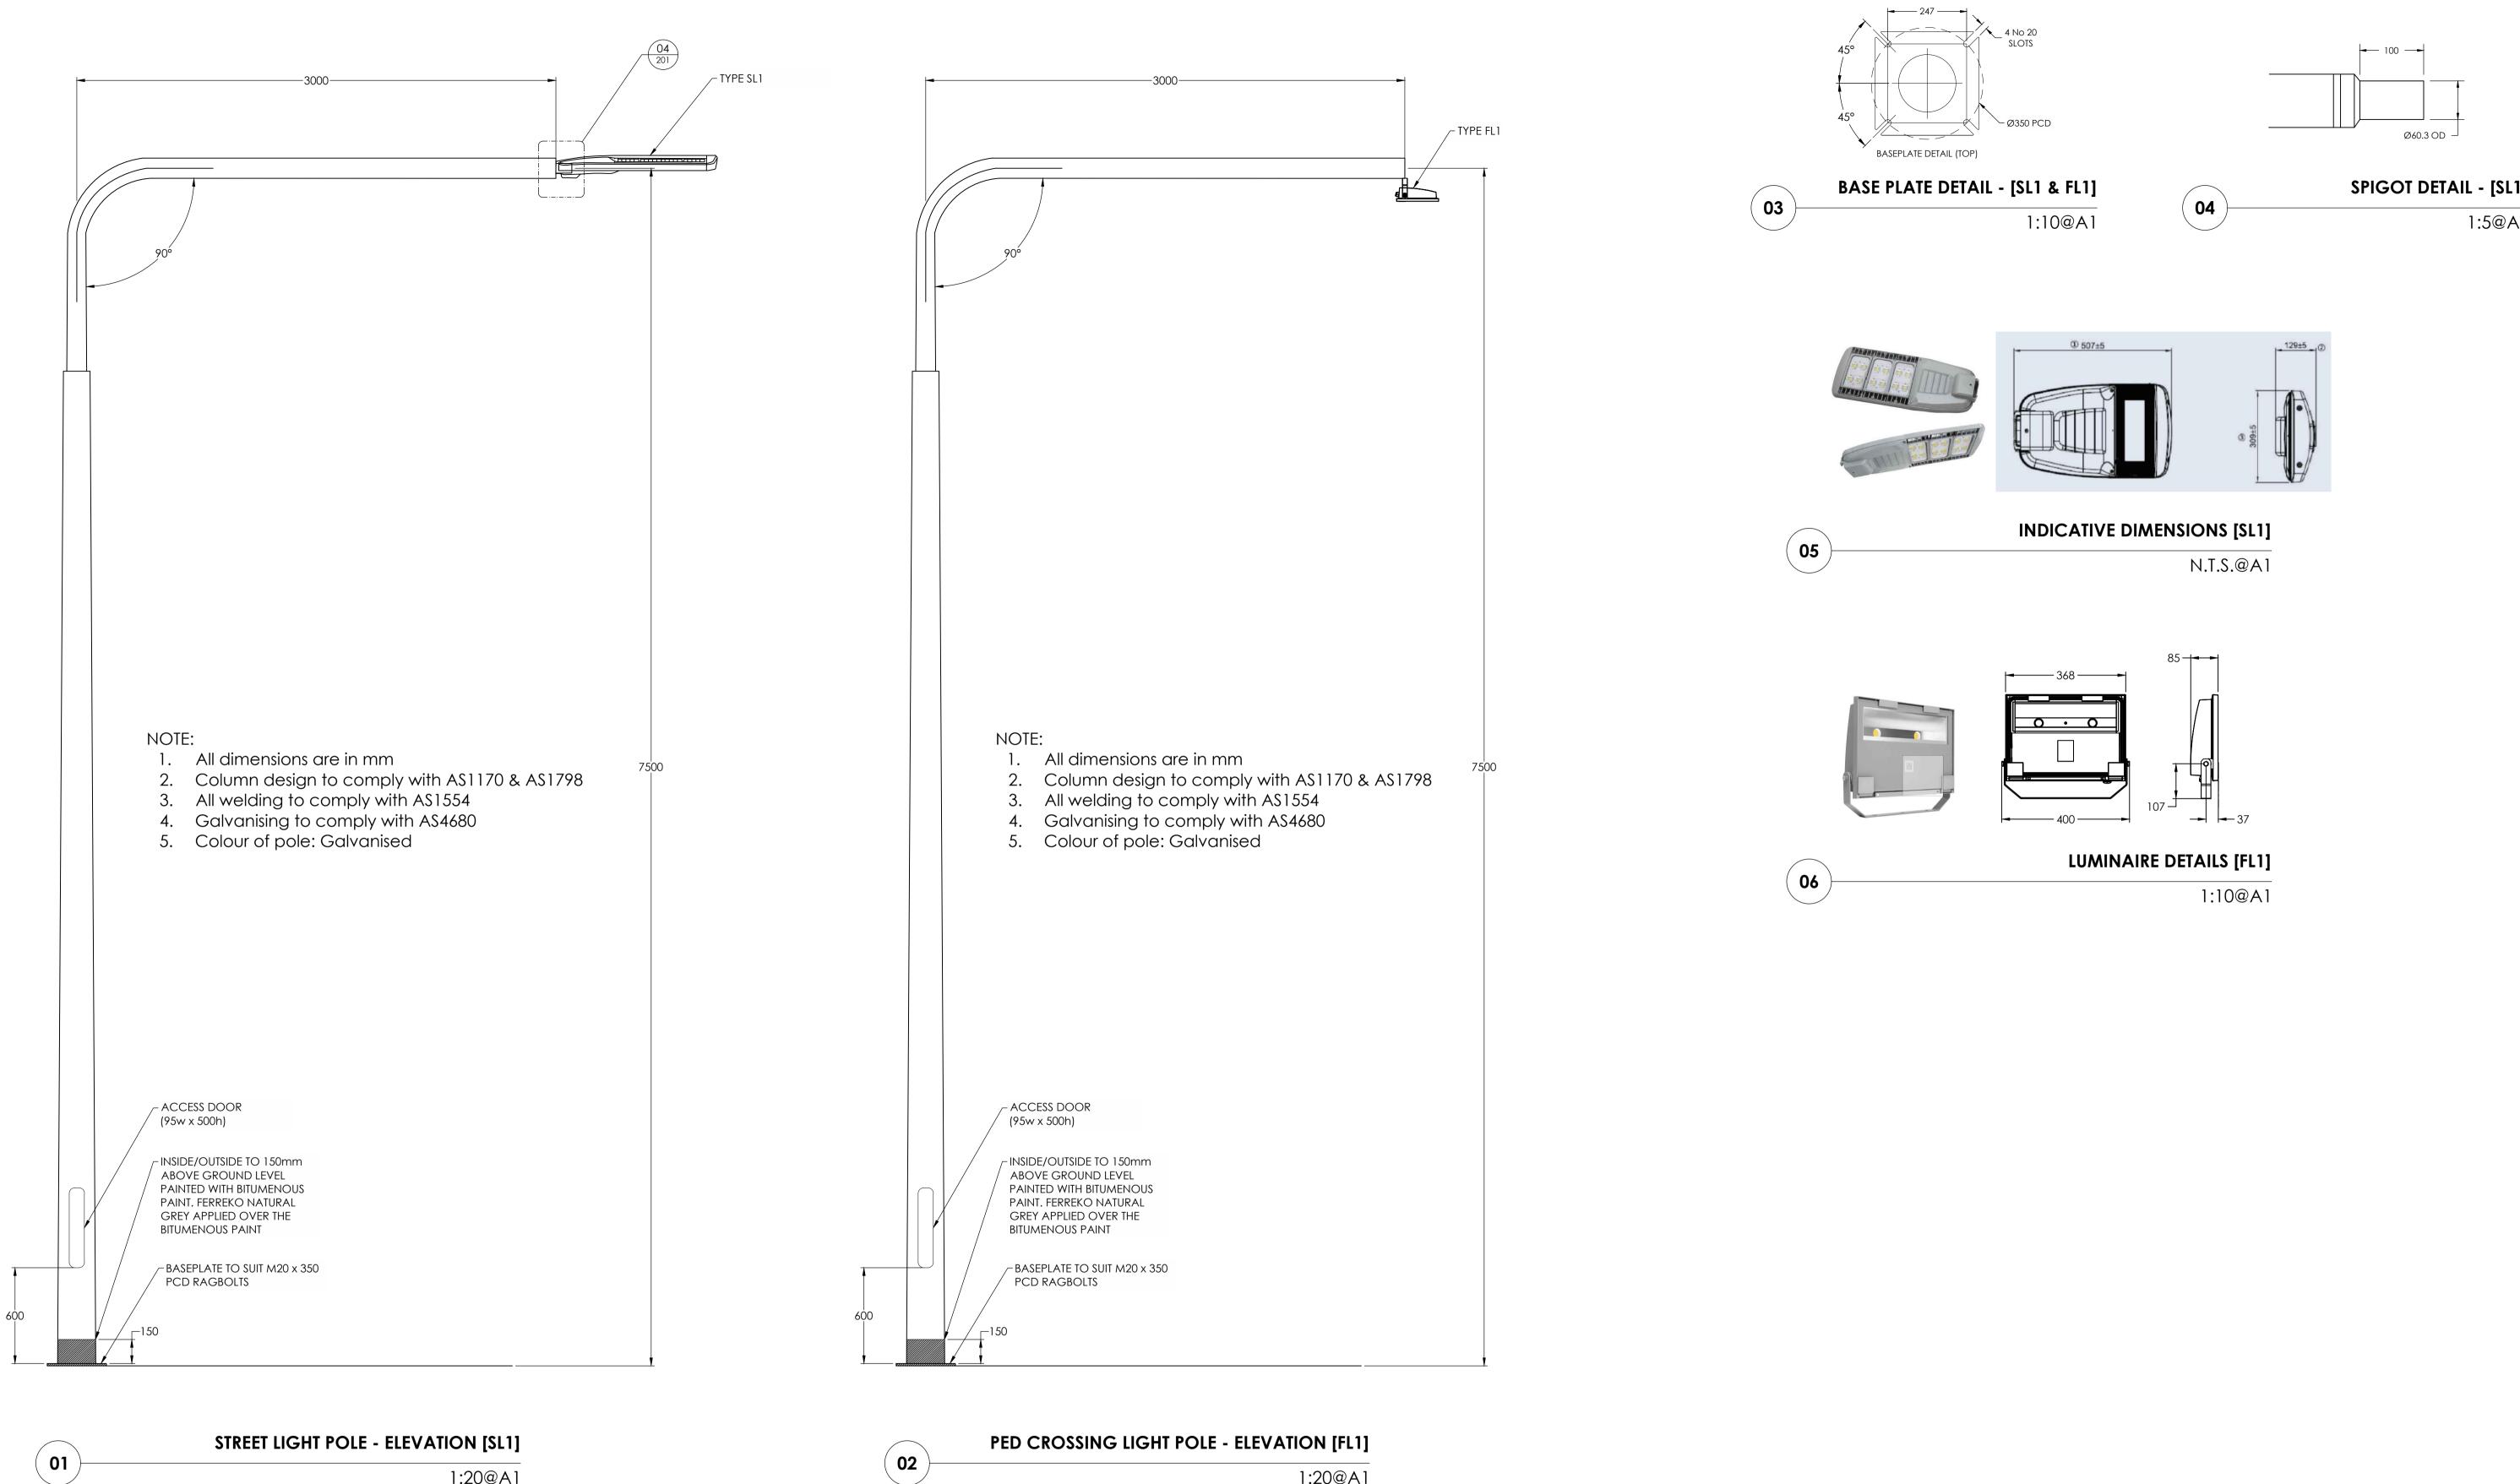

1:20@A1

Amendment lssue PRELIMINARY ISSUE P1 P2 50% ISSUE

Date 12-07-23 17-07-23

1:20@A1



SPIGOT DETAIL - [SL1]

1:5@A1




Project GUNYAMA PARK STAGE 2


Drawing LIGHTING DETAILS SHEET 01 Drawn MA Approv. RM Project No L177D


Date JUN 2023 Drawing No EL-201



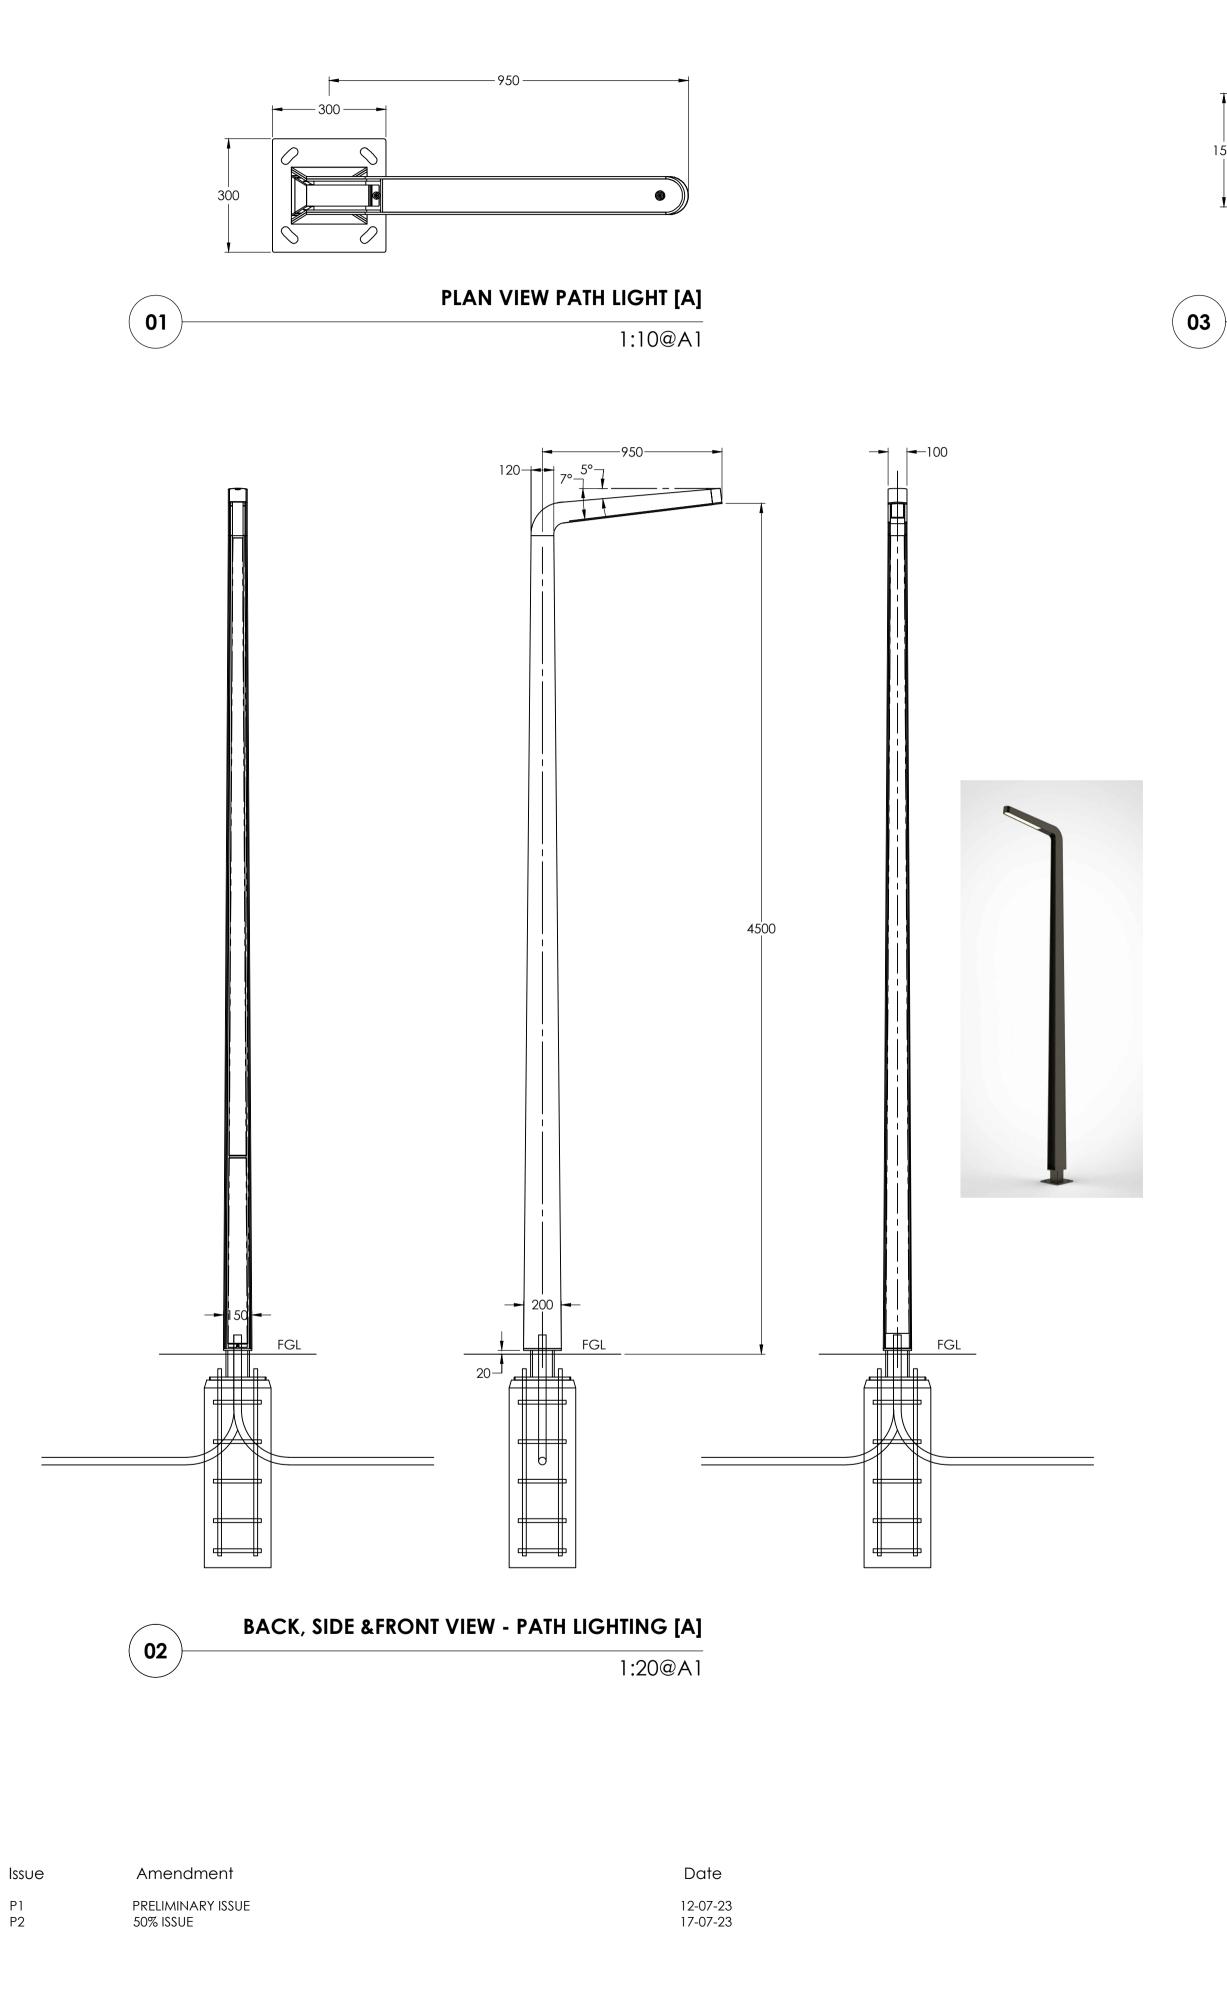

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Project GUNYAMA PARK STAGE 2

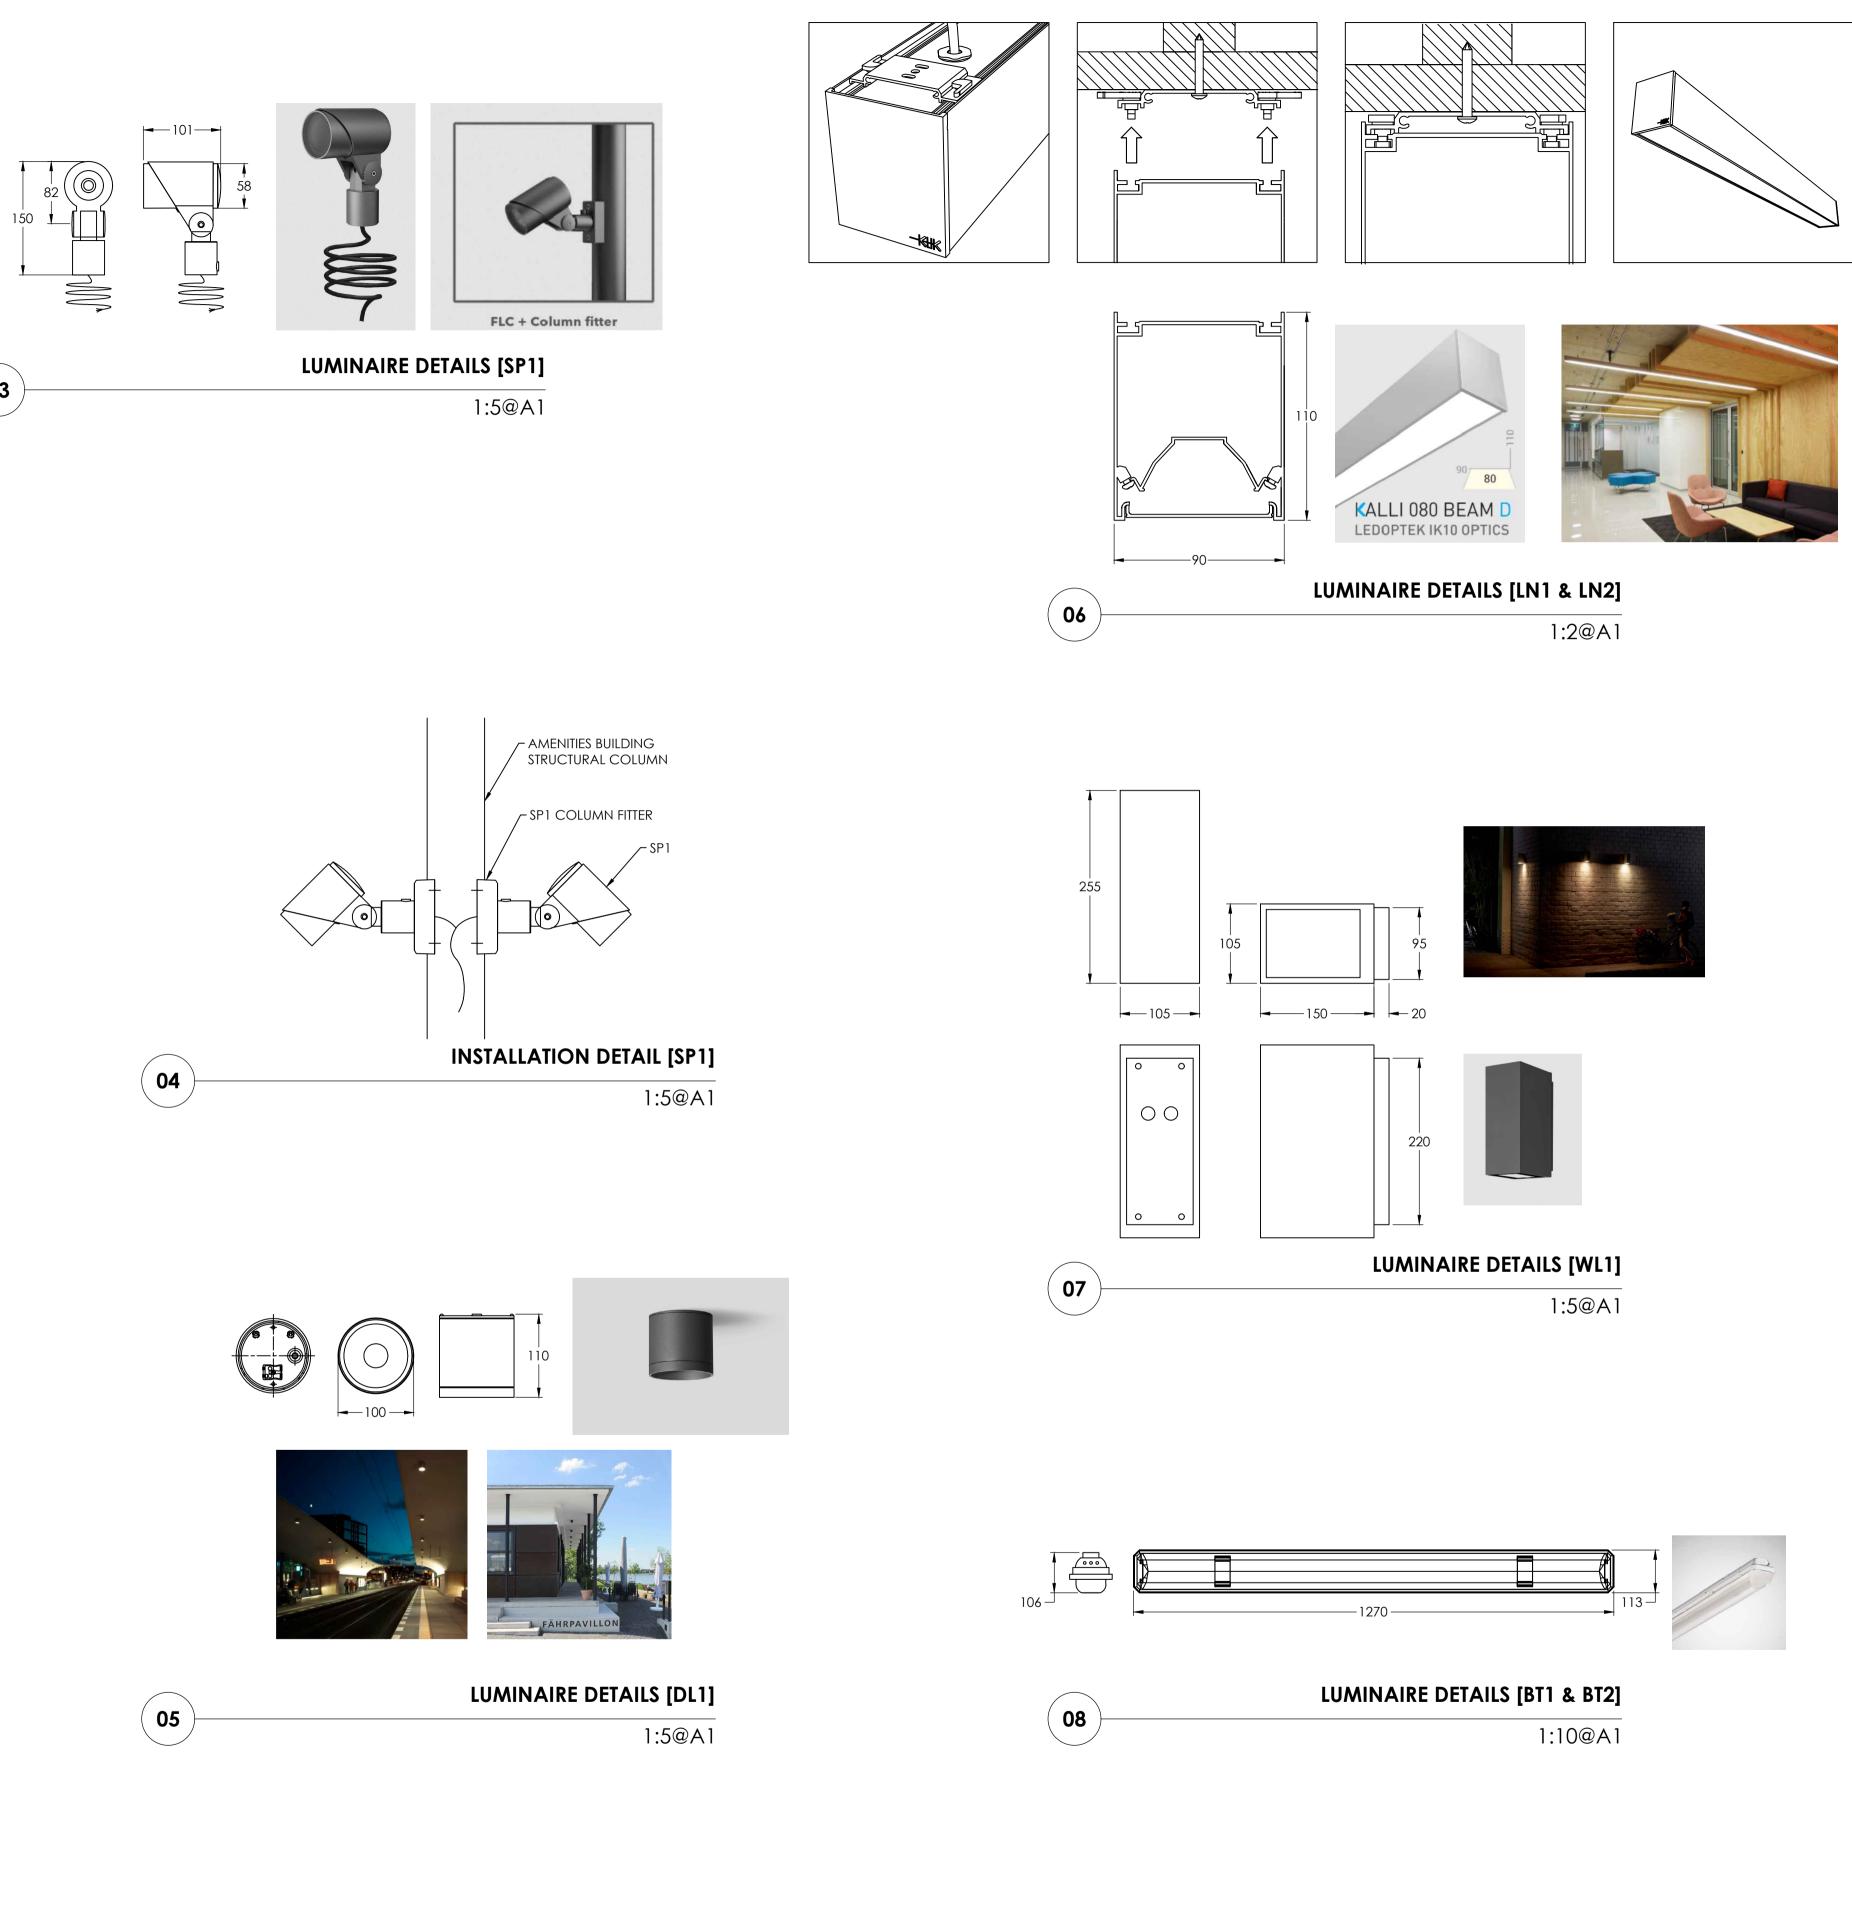Drawing LIGHTING DETAILS SHEET 02 Drawn MA Approv. RM Drawing No Project No

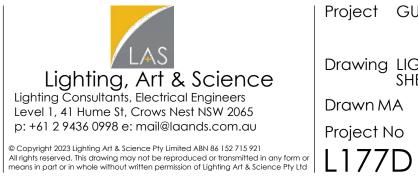Date JUN 2023 EL-202



GUNYAMA PARK - STAGE 2 INTERNALS **CIVIL ENGINEERING PACKAGE**




LOCALITY PLAN

REVISION	DESCRIPTION	ISSUED	VER'D	APP'D	DATE	CLIENT	ARCHITECT
01	ISSUED FOR INFORMATION	BM		AR	10.07.23		
02	ISSUED FOR INFORMATION	BM		AR	17.07.23	CITYOFSYDNEY	
03	ISSUED FOR 50% DESIGN DEVELOPMENT	EJ		AR	19.07.23		
						DRAWING NOT TO BE USED FOR CONSTRUCTION UNLESS	THE COPYRIGHT
						VERIFICATION SIGNATURE HAS BEEN ADDED	NORTHROP CC



DWG No.	DRAWING T
C201.01	COVER SHEET, D
C201.11	SPECIFICATION N
C202.01	SEDIMENT AND S
C202.11	SEDIMENT AND S
C203.01	BULK EARTHWO
C204.01	SITEWORKS PLA
C213.01	DETAILS



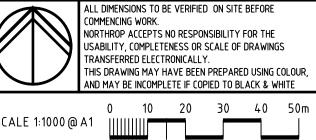



PROJECT **PROJECT NAME GUNYAMA PARK - STAGE 2**



TITLE DRAWING SCHEDULE AND LOCALITY PLAN NOTES SOIL EROSION CONTROL PLAN SOIL EROSION CONTROL DETAILS ORKS CUT AND FILL PLAN AN

THIS DRAWING SET UTILSES A COORDINATE SYSTEM
OF GDA94 MGA56. THE SURVEY RECEIVED ON
17/07/2023 WAS CONVERTED TO GDA94 FOR
INFORMATION AS IT WAS RECIVED ON THE DATE OF
ISSUE.

THE NEXT ISSUE WILL SHOW ALL ITEMS UPDATED TO GDA2020.

NOT FOR CONSTRUCTION

DRAWING TITLE CIVIL ENGINEERING PACKAGE

COVER SHEET, DRAWING SCHEDULE AND LOCALITY PLAN

JOB NUMBER 223309 DRAWING NUMBER REVISION C201.01 03 DRAWING SHEET SIZE = A1

ALL CIVIL ENGINEERING CONSTRUCTION WORKS TO BE CARRIED OUT IN ACCORDANCE WITH CITY OF SYDNEY, SYDNEY STREETS TECHNICAL SPECIFICATION. THE AFOREMENTIONED GUIDELINES INCLUSIVE OF ALL SPECIFICATIONS TAKE PRECEDENCE OVER NOTES PROVIDED BELOW EXISTING SERVICES ACCESS AND SAFETY 1. THE CONTRACTOR SHALL COMPLY WITH ALL STATUTORY AND 1. ALL UTILITY SERVICES INDICATED ON THE DRAWINGS ORIGINATE 12. WHERE THERE IS INSUFFICIENT EXCAVATED MATERIAL SUITABLE FOR INDUSTRIAL REQUIREMENTS FOR PROVISION OF A SAFE WORKING FROM SUPPLIED DATA OR DIAL BEFORE YOU DIG SEARCHES, FILLING OR SUBGRADE REPLACEMENT, THE CONTRACTOR IS TO ALLOW ENVIRONMENT INCLUDING TRAFFIC CONTROL. THEREFORE THEIR ACCURACY AND COMPLETENESS IS NOT TO IMPORT FILL. IMPORTED FILL SHALL COMPLY WITH THE FOLLOWING; GUARANTEED. IT IS THE RESPONSIBILITY OF THE CONTRACTOR TO 12.1 BE OF VIRGIN EXCAVATED NATURAL MATERIAL OR THE CONTRACTOR SHALL PROVIDE TRAFFIC MANAGEMENT PLANS 12.2 CONTRACTOR TO PROVIDE EVIDENCE IMPORT IS SUITABLE FOR USE DETERMINE AND CONFIRM THE LOCATION AND LEVEL OF ALL EXISTING FOR THE PROPOSED WORKS COMPLETED BY A SUITABLY QUALIFIED SERVICES PRIOR TO THE COMMENCEMENT OF ANY WORK. ANY 12.3 PLASTICITY INDEX BETWEEN 2-15% AND CBR > 8 12.4 FREE FROM ORGANIC AND PERISHABLE MATTER PERSON AND APPROVED BY COUNCIL / REGULATORY AUTHORITY. DISCREPANCIES SHALL BE REPORTED TO THE SUPERINTENDENT. WORK IS NOT TO COMMENCE ON SITE PRIOR TO APPROVAL OF CLEARANCES SHALL BE OBTAINED FROM THE RELEVANT SERVICE 12.5 MAXIMUM SIZE 50mm, PASSING 75 MICRON SIEVE (<25%) TRAFFIC MANAGEMENT SCHEME. AUTHORITY. NOTE SERVICE AUTHORITY REQUIREMENTS FOR LOCATING OF SERVICES PRIOR TO COMMENCEMENT OF WORKS. 13. THE CONTRACTOR SHALL PROGRAM THE EARTHWORKS OPERATION SO THE CONTRACTOR SHALL ENSURE THAT AT ALL TIMES ACCESS TO THAT THE WORKING AREAS ARE ADEQUATELY DRAINED DURING THE BUILDINGS ADJACENT THE WORKS IS NOT DISRUPTED. CARE TO BE TAKEN WHEN EXCAVATING NEAR EXISTING SERVICES. NO PERIOD OF CONSTRUCTION. THE SURFACE SHALL BE GRADED AND MECHANICAL EXCAVATIONS ARE TO BE UNDERTAKEN OVER SEALED OFF TO REMOVE DEPRESSIONS, ROLLERS MARKS AND SIMILAR COMMUNICATION. GAS OR ELECTRICAL SERVICES. HAND EXCAVATION WHICH WOULD ALLOW WATER TO POND AND PENETRATE THE WHERE NECESSARY THE CONTRACTOR SHALL PROVIDE SAFE PASSAGE OF VEHICLES AND/OR PEDESTRIANS THROUGH OR BY THE ONLY IN THESE AREAS. UNDERLYING MATERIAL. ANY DAMAGE RESULTING FROM THE SITE CONTRACTOR NOT OBSERVING THESE REQUIREMENTS SHALL BE 3. THE CONTRACTOR SHALL PROTECT AND MAINTAIN ALL EXISTING RECTIFIED AT THEIR COST. THE CONTRACTOR SHALL ENSURE PUBLIC ACCESS EXTERNAL TO THE SERVICES THAT ARE TO BE RETAINED IN THE VICINITY OF THE SITE IS IN ACCORDANCE WITH COUNCILS / AUTHORITY / SITE PROPOSED WORKS. ANY AND ALL DAMAGE TO THESE SERVICES AS A 14. IT IS THE RESPONSIBILITY OF THE CONTRACTOR TO ENSURE AND MANAGERS REQUIREMENTS. RESULT OF THESE WORKS SHALL BE REPAIRED BY THE CONTRACTOR MAINTAIN THE INTEGRITY OF ALL SERVICES, CONDUITS AND PIPES UNDER THE DIRECTION OF THE SUPERINTENDENT AT THE DURING CONSTRUCTION, SPECIFICALLY DURING THE BACKFILLING AND CONTRACTORS EXPENSE. COMPACTION PROCEDURE. ANY AND ALL DAMAGE TO NEW OR EXISTING SERVICES AS A RESULT OF THESE WORKS SHALL BE 4. THE CONTRACTOR SHALL ALLOW IN THE PROGRAM FOR THE REPAIRED BY THE CONTRACTOR AT NO ADDITIONAL COST. TREE PROTECTION ADJUSTMENT (IF REQUIRED) OF EXISTING SERVICES IN AREAS AFFECTED BY WORKS. 15. THE CONTRACTOR IS TO PROVIDE SAFETY BARRIERS, FENCING AND REFER TO LANDSCAPE / ARCHITECTS/NORTHROPS PLAN & THE CONTRACTOR SHALL ALLOW IN THE PROGRAM FOR THE CAPPING THE LIKE IN ACCORDANCE WITH OH&S AND REGULATORY AUTHORITY SPECIFICATION FOR TREES TO BE RETAINED AND PROTECTED. REQUIREMENTS AND TO ENSURE THE WORK SITE IS SAFE AT ALL OFF, EXCAVATION AND REMOVAL (IF REQUIRED) OF EXISTING SERVICES IN AREAS AFFECTED BY WORKS UNLESS DIRECTED TIMES. ANY EXISTING/PROPOSED TREES WHICH FORM PART OF THE FINAL OTHERWISE ON THE DRAWINGS OR BY THE SUPERINTENDENT. LANDSCAPING PLAN SHALL BE PROTECTED FROM CONSTRUCTION ACTIVITIES BY; 6. THE CONTRACTOR SHALL ENSURE THAT AT ALL TIMES SERVICES TO 2.1. PROTECTING THEM WITH BARRIER FENCING OR SIMILAR ALL BUILDINGS ARE NOT AFFECTED BY THE WORKS AND ARE MATERIALS INSTALLED OUTSIDE THE DRIP LINE. MAINTAINED AND NOT DISRUPTED. ENSURING THAT NOTHING IS NAILED TO ANY PART OF THE TREE GENERAL NOTES 2.3. CARE IS TAKEN NOT TO CUT ROOTS UNNECESSARILY. COUNCILS 7. PRIOR TO COMMENCEMENT OF ANY WORKS THE CONTRACTOR SHALL AND/OR INDEPENDENT ARBORISTS TO BE CONSULTED WHERE GAIN APPROVAL OF THE PROGRAM FOR THE RELOCATION AND/OR TREE ROOTS ARE TO BE REMOVED AND/OR CUT. THESE DRAWINGS SHALL BE READ IN CONJUNCTION WITH OTHER CONSTRUCTION OF TEMPORARY SERVICES AND FOR ANY ASSOCIATED CONSULTANTS' DRAWINGS AND SPECIFICATIONS AND WITH OTHER SUCH INTERRUPTION OF SUPPLY. WRITTEN INSTRUCTIONS AS MAY BE ISSUED DURING THE COURSE OF THE THE CONTRACTOR SHALL CONSTRUCT TEMPORARY SERVICES TO CONTRACT. ANY DISCREPANCY SHALL BE REFERRED TO THE ENGINEER SEDIMENT AND SOIL EROSION BEFORE PROCEEDING WITH THE WORK. MAINTAIN EXISTING SUPPLY TO BUILDINGS REMAINING IN OPERATION DURING WORKS TO THE SATISFACTION AND APPROVAL OF THE SUPERINTENDENT. ONCE DIVERSION IS COMPLETE AND COMMISSIONED ALL DIMENSIONS ARE IN MILLIMETRES & ALL LEVELS ARE IN METRES, UNO THE SEDIMENT & EROSION CONTROL PLAN PRESENTS CONCEPTS THE CONTRACTOR SHALL REMOVE ALL SUCH TEMPORARY SERVICES (UNLESS NOTED OTHERWISE). ONLY. THE CONTRACTOR SHALL AT ALL TIMES BE RESPONSIBLE FOR AND MAKE GOOD TO THE SATISFACTION OF THE SUPERINTENDENT. THE ESTABLISHMENT & MANAGEMENT OF A DETAILED SCHEME NO DIMENSION SHALL BE OBTAINED BY SCALING THE DRAWINGS. MEETING COUNCILS AND OTHER REGULATORY AUTHORITY 9. THE CONTRACTOR IS TO ALLOW TO POTHOLE ANY SERVICES WITHIN REQUIREMENTS AND MAKE PAYMENT OF ALL FEES. A PUBLIC RESERVE WITHIN THE EXTENT OF WORKS (E.G. ALL LEVELS AND SETTING OUT DIMENSIONS SHOWN ON THE DRAWINGS STORMWATER CROSSINGS). SHALL BE CHECKED ON SITE PRIOR TO THE COMMENCEMENT OF THE WORK. THE CONTRACTOR SHALL INSTIGATE ALL SEDIMENT AND EROSION CONTROL MEASURES IN ACCORDANCE WITH STATUTORY SURVEY DATA WAS SUPPLIED BY CARDNO, DRAWING DATED 29.01.2016. REQUIREMENTS AND IN PARTICULAR THE 'BLUE BOOK' (MANAGING THIS DESIGN HAS BEEN PREPARED WITHOUT ACCESS TO DETAILED URBAN STORMWATER SOILS AND CONSTRUCTION), PRODUCED BY SURVEY OF ROAD CORRIDOR LANDCOM AND COUNCILS POLICIES. THESE MEASURES ARE TO BE STANDARD DETAILS 2. FINAL DESIGN ALIGNMENT AND LEVELS SUBJECT TO CHANGE UPON INSPECTED AND MAINTAINED ON A DAILY BASIS. RECEIPT OF SURVEY THE CONTRACTOR SHALL ENSURE THAT ALL SOIL AND WATER ANY DISCREPANCIES TO BE REPORTED IMMEDIATELY TO NORTHROP MANAGEMENT WORKS ARE LOCATED AS INSTRUCTED IN THE EXISTING SERVICES WHERE SHOWN HAVE BEEN PLOTTED FROM SUPPLIED ENGINEERS FOR CLARIFICATION DRAWINGS AND ADHERE TO ALL REGULATORY AUTHORITY DATA AND SUCH THEIR ACCURACY CAN NOT BE GUARANTEED. IT IS THE REQUIREMENTS. RESPONSIBILITY OF THE CONTRACTOR TO ESTABLISH THE LEVEL OF ALL COUNCIL DETAILS - CITY OF SYDNEY EXISTING SERVICES PRIOR TO THE COMMENCEMENT OF WORK. DRAWING TITLE <u>COMPONENT</u> DWG REFERENCE THE CONTRACTOR SHALL INFORM ALL SUB CONTRACTORS OF THEIR RESPONSIBILITIES IN MINIMISING THE POTENTIAL FOR SOIL EROSION ON COMPLETION OF STORMWATER INSTALLATION, ALL DISTURBED AREAS FOOTPATH - CONCRETE 2.3.1, 2.3.4, 2.3.5, AND POLLUTION TO DOWNSTREAM LANDS AND WATERWAYS. /ARIES MUST BE RESTORED TO ORIGINAL CONDITION, INCLUDING KERBS, UNIT PAVING 2.3.8, 2.3.11 FOOTPATHS, CONCRETE AREAS, GRAVEL AND GRASSED AREAS AND ROAD WHERE PRACTICAL. THE SOIL EROSION HAZARD ON THE SITE SHALL PAVEMENTS, UNLESS DIRECTED OTHERWISE. ROAD - ASPHALT BE KEPT AS LOW AS POSSIBLE. TO THIS END, WORKS SHOULD BE 3.1.1 YPICAL PAVEMENT DETAILS PAVEMENT UNDERTAKEN IN THE FOLLOWING SEQUENCE; PARKING – CONCRETE 5.1. CONSTRUCT TEMPORARY STABILISED SITE ACCESS INCLUSIVE OF 3.1.10 CONCRETE UNIT PAVEMENT UNIT PAVING SHAKE DOWN / WASH PAD. CAST IN-SITU KERB AND 5.2. INSTALL ALL TEMPORARY SEDIMENT FENCES AND BARRIER KERBS 1.1.2 GUTTER DETAILS FENCES, WHERE FENCES ADJACENT EACH OTHER. THE SEDIMENT FENCE CAN BE INCORPORATED INTO THE BARRIER FENCE. CONCRETE UNIT PAVING ALL STORMWATER MANAGEMENT MEASURES SHOWN ON THIS DRAWING VEHICLE CROSSING 2.3.9 5.3. INSTALL SEDIMENT CONTROL MEASURES AS OUTLINED ON THE VEHICULAR CROSSING HAVE BEEN PREPARED FOR DEVELOPMENT APPLICATION PURPOSES TO APPROVED PLANS. DEMONSTRATE FEASIBILITY, ALL MEASURES WILL BE SUBJECT TO DETAIL CONCRETE UNIT PAVING KERB RAMPS 2.3.6 PEDESTRIAN RAMP DESIGN AT THE CONSTRUCTION CERTIFICATE STAGE AND MAY BE SUBJECT UNDERTAKE SITE DEVELOPMENT WORKS SO THAT LAND TO VARIATION PROVIDED THAT THE DESIGN INTENT IS MAINTAINED. DETAILS ARE PROVIDED ON THE BASIS THAT TYPICAL CITY OF SYDNEY DISTURBANCE IS CONFINED TO AREAS OF MINIMUM WORKABLE SIZE. 'SYDNEY STREETS STANDARD DRAWINGS' ARE TO BE USED. AT ALL TIMES AND IN PARTICULAR DURING WINDY AND DRY THE DEVELOPMENT MAY EXPLORE ALTERNATIVE DETAILS TO REDUCE WEATHER, LARGE UNPROTECTED AREAS WILL BE STABILISED / KEPT EMBODIED CARBON. THESE WILL BE PROVIDED TO CITY OF SYDNEY FOR APPROVAL. MOIST (NOT WET) TO KEEP DUST UNDER CONTROL ENSURING CONFORMITY TO REGULATORY AUTHORITY REQUIREMENTS. ANY SAND USED IN THE CONCRETE CURING PROCESS (SPREAD OVER THE SURFACE) SHALL BE REMOVED AS SOON AS POSSIBLE AND WITHIN 10 WORKING DAYS FROM PLACEMENT. WATER SHALL BE PREVENTED FROM ENTERING THE PERMANENT DRAINAGE SYSTEM UNLESS THE CATCHMENT AREA HAS BEEN STABILISED AND/OR ANY LIKELY SEDIMENT BEEN FILTERED OUT. 10. TEMPORARY SOIL AND WATER MANAGEMENT STRUCTURES SHALL BE REMOVED ONLY AFTER THE LANDS THEY ARE PROTECTING ARE STABILISED / REHABILITATED. 11. ALLOW FOR GRASS STABILISATION OF EXPOSED AREAS, OPEN CHANNELS AND ROCK BATTERS DURING ALL PHASES OF

REVISION	DESCRIPTION	ISSUED	VER'D	APP'D	DATE	CLIENT	ARCHITECT
01	ISSUED FOR INFORMATION	BM		AR	10.07.23		
02	ISSUED FOR INFORMATION	BM		AR	17.07.23	CITYOFSYDNEY	
03	ISSUED FOR 50% DESIGN DEVELOPMENT	EJ		AR	19.07.23		
						DRAWING NOT TO BE USED FOR CONSTRUCTION UNLESS	THE COPYRIGH
						VERIFICATION SIGNATURE HAS BEEN ADDED	NORTHROP C

CONSTRUCTION.

EVIDENCE OF SAFE DISPOSAL.

12. EROSION AND SEDIMENT CONTROL MEASURES SHALL BE INSPECTED TO ENSURE THAT THEY OPERATE EFFECTIVELY. REPAIRS AND/OR MAINTENANCE SHALL BE UNDERTAKEN REGULARLY AND AS REQUIRED, PARTICULARLY FOLLOWING RAIN EVENTS.

RECEPTORS FOR CONCRETE AND MORTAR SLURRIES, PAINTS, ACID WASHINGS, LIGHT-WEIGHT WASTE MATERIALS AND LITTER SHALL BE DISPOSED OF IN ACCORDANCE WITH REGULATORY AUTHORITY REQUIREMENTS. CONTRACTOR TO PAY ALL FEES AND PROVIDE

BATTER SLOPES IN ACCORDANCE WITH THE GEOTECHNICAL REPORT MAINTAIN ADEQUATE STORAGE VOLUME IN ACCORDANCE WITH PLANS. TEMPORARY PUMP 'CLEAN FLOCCULATED' WATER TO AUTHORITIES STORMWATER SYSTEM. ENSURE WHOLE DISTURBED SITE RUN-OFF IS DIRECTED TO TEMPORARY SEDIMENT BASIN.

14. IF A TEMPORARY SEDIMENT BASIN IS REQUIRED, ENSURE SAFE

place design group. THT OF THIS DRAWING REMAINS WITH CONSULTING ENGINEERS PTY LTD

L DIMENSIONS TO BE VERIFIED ON SITE BEFORE Ommencing Work. NORTHROP ACCEPTS NO RESPONSIBILITY FOR THE USABILITY, COMPLETENESS OR SCALE OF DRAWINGS TRANSFERRED ELECTRONICALLY THIS DRAWING MAY HAVE BEEN PREPARED USING COLOUR AND MAY BE INCOMPLETE IF COPIED TO BLACK & WHITE



PROJECT PROJECT NAME **GUNYAMA PARK - STAGE 2**

NOT FOR CONSTRUCTION

SPECIFICATION NOTES - SHEET 01

CIVIL ENGINEERING PACKAGE

DRAWING TITLE


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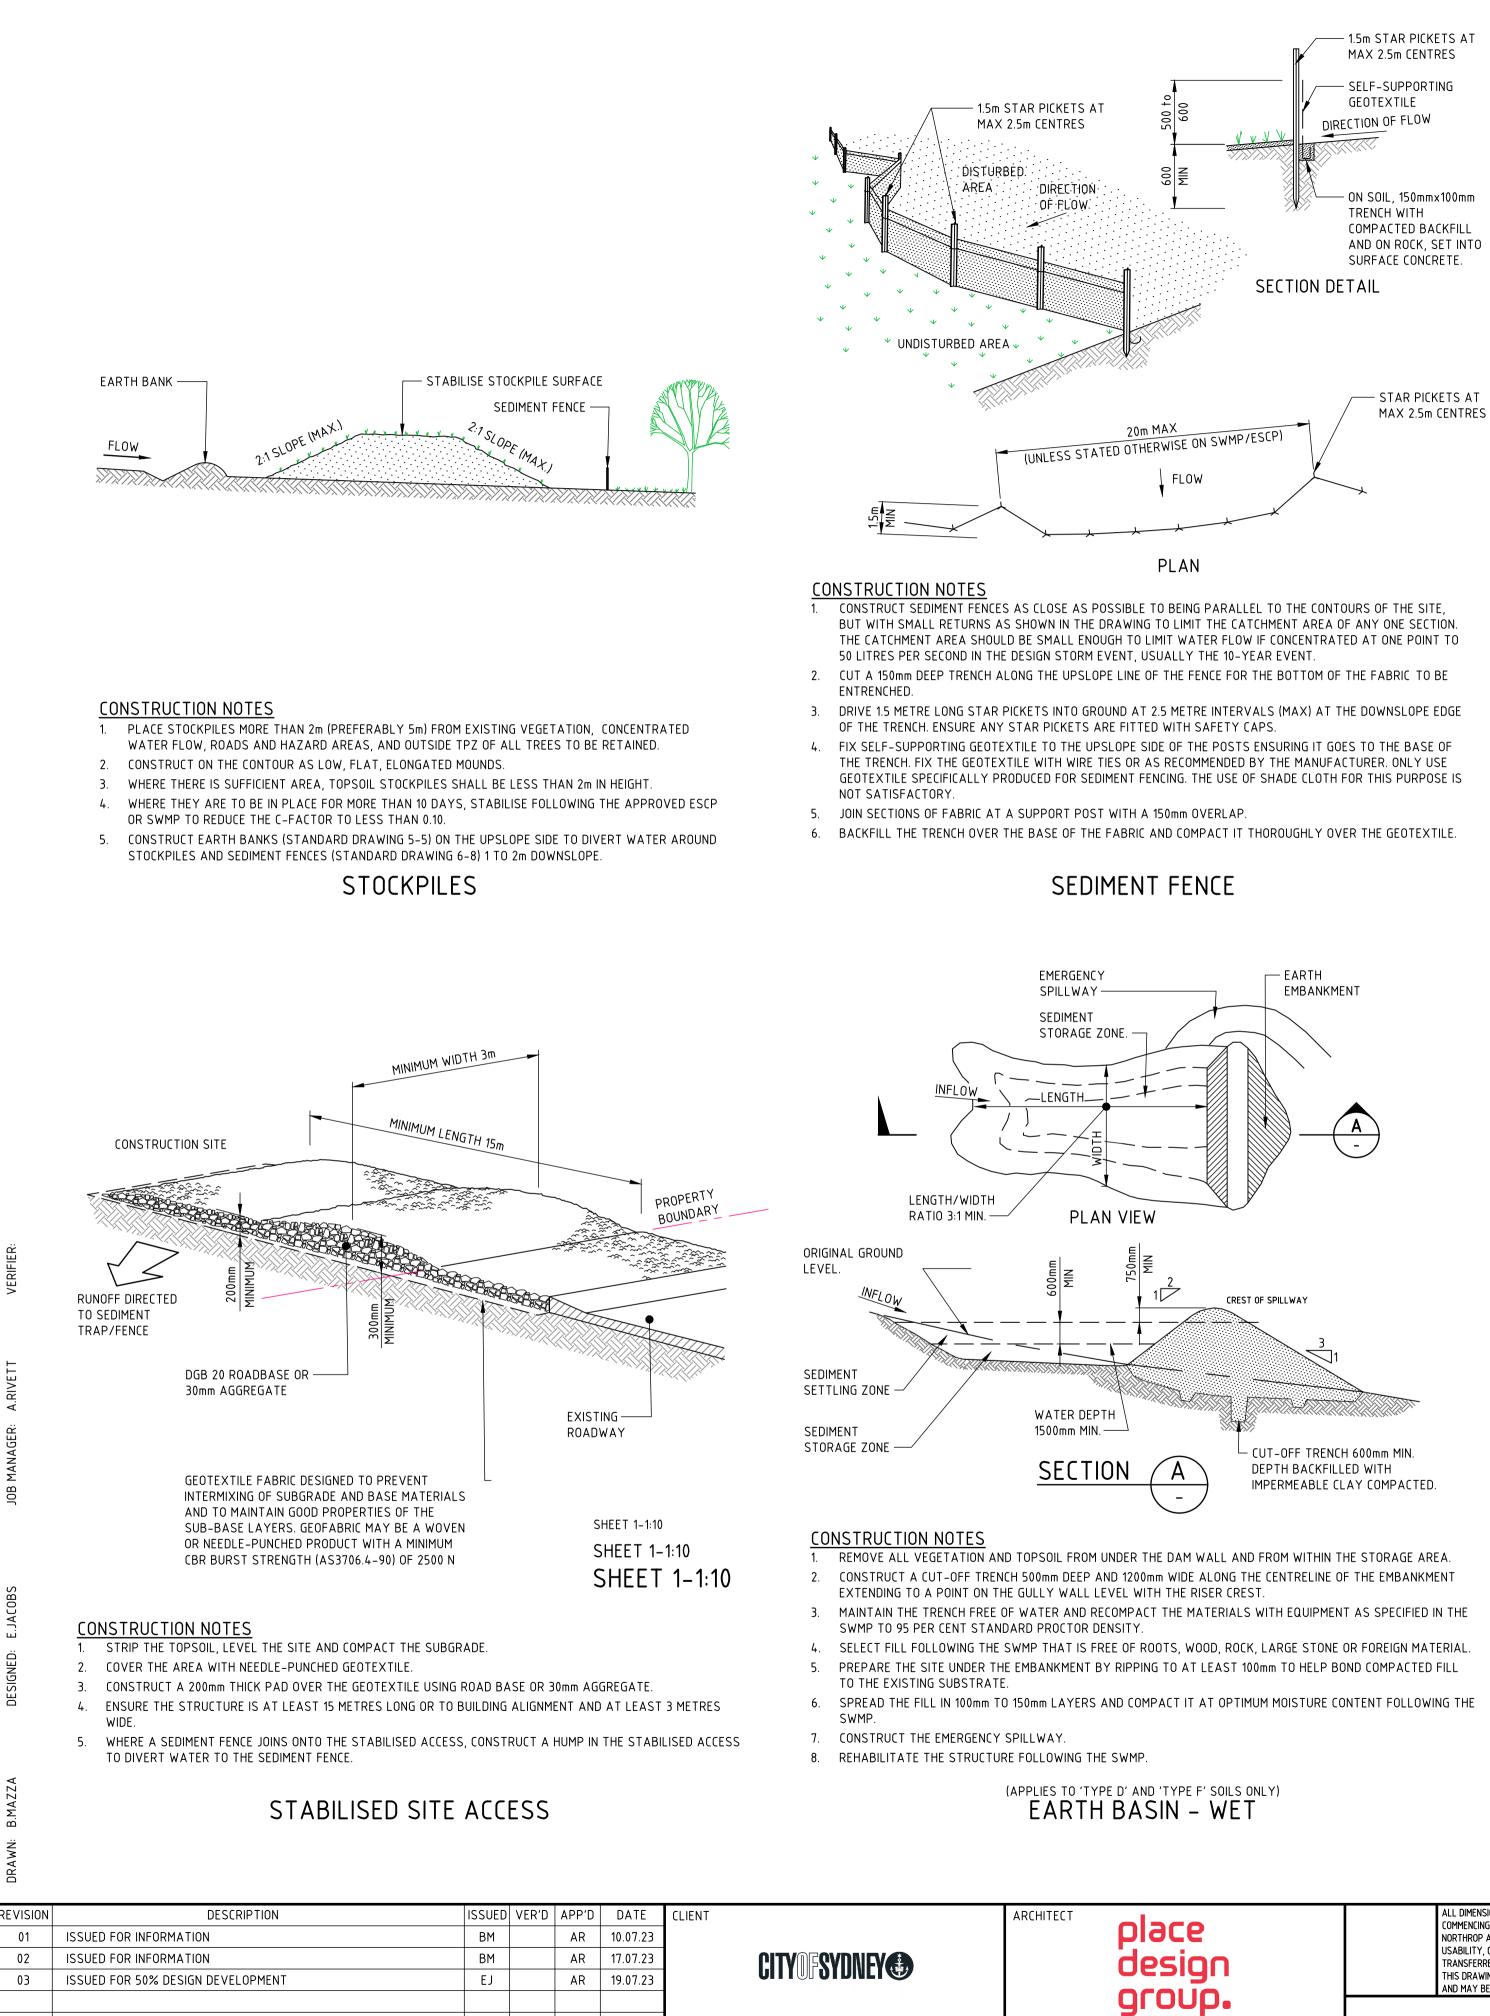
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REVISION

JOB NUMBER

DRAWING NUMBER



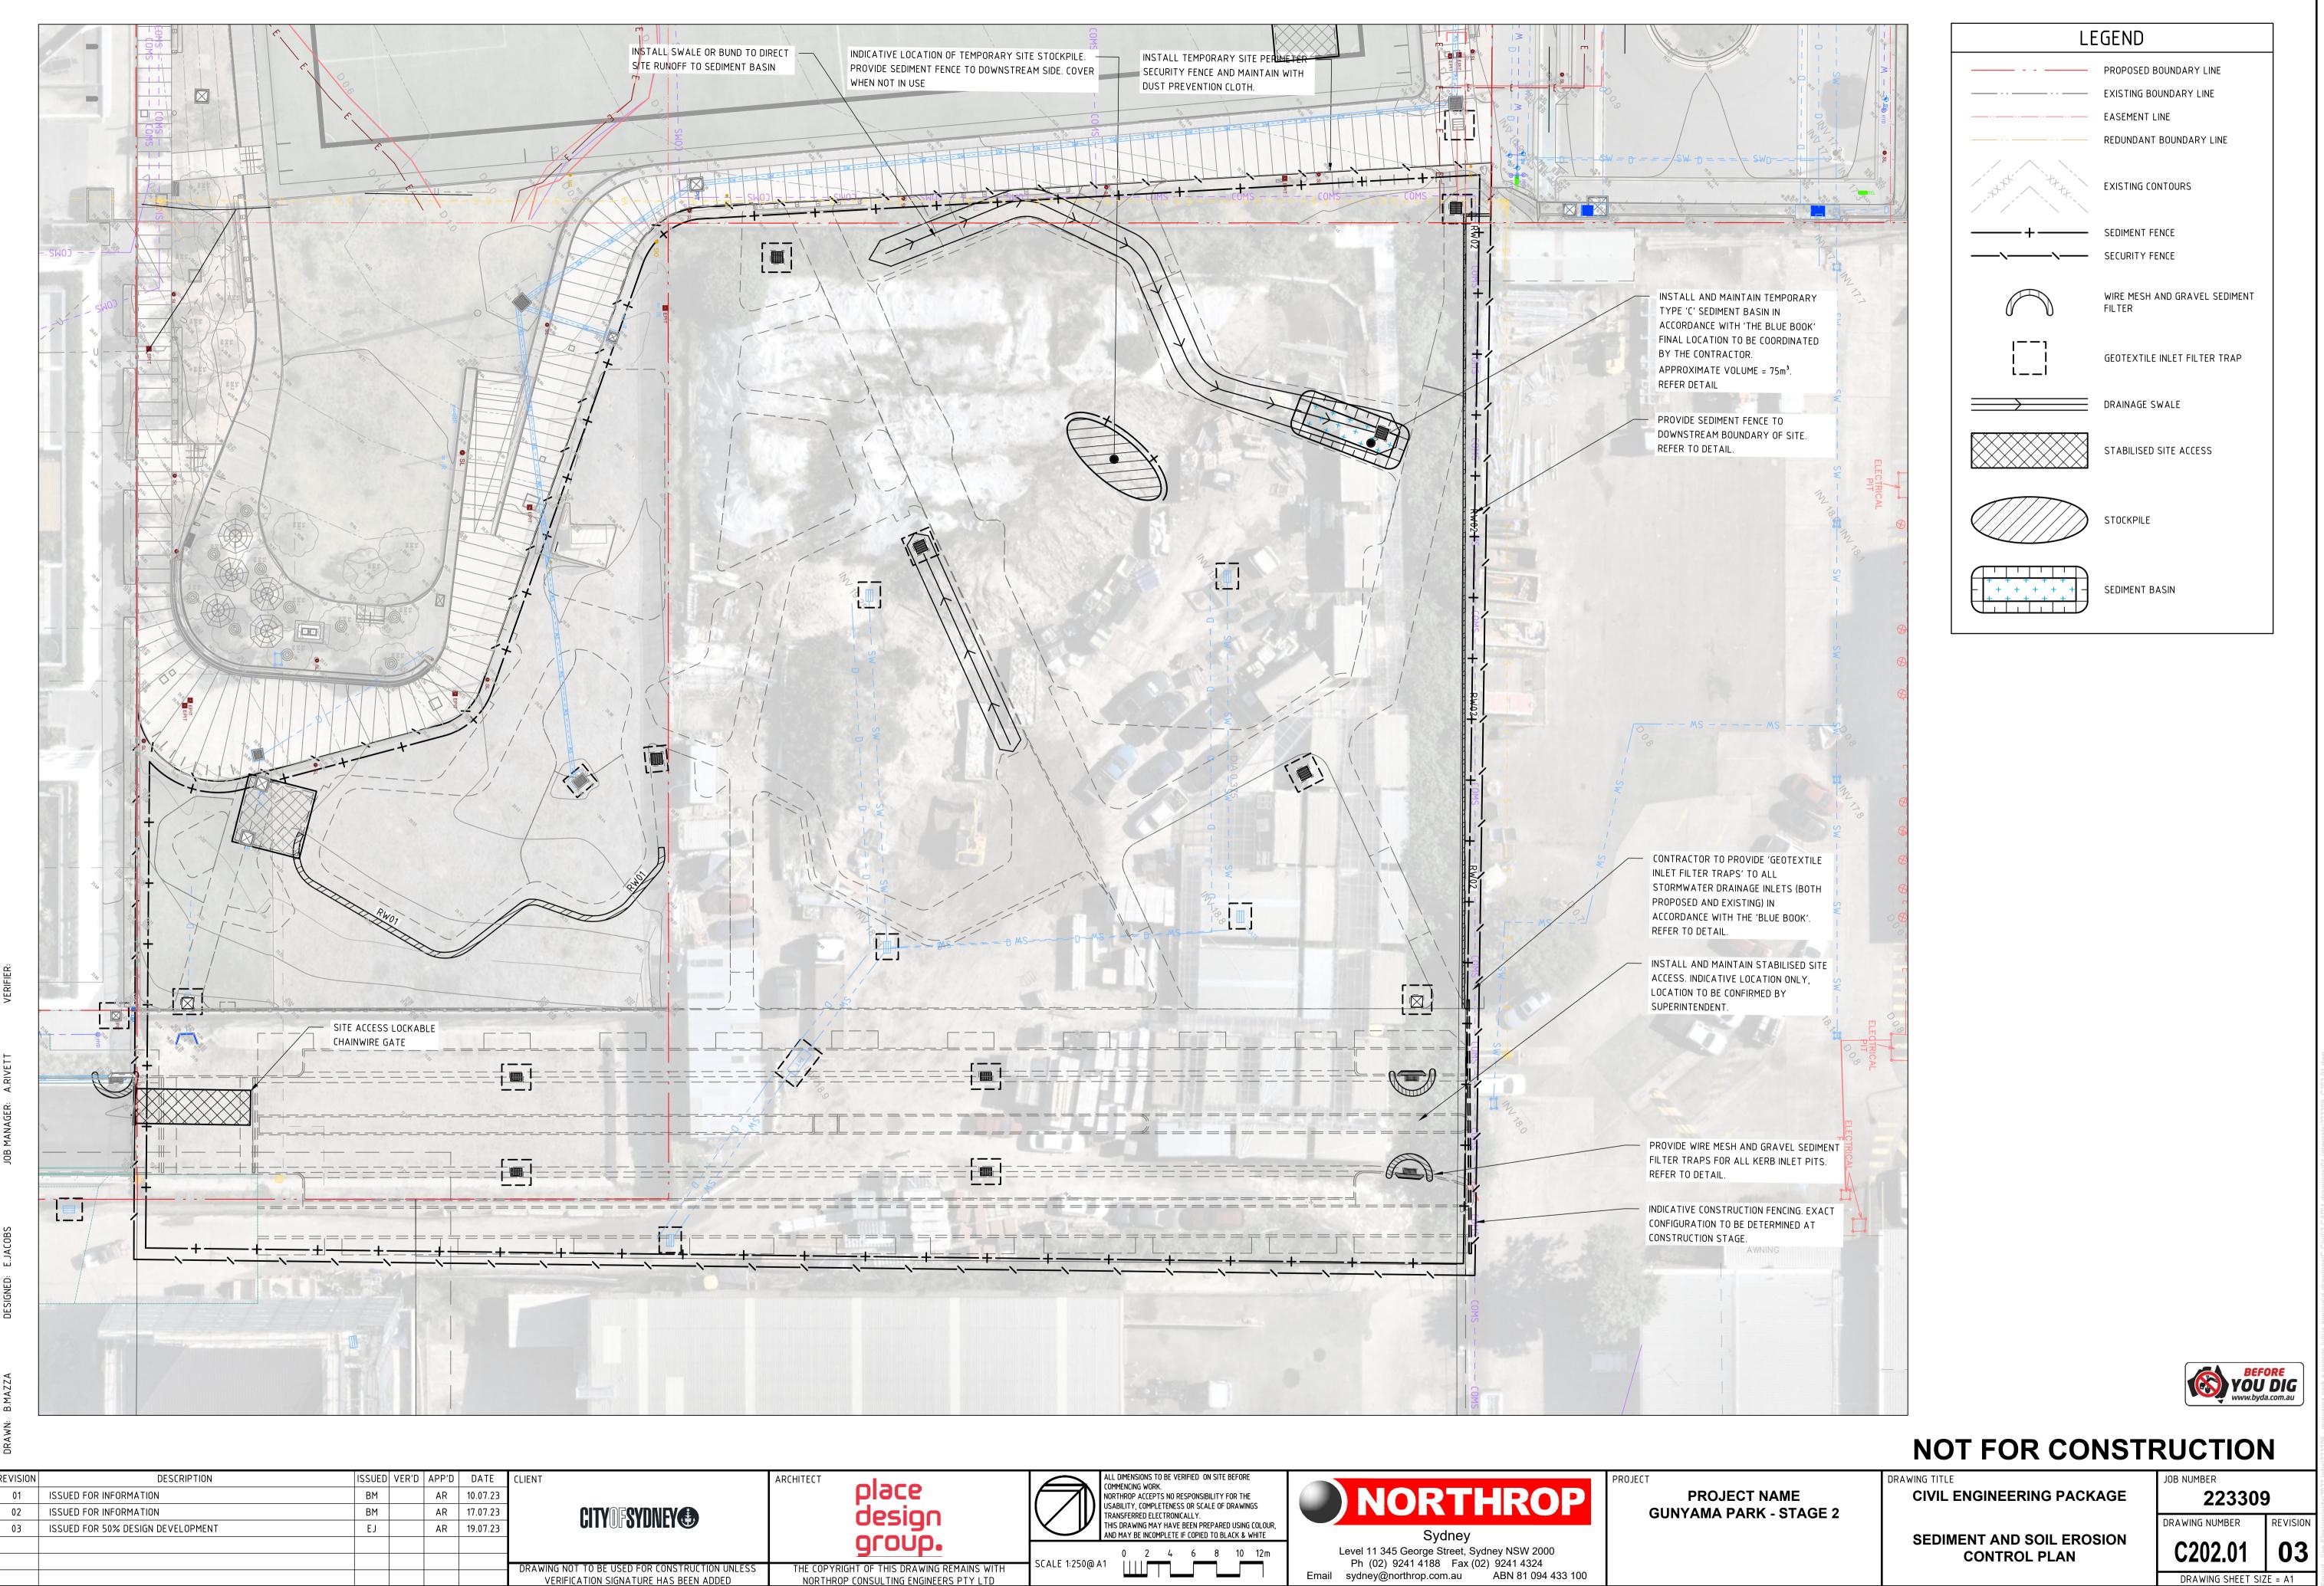

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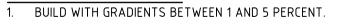
chitect design	ALL DIMENSIONS TO BE VERIFIED ON SITE BEFORE COMMENCING WORK. NORTHROP ACCEPTS NO RESPONSIBILITY FOR THE USABILITY, COMPLETENESS OR SCALE OF DRAWINGS TRANSFERRED ELECTRONICALLY.	NORTHROP
aroup.	THIS DRAWING MAY HAVE BEEN PREPARED USING COLOUR, AND MAY BE INCOMPLETE IF COPIED TO BLACK & WHITE	Sydney
<u> </u>		Level 11 345 George Street, Sydney NSW 2000 Ph (02) 9241 4188 Fax (02) 9241 4324
THE COPYRIGHT OF THIS DRAWING REMAINS WITH		Email sydney@northrop.com.au ABN 81 094 433 100

- 3. ENSURE THE STRUCTURES ARE FREE OF PROJECTIONS OR OTHER IRREGULARITIES THAT COULD IMPEDE WATER
- FLOW.
- 4. BUILD THE DRAINS WITH CIRCULAR, PARABOLIC OR TRAPEZOIDAL CROSS SECTIONS, NOT V SHAPED.
- 5. ENSURE THE BANKS ARE PROPERLY COMPACTED TO PREVENT FAILURE.
- 6. COMPLETE PERMANENT OR TEMPORARY STABILISATION WITHIN 10 DAYS OF CONSTRUCTION.

NOTE: ONLY TO BE USED AS TEMPORARY BANK


WHERE MAXIMUM UPSLOPE LENGTH IS 80 METRES. DRAINAGE SWALE - LOW FLOW

CONSTRUCTION NOTES




- 2. AVOID REMOVING TREES AND SHRUBS IF POSSIBLE WORK AROUND THEM.



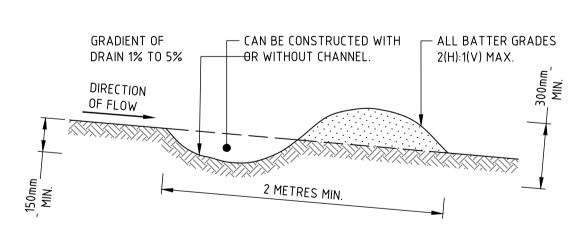

NORTHROP CONSULTING ENGINEERS PTY LTD

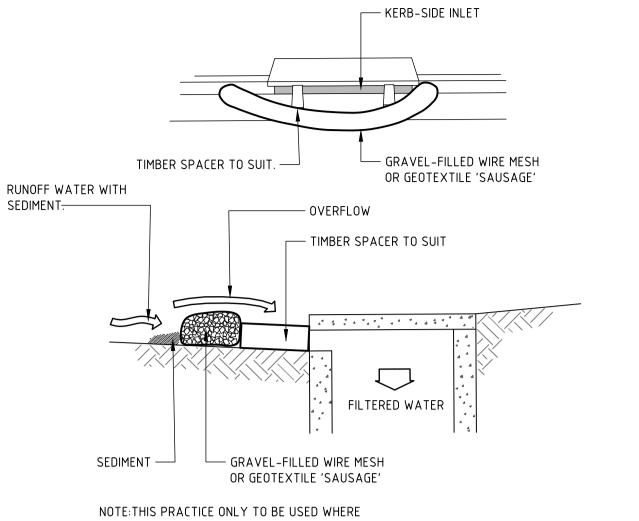

SPECIFIED IN APPROVED SWMP/ESCP.


CONSTRUCTION NOTES

- 1. INSTALL FILTERS TO KERB INLETS ONLY AT SAG POINTS.
- 2. FABRICATE A SLEEVE MADE FROM GEOTEXTILE OR WIRE MESH LONGER THAN THE LENGTH OF THE INLET PIT AND FILL IT WITH 25mm TO 50mm GRAVEL.
- 3. FORM AN ELLIPTICAL CROSS-SECTION ABOUT 150mm HIGH x 400mm WIDE. 4. PLACE THE FILTER AT THE OPENING LEAVING AT LEAST A 100mm SPACE BETWEEN IT AND THE KERB INLET.
- MAINTAIN THE OPENING WITH SPACER BLOCKS.
- 5. FORM A SEAL WITH THE KERB TO PREVENT SEDIMENT BYPASSING THE FILTER. 6. SANDBAGS FILLED WITH GRAVEL CAN SUBSTITUTE FOR THE MESH OR GEOTEXTILE PROVIDING THEY ARE PLACED SO THAT THEY FIRMLY ABUT EACH OTHER AND SEDIMENT-LADEN WATERS CANNOT PASS BETWEEN.

WIRE MESH AND GRAVEL SEDIMENT FILTER

PROJECT NAME **GUNYAMA PARK - STAGE 2**

PROJECT

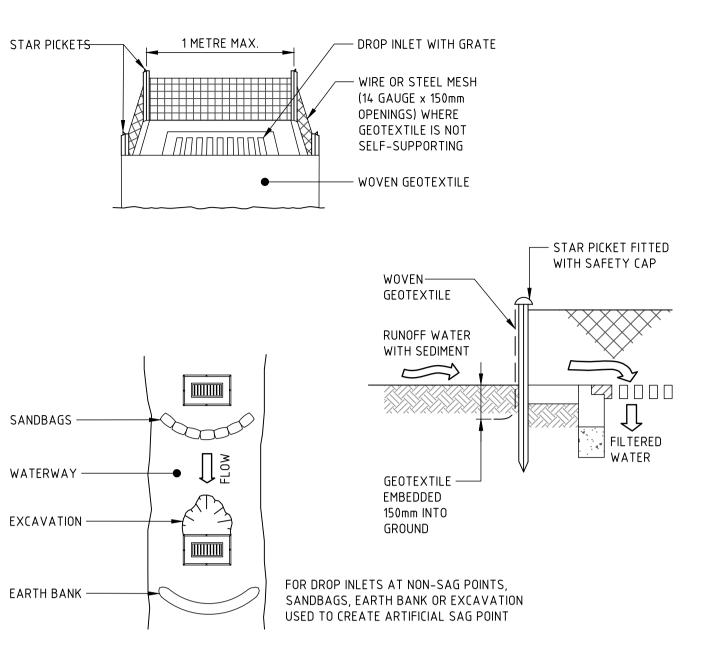

CONSTRUCTION NOTES

1. FABRICATE A SEDIMENT BARRIER MADE FROM GEOTEXTILE OR STRAW BALES.

2. FOLLOW STANDARD DRAWING 6-7 AND STANDARD DRAWING 6-8 FOR INSTALLATION PROCEDURES FOR THE STRAW BALES OR GEOFABRIC. REDUCE THE PICKET SPACING TO 1 METRE CENTRES. 3. IN WATERWAYS, ARTIFICIAL SAG POINTS CAN BE CREATED WITH SANDBAGS OR EARTH BANKS AS SHOWN IN THE DRAWING.

4. DO NOT COVER THE INLET WITH GEOTEXTILE UNLESS THE DESIGN IS ADEQUATE TO ALLOW FOR ALL WATERS TO BYPASS IT.


GEOTEXTILE INLET FILTER TRAPS

NOT FOR CONSTRUCTION


DRAWING TITLE CIVIL ENGINEERING PACKAGE

SEDIMENT AND SOIL EROSION **CONTROL DETAILS**


JOB NUMBER 223309 DRAWING NUMBER REVISION C202.1 03 DRAWING SHEET SIZE = A1

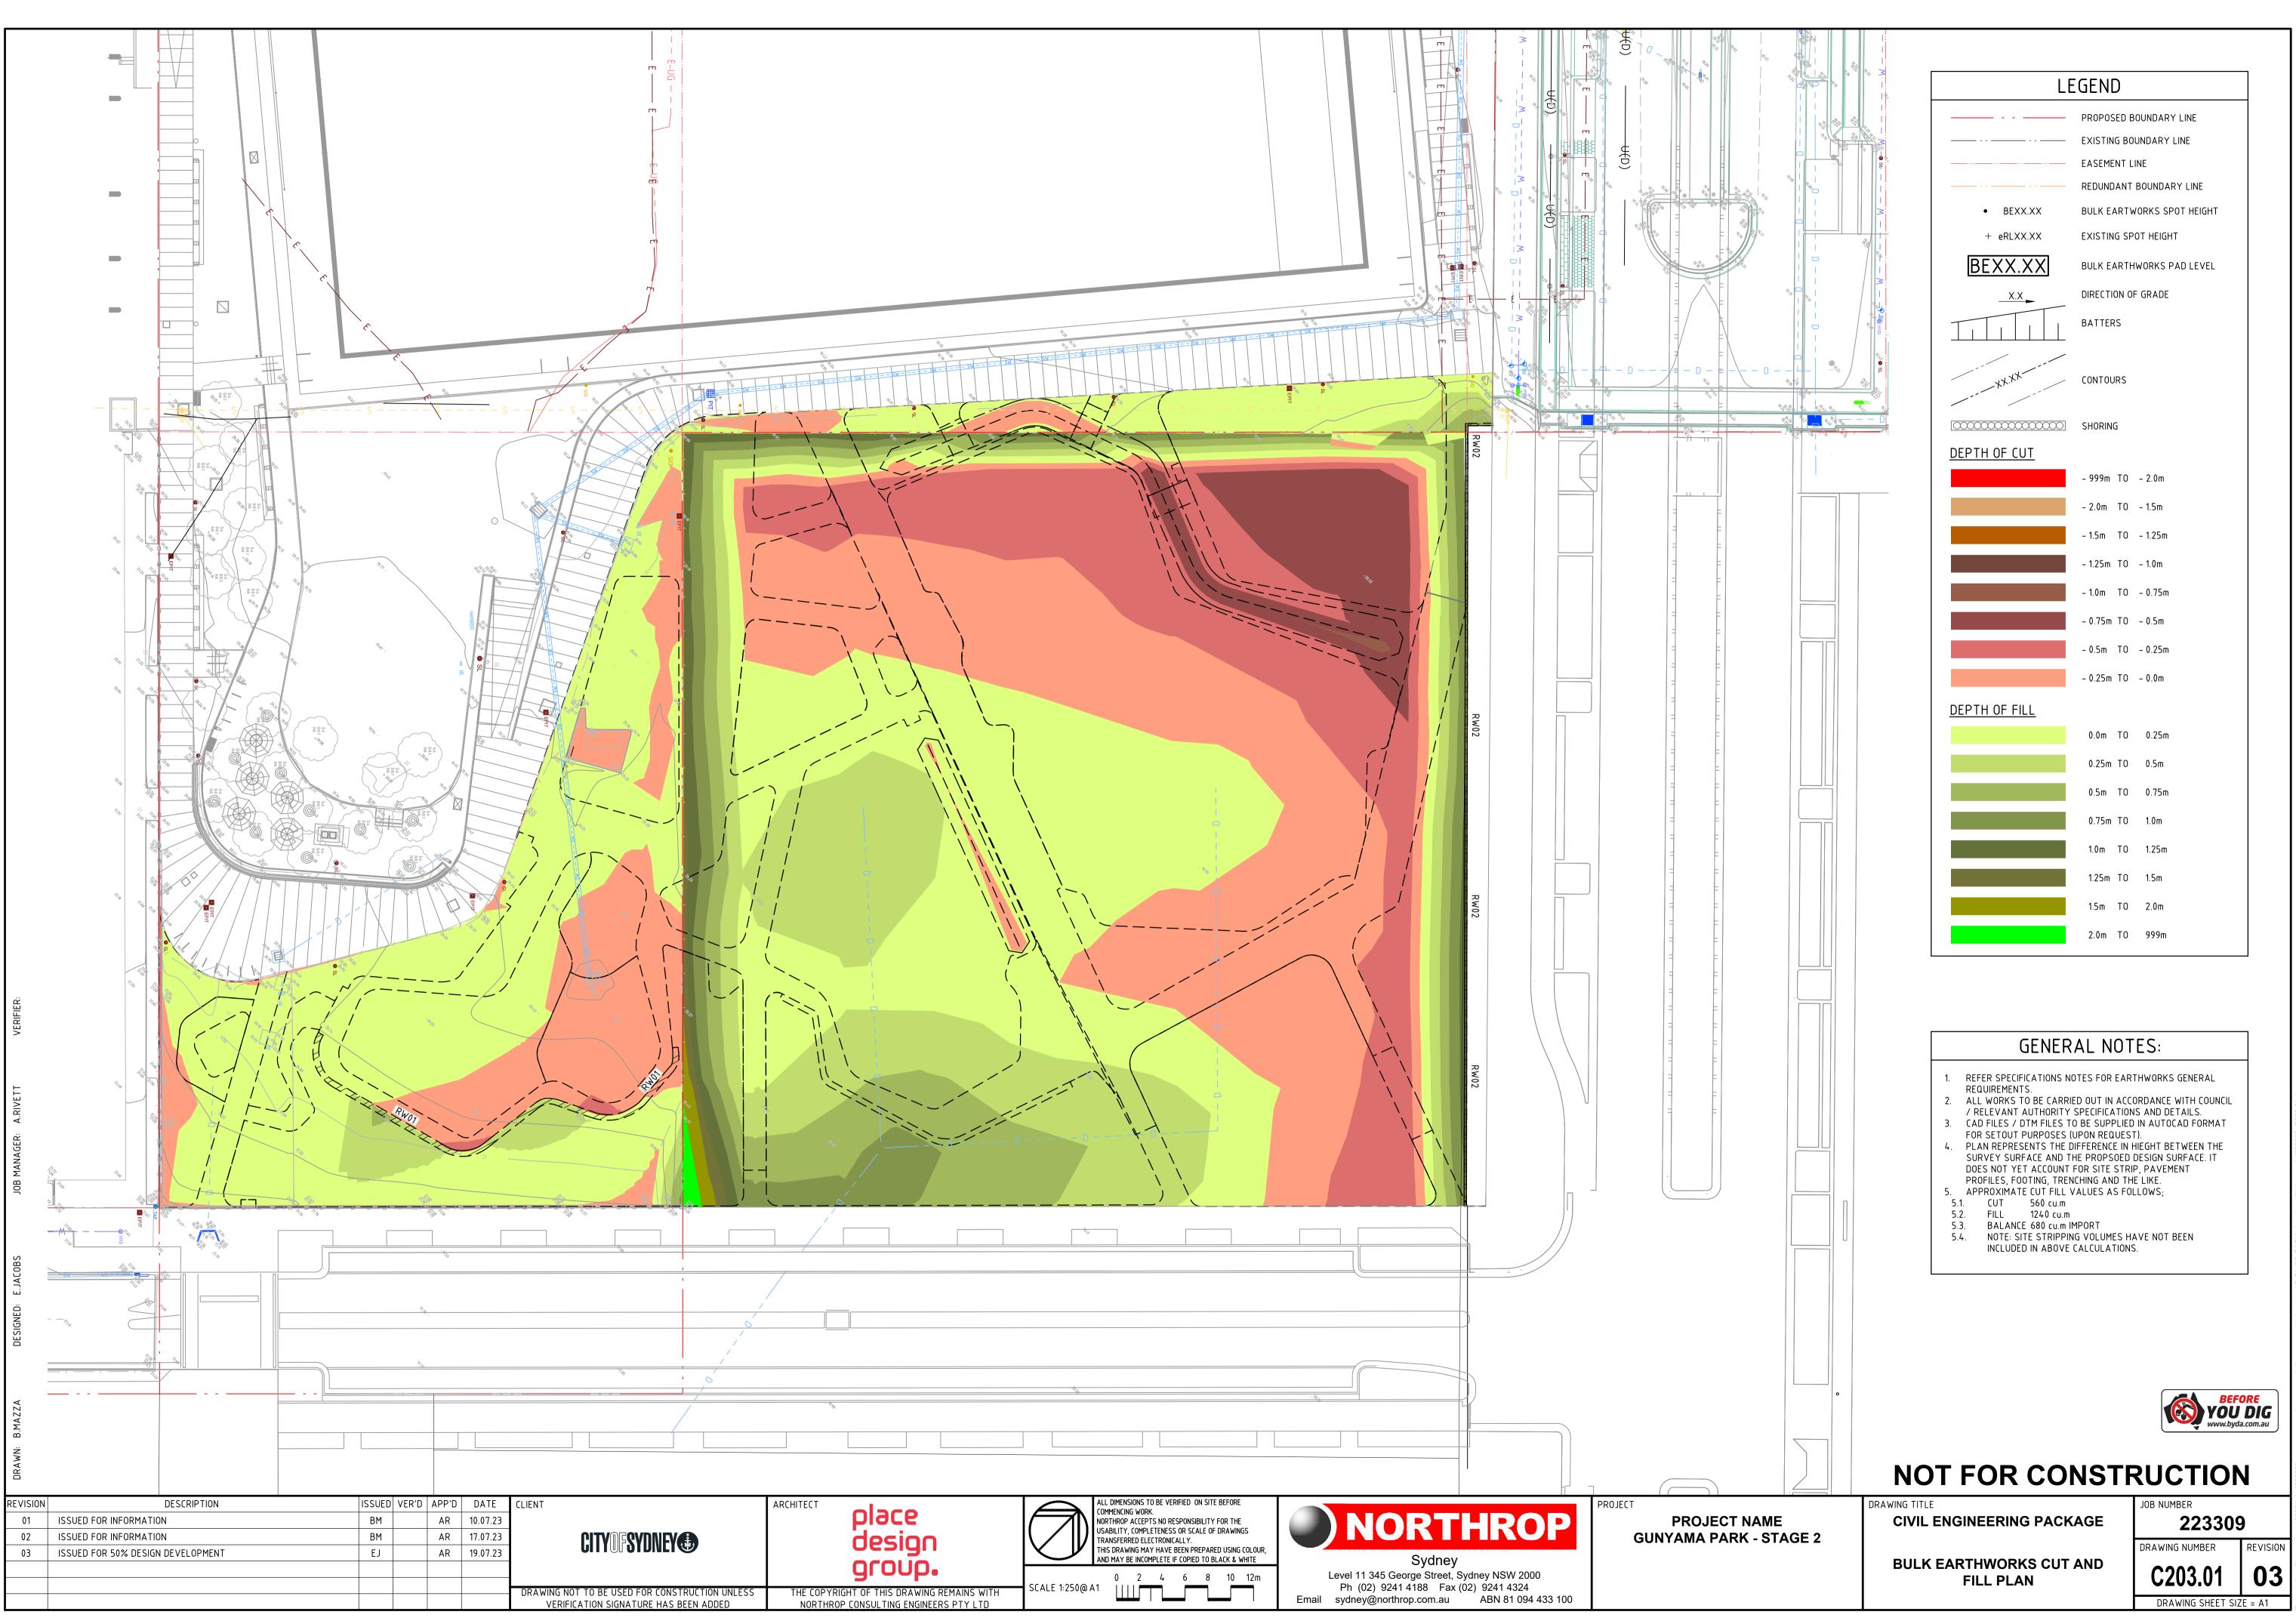

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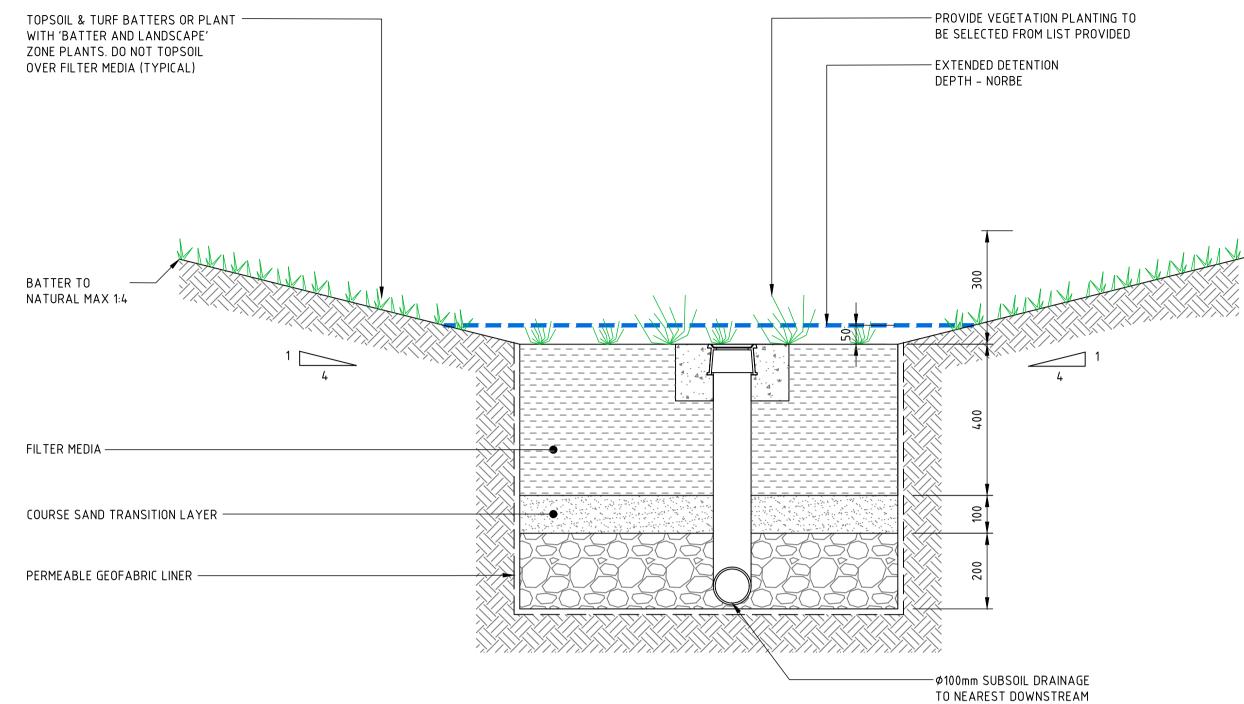
	A. -dr 006×006	ν0E-	Ard Brs. Grs. Page 900x000		900x900 G.S.I.P. SAG 5° LINE C: -58°
	GJA DRAINAGE CONNECTION				
VERIFIER:	PIPE CLASS PIPE GRADE (%) PIPE SIZE (mm) MINIMUM COVER (m)	RR J2 1.0% 525 1.07	><	RR J2 1.0% 525 1.03	
A.RIVETT	FINISHED SURFACE		20.258 20.074		20.272 19.582
JOB MAI	378 	18.34.8	18.129 18.099		17.767 20 17.767 20
_		1.628 18	1.945 18 1.975 18		1.785 17 1.815 17
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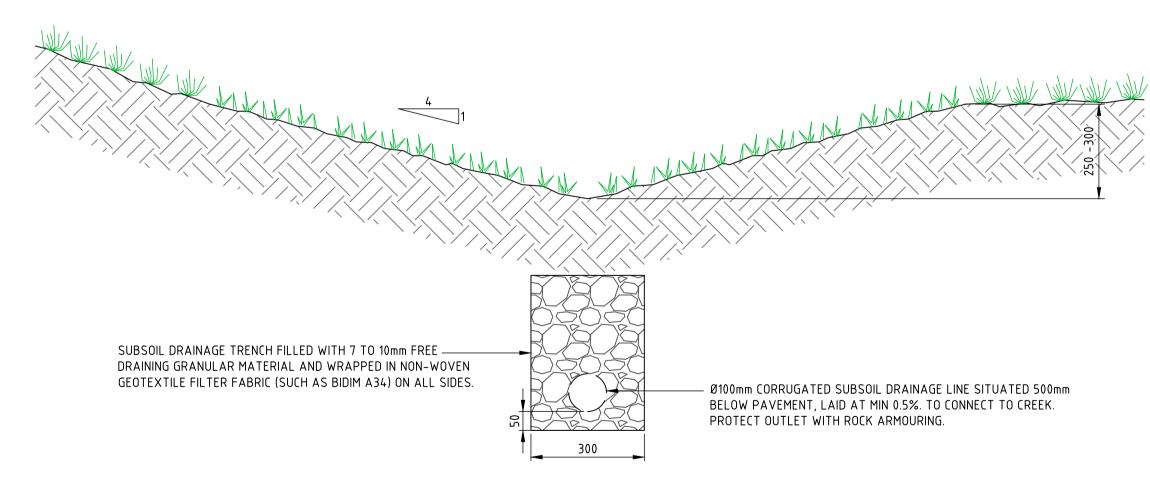

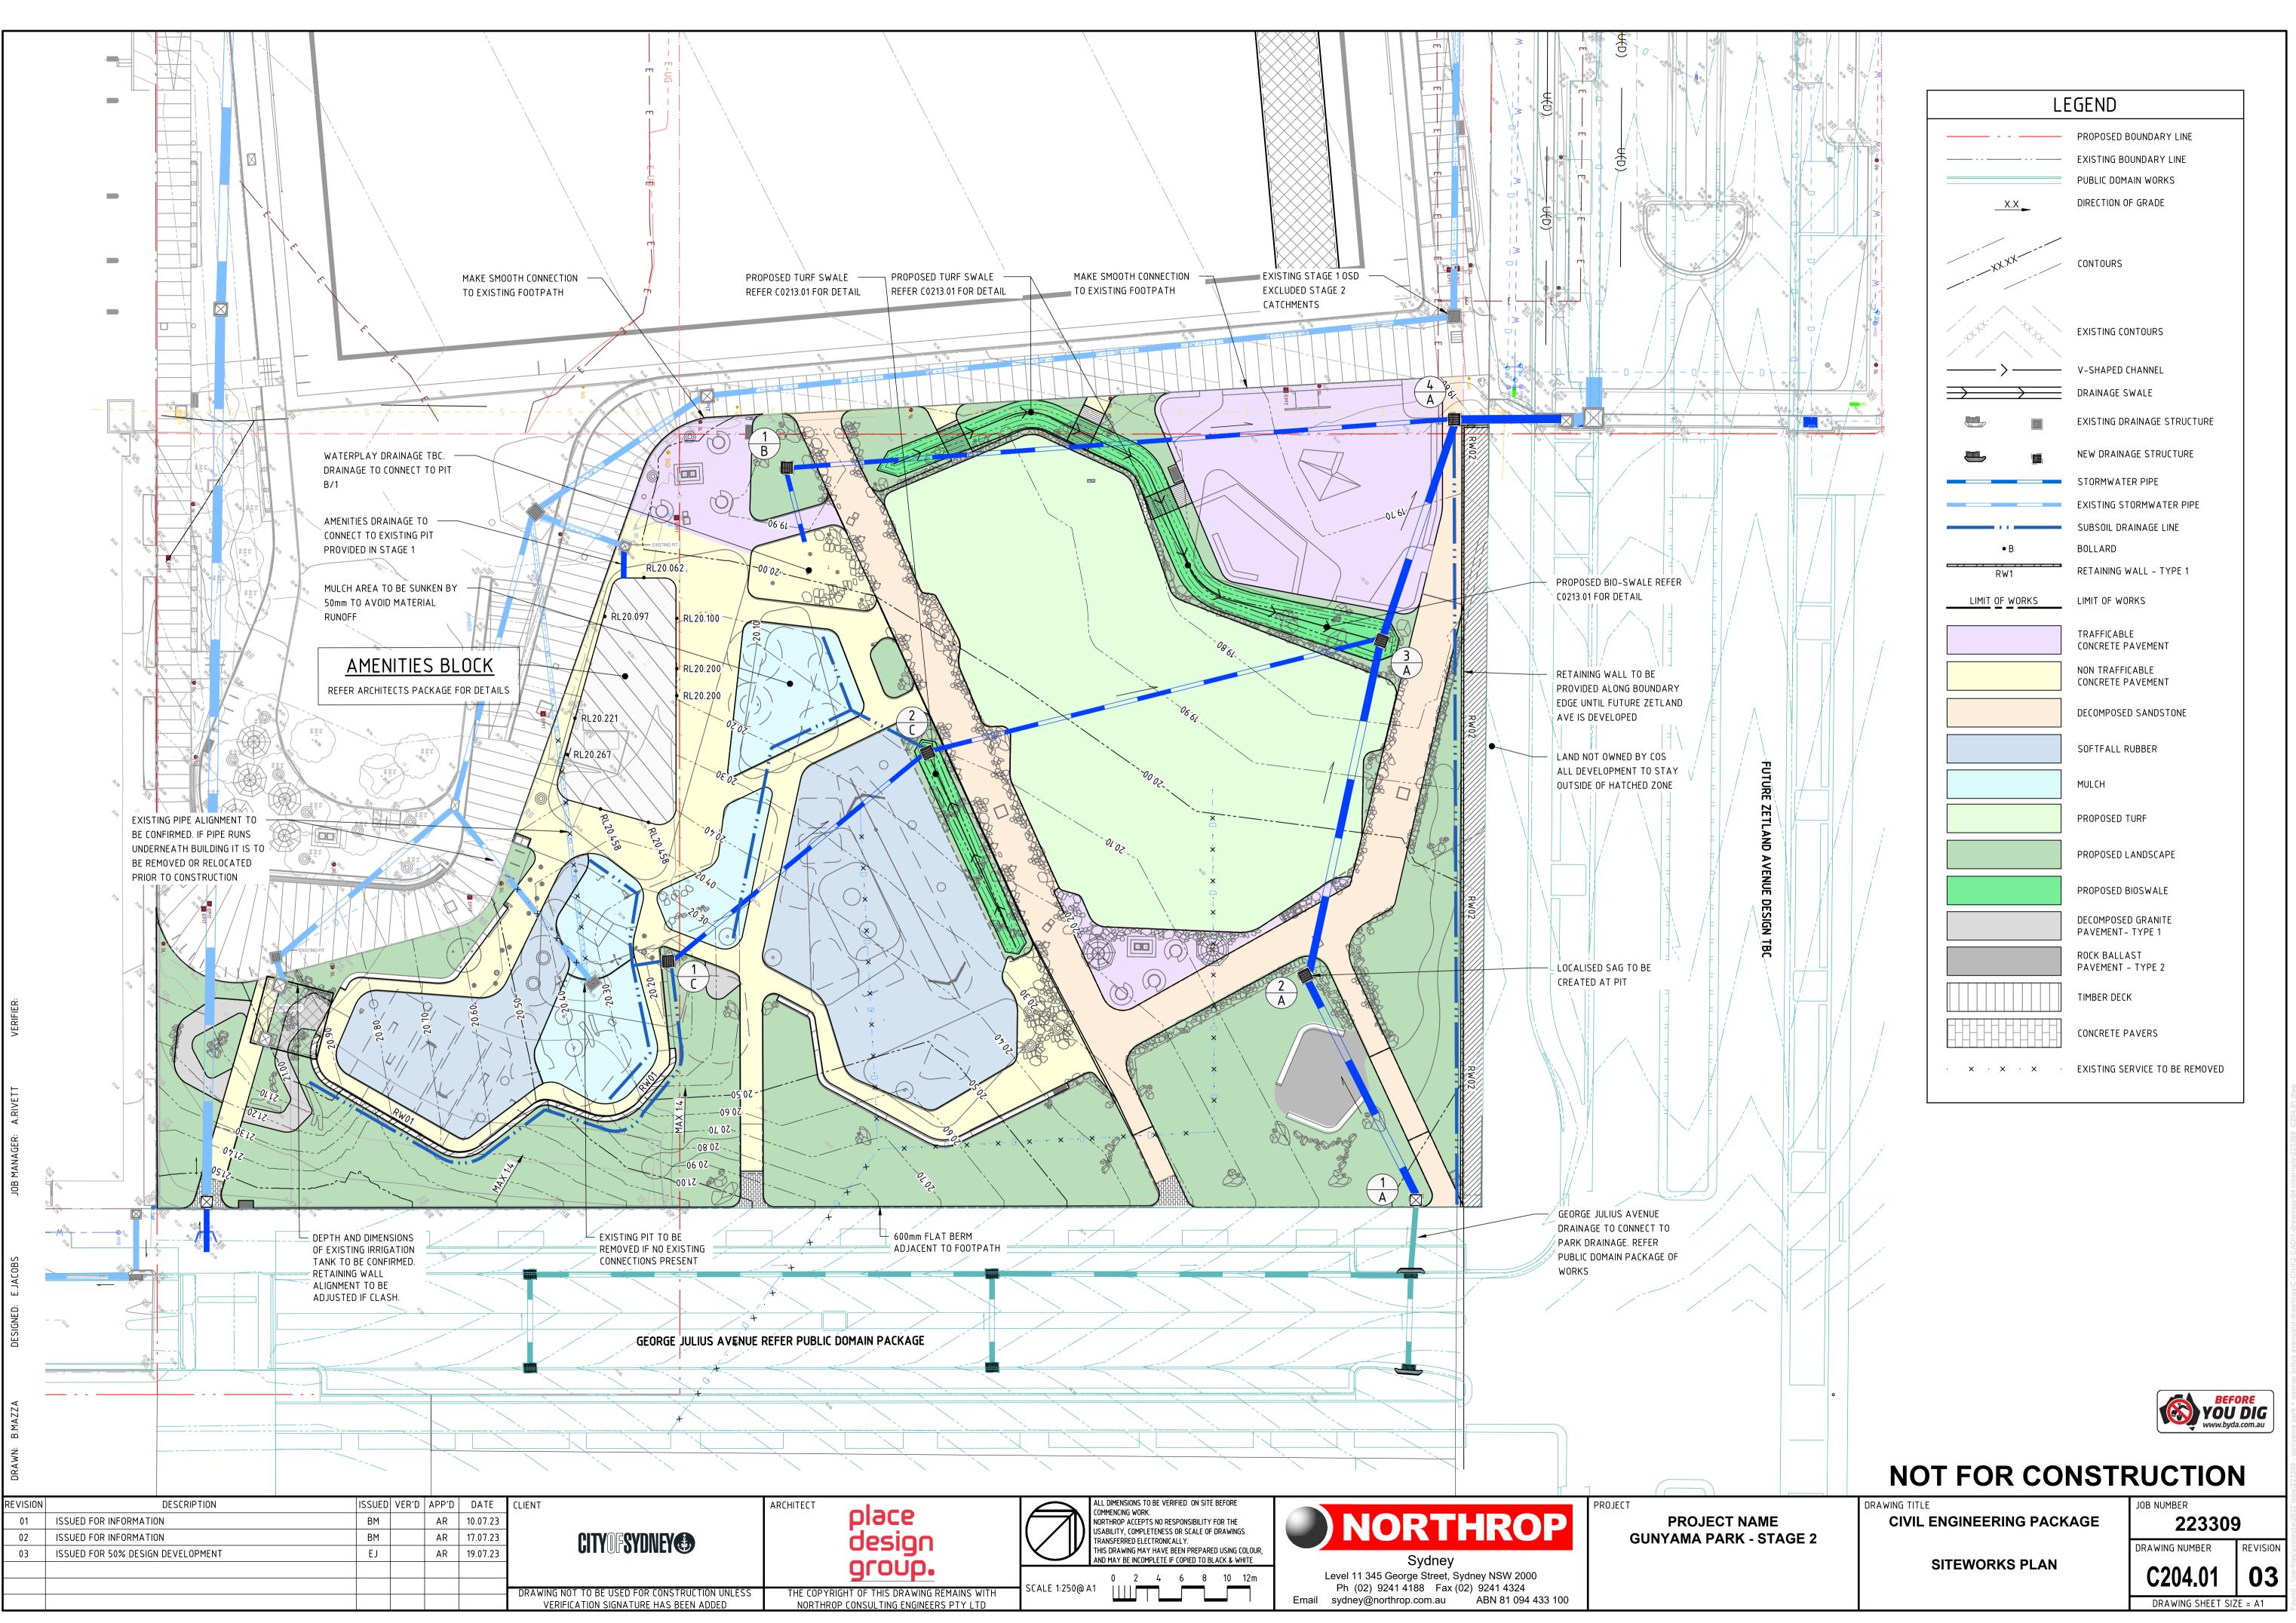
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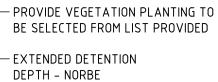


TYPICAL BIORETENTION SWALE DETAIL

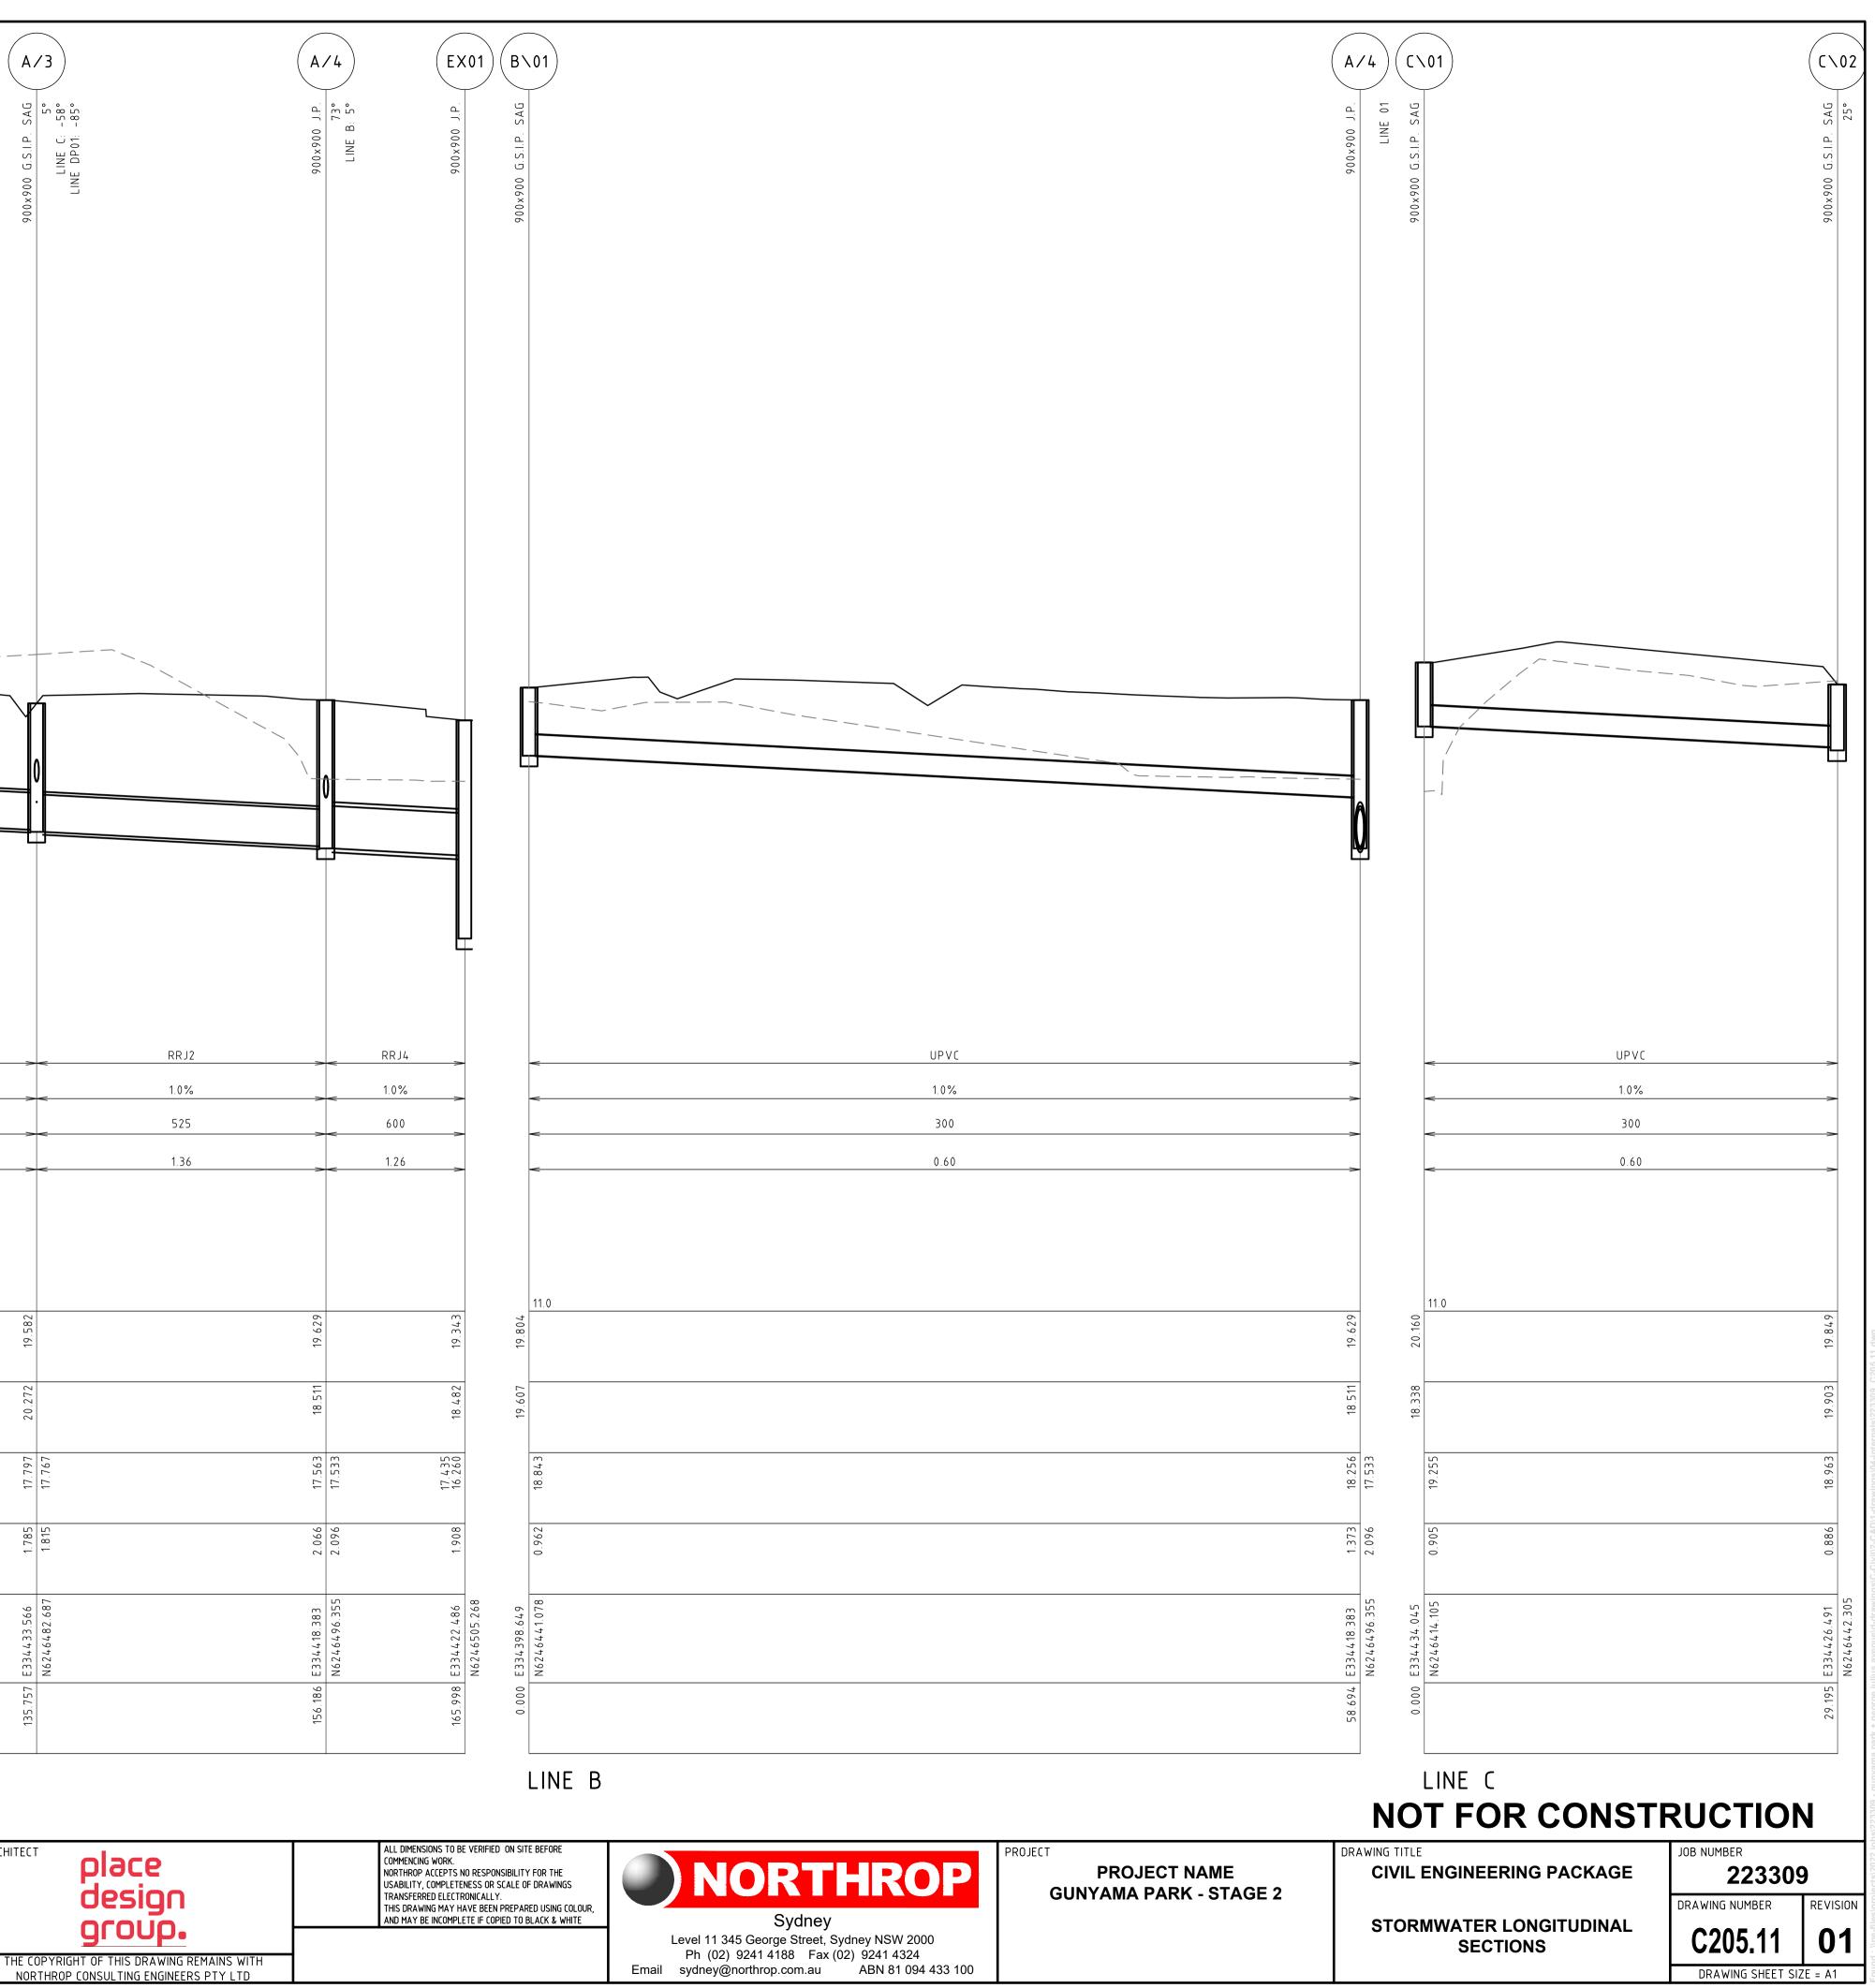

TYPICAL GRASS SWALE

REVISION	DESCRIPTION	ISSUE	VER'D	APP'D	DATE	CLIENT	ARCHITECT
01	ISSUED FOR INFORMATION	BM		AR	10.07.23		
02	ISSUED FOR INFORMATION	BM		AR	17.07.23	CITYOFSYDNEY	
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PIT



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PROJECT **PROJECT NAME GUNYAMA PARK - STAGE 2**

NOT FOR CONSTRUCTION DRAWING TITLE

CIVIL ENGINEERING PACKAGE

DETAILS

DRAWING NUMBER C213.01 DRAWING SHEET SIZE = A1

JOB NUMBER

223309

REVISION

03

GEORGE JULIUS AVENUE

HYDRAULIC SERVICES



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place design	ALL SETOUT TO ARCHITECT'S DRAWINGS. DIMENSIONS TO BE VERIFIED WITH ARCHITECT AND BUILDER BEFORE COMMENCING SHOP DRAWINGS OR SITE WORK. NORTHROP ACCEPTS NO RESPONSIBILITY FOR THE USABILITY, COMPLETENESS OR SCALE OF DRAWINGS TRANSFERRED ELECTRONICALLY.	NORTHROP Sydney	PROJECT GUNYAMA PARK	HYDRAULIC SERVICES	JOB NUMBER SY223309 DRAWING NUMBER REVISION
THIS DRAWING REMAINS WITH NORTHROP	1:250 @A1	Level 11, 345 George St, Sydney NSW 2000 T (02) 9241 4188 P.O. Box H171 Australia Square, NSW 1215 Email sydney@northrop.com.au ABN 81 094 433 100		COVER PAGE	HY-00 1 DRAWING SHEET SIZE = A1



HYDRAULIC SERVICES DRAWING LIST

DRAWING No. DRAWING TITLE

HY-00	COVERSHEET AND DRAWING SCHEDULE
HY-01	LEGEND OF SYMBOLS AND NOTES
HY-02	SITE PLAN – HYDRAULIC SERVICES
HY-03	GROUND FLOOR – DRAINAGE SERVICES
HY-04	GROUND FLOOR – PRESSURE SERVICES

NOT FOR CONSTRUCTION

	GENERAL
1.	ALL WORK SHALL BE CARRIED OUT IN ACCORDANCE WITH RELEVANT AUTHORITY REQUIREMENTS, NETWORK UTILITY POLICIES AND SPECIFICATIONS, SUPERINTENDENTS APPROVAL, HYDRAULIC SPECIFICATION AND AUSTRALIAN STANDARDS AS/NZS 3500, AS 5601, AS 1221, AS 2441 AND AS 2419.1.
2.	THIS PLAN SHALL BE READ IN CONJUNCTION WITH THE APPROVED ARCHITECTURAL, LANDSCAPE, STRUCTURAL, MECHANICAL AND ELECTRICAL PLANS AND SPECIFICATIONS.
3.	DRAINS TO BE SUPPORTED ON OR FROM SOLID GROUND. LOCATION AND DEPTH/INVERT OF BRANCH SHALL BE VERIFIED ON SITE PRIOR TO COMMENCEMENT OF WORK.
4.	DRAINS UNDER BUILDING SHALL BE RE-TESTED WHERE DIRECTED BY THE SUPERINTENDENT.
5.	 INSPECTION OPENINGS SHALL BE PROVIDED IN ACCORDANCE WITH AS/NZS 3500.2, SECTION 4.7 AND THE FOLLOWING: 5.1. OUTSIDE OF A BUILDING, NO FURTHER THAN 2.5m, ALONG EACH BRANCH DRAIN CONNECTING ONE OR MORE WATER CLOSETS OR SLOP HOPPERS; 5.2. AT INTERVALS OF NOT MORE THAN 30m, WITH A MINIMUM OF ONE INSPECTION OPENING
	 S.E. AT INTERVALS OF NOT HORE THAN SOM, WITH A HIGH OF OR EACH OF EARLY DECISION OF EARLY OF
б.	EXISTING SERVICES HAVE BEEN PLOTTED FROM SUPPLIED DATA. NORTHROP CONSULTING ENGINEERS PTY LTD DOES NOT GUARANTEE THEIR ACCURACY AND IT IS THE THE CONTRACTORS RESPONSIBILITY TO ESTABLISH THE LOCATION OF ALL EXISTING SERVICES PRIOR TO THE COMMENCEMENT OF ANY WORK. ALL CLEARANCES SHALL BE OBTAINED FROM THE RELEVANT AUTHORITY.
7.	THE CONTRACTOR SHALL ARRANGE ALL SURVEY SETOUTS BY A REGISTERED SURVEYOR.
8.	ALL SERVICES THAT CROSS FOOT PATHS, FOOTINGS ETC. SHALL BE BACKFILLED WITH APPROVED GRANULAR MATERIAL TO SUBGRADE LEVEL AND COMPACTED TO 100% STANDARD MAXIMUM DRY DENSITY IN ACCORDANCE WITH AS 1289.E1.1.
9.	ON COMPLETION OF PIPE INSTALLATION, ALL DISTURBED AREAS MUST BE RESTORED TO ORIGINAL CONDITION INCLUDING KERBS, FOOTPATHS, CONCRETE AREAS, GRAVEL AREAS, GRASSED AREAS AND ROAD PAVEMENTS.
10.	TRENCHES THROUGH EXISTING ROAD AND CONCRETE AREAS SHALL BE SAWCUT TO FULL DEPTH OF CONCRETE AND A MINIMUM OF 50mm IN BITUMINOUS PAVING. REINSTATE TO EQUIVALENT OF ORIGINAL ROAD AND CONCRETE AREA.
11.	WHERE NEW WORK ABUTS EXISTING, THE CONTRACTOR SHALL ENSURE THAT A SMOOTH, EVEN PROFILE, FREE FROM ABRUPT CHANGES, IS OBTAINED.
12.	CARE SHALL BE TAKEN WHEN EXCAVATING NEAR EXISTING SERVICES. NO MECHANICAL EXCAVATION SHALL BE TAKEN OVER TELSTRA OR ELECTRICAL SERVICES. EXCAVATE BY HAND IN THESE AREAS.
13.	ALL CORE HOLE LOCATIONS SHALL BE APPROVED BY THE SUPERINTENDENT PRIOR TO COMMENCEMENT OF CORING.
14.	CONTRACTOR SHALL ALLOW FOR ALL TIMBERING, SHORING AND SHUTTERING AS NECESSAR TO CONSTRUCT PIPEWORK AND INCLUDE THE REMOVAL OF SAME UPON COMPLETION OF PIPEWORK.
15.	ALL PVC-U PIPE EXPOSED TO SUNLIGHT SHALL BE DWV.
16.	THE CONTRACTOR IS TO LOCATE AND CONFIRM LEVELS OF ALL EXISTING SERVICE CONNECTIONS PRIOR TO COMMENCING WORK. NOTIFY THE SUPERINTENDENT IMMEDIATELY IF ANY DIFFERENCES IN POSITION AND LEVEL ARE FOUND.
17.	THE CONTRACTOR MUST VISIT THE SITE OF WORKS BEFORE TENDERING AND ALLOWANCES ON THEIR TENDER FOR ALL TOPOGRAPHICAL CONSTRAINTS AFFECTING THE EXECUTION OF THE WORKS AND THE RESTORATION OF THE SITE.
18.	THE CONTRACTOR MUST SECURE ALL PERMITS, ARRANGE ALL CLEARANCES AND PAY ALL FEES REQUIRED TO COMPLETE THE PROJECT BEFORE COMMENCING WORK.
19.	ANY NON-METALLIC INGROUND WATER SERVICE IS TO BE INSTALLED WITH TRACE WIRE AND TESTED.
20.	THESE DRAWING SHALL NOT BE COPIED OR AMENDED WITHOUT THE WRITTEN CONSENT FROM NORTHROP CONSULTING ENGINEERS PTY LTD.
21.	THE CONTRACTOR IS TO ALLOW FOR THE PROCUREMENT AND INSTALLATION OF ALL APPLICABLE SIGNAGE FOR THE HYDRAULIC AND WET FIRE SERVICES IN ACCORDANCE WITH THE REQUIREMENTS OF LOCAL AUTHORITY HAVING JURISDICTION AND THE CURRENT EDITION OF THE FOLLOWING STANDARDS; • AS3500 • AS2419
	 AS2441 AS2118
	SAFETY IN DESIGN
WIT	S THIS PROJECT CONTAIN ANY ADDITIONAL RISKS/HAZZARDS NOT NORMALLY ASSOCIATED H THE TYPES OF WORKS DETAILED WITHIN THE HYDRAULIC DOCUMENTATION?
[X] []	YES – REFER TO THE FOLLOWING:
4	TREE PROTECTION
1. 2.	REFER TO LANDSCAPE / ARCHITECTS PLAN FOR TREES TO BE RETAINED AND PROTECTED. ANY EXISTING TREES WHICH FORM PART OF THE FINAL LANDSCAPING PLAN SHALL BE PROTECTED FROM CONSTRUCTION ACTIVITIES BY; 21 PROTECTING THEM WITH BADDIED FENCING OR SIMILAR MATERIALS INSTALLED.
	2.1. PROTECTING THEM WITH BARRIER FENCING OR SIMILAR MATERIALS INSTALLED OUTSIDE THE DRIP LINE.

- 2.2. ENSURING THAT NOTHING IS NAILED TO ANY PART OF THE TREE.
- 2.3. CARE IS TAKEN NOT TO CUT ROOTS UNNECESSARILY. COUNCILS AND/OR INDEPENDENT ARBORISTS TO BE CONSULTED WHERE TREE ROOTS ARE TO BE REMOVED AND/OR CUT.

SANITARY DRAINAGE/ PLUMBING

- REFER TO 'MATERIAL' SECTION OF THE HYDRAULIC SPECIFICATION FOR PIPE MATERIALS.
- 1. MATERIAL SCHEDULE:
- INGROUND SANITARY WASTE PIPES 65-150 PVC-U - INGROUND TRADE WASTE PIPES - 110 HDPE
- VENTS -50-100PVC-U
- UNLESS OTHERWISE NOTED, ALL INTERNAL EXPOSED PIPEWORK ADJACENT TO PLUMBING FIXTURES INCLUDING TRAP FITTINGS SHALL BE CHROME PLATED.
- 2. CONTRACTOR SHALL ALLOW FOR ADDITIONAL EXCAVATION (INCLUDING ROCK) AND BACKFILL OF PIPES. FITTINGS AND ALL JUMP-UPS TO THE LOCAL AUTHORITY REQUIREMENTS, INCLUDING THOSE TO BRANCH DRAINS.
- ALL BRANCH LINES SHALL BE GRADED AND/OR LOWERED TO AVOID PENETRATING FOOTING BEAMS UNLESS SHOWN OTHERWISE. THE CONTRACTOR SHALL ALLOW FOR ADDITIONAL PIPE LENGTHS AND WORK INCLUDING CONSTRUCTION OF ADDITIONAL INSPECTION OPENINGS AS REQUIRED BY THE LOCAL AUTHORITY.
- 4. CO-ORDINATE WITH STRUCTURAL DRAWINGS. NO STEEL REINFORCING BARS TO BE CUT WITHOUT PRIOR WRITTEN APPROVAL FROM STRUCTURAL ENGINEER.
- 5. ORG GRATE LEVEL SHALL BE IN ACCORDANCE WITH AS/NZS 3500.2 CLAUSE 4.6.6.6 AND 4.6.6.7.
- 6. NEW DRAINS TO BE CONSTRUCTED ARE SHOWN IN BLUE LINES. EXISTING DRAINS ARE SHOWN IN GREEN LINES. EXISTING AUTHORITY MAINS ARE SHOWN IN RED.
- 7. EXISTING DRAINS SHOWN 'X'ed' IN RED ARE TO BE EXHUMED OR ABANDONED (AS NOTED) AND ENDS SHALL BE SEALED TO APPROVAL.
- 8. ALL VENT PIPES SHALL BE INSTALLED WITHIN EXTERNAL WALL CAVITIES OR INTERNAL STUD WALLS.
- 9. ALL CLEAROUTS SHALL BE RAISED TO FINISHED FLOOR LEVEL AND PROVIDED WITH A SCREWED BRASS COVER.
- 10. CONTRACTOR TO ENSURE THAT ALL IN-WALL TRAPPED TUNDISHES ARE TO HAVE NON-REMOVEABLE TRAPS AND BE OF THE PERMANENT CONNECTION TYPE UNLESS OTHERWISE NOTED ON THE HYDRAULIC DESIGN DRAWINGS.
- 11. ALL ROOF PENETRATIONS TO DETAIL AND PAINTED COLOUR TO BE ADVISED. ALL VENTS SHALL BE OFFSET IN ROOF SPACE MINIMUM 600MM FROM EAVES AND AS SHOWN ON ARCHITECTURAL DRAWINGS. ALL VENTS TO TERMINATE 150mm ABOVE ROOF LEVEL.
- 12. EXPOSED INTERNAL PIPEWORK SHALL BE CHROME-PLATED.
- 13. ALL ROOF PENETRATIONS SHALL BE FLASHED WITH 'DEKTITE' FLASHING. COLOUR TO MATCH ROOF.

STORMWATER DRAINAGE

- . REFER TO 'MATERIAL' SECTION OF THE HYDRAULIC SPECIFICATION FOR PIPE MATERIALS.
- MINIMUM GRADE TO STORMWATER LINES TO BE 1% U.N.O.
- B. CONTRACTOR TO SUPPLY AND INSTALL ALL FITTINGS AND SPECIALS INCLUDING VARIOUS PIPE ADAPTERS TO ENSURE PROPER CONNECTION BETWEEN DISSIMILAR PIPEWORK.
- 4. ALL CONNECTIONS TO EXISTING DRAINAGE PITS SHALL BE MADE IN A TRADESMAN-LIKE MANNER AND THE INTERNAL WALL OF THE PIT AT THE POINT OF ENTRY SHALL BE CEMENT RENDERED TO ENSURE A SMOOTH FINISH.
- WHERE TRENCHES ARE IN ROCK, THE PIPE SHALL BE BEDDED ON A MINIMUM 50mm CONCRETE BED (OR 75MM THICK BED OF 12mm BLUE METAL) UNDER THE BARREL OF THE PIPE. THE PIPE COLLAR AT NO POINT SHALL BEAR ON THE ROCK. IN OTHER THAN ROCK, PIPES SHALL BE LAID ON A 75mm THICK SAND BED. IN ALL CASES BACKFILL THE TRENCH WITH SAND TO 200mm ABOVE THE PIPE, WHERE THE PIPE IS UNDER PAVEMENTS BACKFILL REMAINDER OF TRENCH WITH APPROVED GRANULAR MATERIAL TO SUBGRADE LEVEL IN 150mm LAYERS COMPACTED TO 100% STANDARD MAXIMUM DRY DENSITY. A MINIMUM PAVEMENT OF 125mm THICK DGB20 BASE AND 25mm THICK AC10 WEARING COURSE SHALL BE PROVIDED.
- WHERE STORMWATER LINES PASS UNDER FLOOR SLABS, SEWER GRADE PIPEWORK IS TO BE USED. FLEXIBLE JOINTS, BEDDING AND BACKFILL SHALL BE IN ACCORDANCE WITH DETAILS.
- 7. EXPANSION JOINTS SHALL BE PROVIDED IN HDPE DRAINS WHERE THEY ENTER AND LEAVE PITS

WATER SERVICE

- . REFER TO 'MATERIAL' SECTION OF THE HYDRAULIC SPECIFICATION FOR PIPE MATERIALS.
- 1. MATERIAL SCHEDULE:
- COPPER TUBE TO AS 1432
- COPPER FITTINGS TO AS 1589
- CAPILLARY FITTINGS TO AS 3688. SILVER SOLDER JOINTS ONLY. - PE-X PIPEWORK COMPLYING WITH AS 2492 MAY BE USED AS INDICATED.
- PE-X PIPEWORK SHALL NOT BE LESS THAN CLASS 16 AS SPECIFIED IN AS/NZS 3500. JOINTING SHALL BE IN ACCORDANCE WITH AS 3688 AND THE METHOD SHALL BE AS PER MANUFACTURES INSTRUCTIONS.
- PE-X MUST NOT BE USED IN AREAS AS SPECIFIED IN AS/NZS 3500.
- ALL PIPEWORK SHALL BE INSTALLED IN ACCORDANCE WITH AS/NZS 3500.
- 3. ALL HOT WATER PIPEWORK SHALL BE INSULATED IN ACCORDANCE WITH AS/NZS 3500.
- ALL HOSE COCKS TO BE INSTALLED WITH A VACUUM BREAKER TO THE WATER AUTHORITIES' REQUIREMENTS.
- 5. COPPER TUBES SHALL BE USED FOR DOMESTIC WATER AND FIRE SERVICE AND SHALL COMPLY WITH AS 1432 TYPE 'B' TUBES.
- 6. NO CHASES ALLOWED UNLESS APPROVED IN WRITING BY SUPERINTENDENT.
- NO PIPE WORK SHALL RUN IN SOUND INSULATED WALLS UNLESS OTHER WISE SPECIFIED.
- WHERE PIPES ARE IN CONTACT WITH DISSIMILAR MATERIALS THEY ARE TO BE PROTECTED WITH BI-METAL CORROSION.
- 9. ANY STORED OR CIRCULATED HOT WATER IS TO BE AT NO LESS THAN 60°C.
- 10. ISOLATION VALVES AND THERMOSTATIC MIXING VALVES ARE TO BE LOCATED IN ACCORDANCE WITH AS/NZS 3500

REV	DESCRIPTION	ISSUED	VER'D	APP'D	DATE	CLIENT	ARCHITECT
1	PRELIMINARY ISSUE	E.B		G.L	18.07.23		- I F
						CITY OFSYDNEY	
						DRAWING NOT TO BE USED FOR CONSTRUCTION VERIFICATION SIGNATURE HAS BEEN ADD	

ROOF NOTES

- 1. CONTRACTOR SHALL ALLOW FOR ALL FLASHING AND WATERPROOFING IN ACCORDANCE WITH THE AUSTRALIAN STANDARD AND INSTALLED IN A WORKMANSHIP LIKE MANNER.
- 2. CONTRACTOR SHALL ALLOW TO INSTALL 100% EMERGENCY OVERFLOW MEASURES TO ATMOSPHERE IN ACCORDANCE WITH AS3500.
- 3. CONTRACTOR SHALL ALLOW FOR ADEQUATE FALL AT A MINIMUM OF 1 : 200 TO ALLOW COMPLIANT FALL TO THE SUMP.
- 4. CONTRACTOR SHALL ALLOW FOR ALL REQUIRED EXPANSION JOINTS AND ADJUST FOR THERMAL VARIATION ALL EXPANSION SPACE SHALL BE A MINIMUM OF 50mm.
- 5. CONTRACTOR SHALL ALLOW TO INSTALL GUTTER GUARDS AND, MESH SCREENS ON ALL GUTTERS, DOWNPIPES AND SUMPS THAT ARE WITHIN 2m OF VEGETATION.
- 6. CONTRACTOR TO PROVIDE A MAINTENANCE SCHEDULE FOR REGULAR CLEANING AND HOSE FLUSHING OF ALL DOWN PIPES AND GUTTERS.
- 7. CONTRACTOR TO PROVIDE A WATER TEST FOR ALL INTERNAL DOWNPIPES FOR 10 MINUTES AT 100mm OF HEAD WATER/ OR AIR TEST PRESSURE OF NOT LESS THAN 30kPA FOR A MINIMUM OF 3 MINUTES ALL IN ACCORDANCE WITH AS3500.

LINETYPES

PIPEWORK

	AUTHORITY SEWER	6 9	AUTHORITY SEWER	\bigotimes isolation valve in path box
	AUTHORITI SEWER		AUTHORITT SLWLR	₩ BALL VALVE
	SEWER DRAINAGE	5	SEWER DRAINAGE	₩ GATE VALVE
	SANITARY PLUMBING	88	SANITARY PLUMBING	⊯ GLOBE VALVE
	TRADEWASTE	8 9	TRADEWASTE	M BUTTERFLY VALVE
		<u> </u>		► NON RETURN VALVE
	STORMWATER DRAINAGE		STORMWATER DRAINAGE	DOUBLE VALVE
	SUBSOIL DRAINAGE	6 <u> </u>	SUBSOIL DRAINAGE	REDUCED PRESSURE ZONE DEVICE
	SANITARY VENT		SANITARY VENT	∽ REFLUX VALVE
	RAINWATER	8	RAINWATER	► FLAP VALVE
	KAIINWATER		KAINWATER	GAS ISOLATION VALVE
	RISING SEWER MAIN	88	RISING SEWER MAIN	GAS PRESSURE REGULATOR VALVE
	RISING STORMWATER MAIN	88	RISING STORMWATER MAIN	PRESSURE REDUCING VALVE
	COLD WATER SERVICES	6	COLD WATER SERVICES	RATIO REDUCTION VALVE
	COLD WATER SERVICES		COLD WATER SERVICES	PRESSURE LIMITING VALVE
	HOT WATER SERVICE	ss	HOT WATER SERVICE	PRESSURE RELIEF VALVE
	HOT WATER RETURN	SS	HOT WATER RETURN	BALANCING VALVE
	WARM WATER	5	WARM WATER	FLOAT VALVE
	WARM WATER		WARD WATER	MONITORED VALVE
	NON POTABLE WATER	83	NON POTABLE WATER	SOLENOID VALVE
	GAS SERVICE	6 3	GAS SERVICE	🛱 FLOW SENSOR
		9		😝 FLOW SWITCH
	FIRE HYDRANT SERVICE		FIRE HYDRANT SERVICE	PRESSURE SENSOR
	FIRE HOSE REEL SERVICE	8	FIRE HOSE REEL SERVICE	PRESSURE SWITCH
	FIRE SPRINKLER SERVICE	8 3	FIRE SPRINKLER SERVICE	TEMPERATURE SENSOR
	SYPHONIC	8 9	SYPHONIC	PRESSURE GAUGE
			STITIONIC	$\boldsymbol{\Phi}$ TEMPERATURE GAUGE
	TEST DRAIN	5	TEST DRAIN	
eWeW	EXISTING WATER MAIN			
eSeS	EXISTING SEWER MAIN			

place Jesign group.

LTING ENGINEERS PTY LTD

THIS DRAWING REMAINS WITH NORTHROP

-eSW

ALL SETOUT TO ARCHITECT'S DRAWINGS. DIMENSIONS TO BE VERIFIED WITH ARCHITECT AND BUILDER BEFORE COMMENCING SHOP DRAWINGS OR SITE WORK. NORTHROP ACCEPTS NO RESPONSIBILITY FOR THE USABILITY, COMPLETENESS OR SCALE OF DRAWINGS TRANSFERRED ELECTRONICALLY.

EXISTING STORMWATER MAIN

EXISTING GAS MAIN

1:250 @A1

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ROJECT

➡ ISOLATION VALVE

GUNYAMA PA

NOT FOR CONSTRUCTION

DRAWING TITLE

HYDRAULIC SERVICES

RK	

NOTES AND ANNOTATIONS

JOB NUMBER SY223309 DRAWING NUMBER REVISION **HY-01** DRAWING SHEET SIZE = A1

• wc	WATER CLOSET
• UR	URINAL
• _{td}	TUNDISH
• _{ttd}	TRAPPED TUNDISH
о _{sк}	SINK
■ ST	SILT TRAP
Ø _{SHR}	SHOWER
ØORG	OVERFLOW RELIEF GULLY
	LAUNDRY TAB
• 10	INSPECTION OPENING
Ø IPMF	INDUCT PIPE MICA FLAP
Ø _{FW}	FLOOR WASTE
Ø _{DT}	DISCONNECTOR GULLY
• co	CLEAROUT
• _{cs}	CLEANER'S SINK
	, BUCKET TRAP FLOOR WASTE
• _{bt}	BOUNDARY TRAP
• bth	BATH
ο _B	BASIN
	FLOW DIRECTION
O+ _{HT}	HOSE TAP RISE
3+ HT	HOSE TAP DROP TEE
3+ HT	HOSE TAP DROP
	WATER METER
GM	GAS METER
TV	TEMPERING VALVE
TMV	THERMOSTATIC MIXING VALVE
CH/BWU	CHILLED AND BOILING WATER UNIT
BWU	BOILING WATER UNIT
	DISH WASHER



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GRATED TRENCH DRAIN DOWNPIPE SPREADER RAINWATER OUTLET PLANTER OUTLET BALCONY OUTLET RAINWATER HEAD GRATED STORMWATER PIT CONCRETE INFILL STORMWATER PIT SEWER MANHOLE


STORMWATER MANHOLE

DRAWING CONTINUATION

750L GREASE ARRESTOR

DRAINAGE OUTLET SETOUT

BOX GUTTER

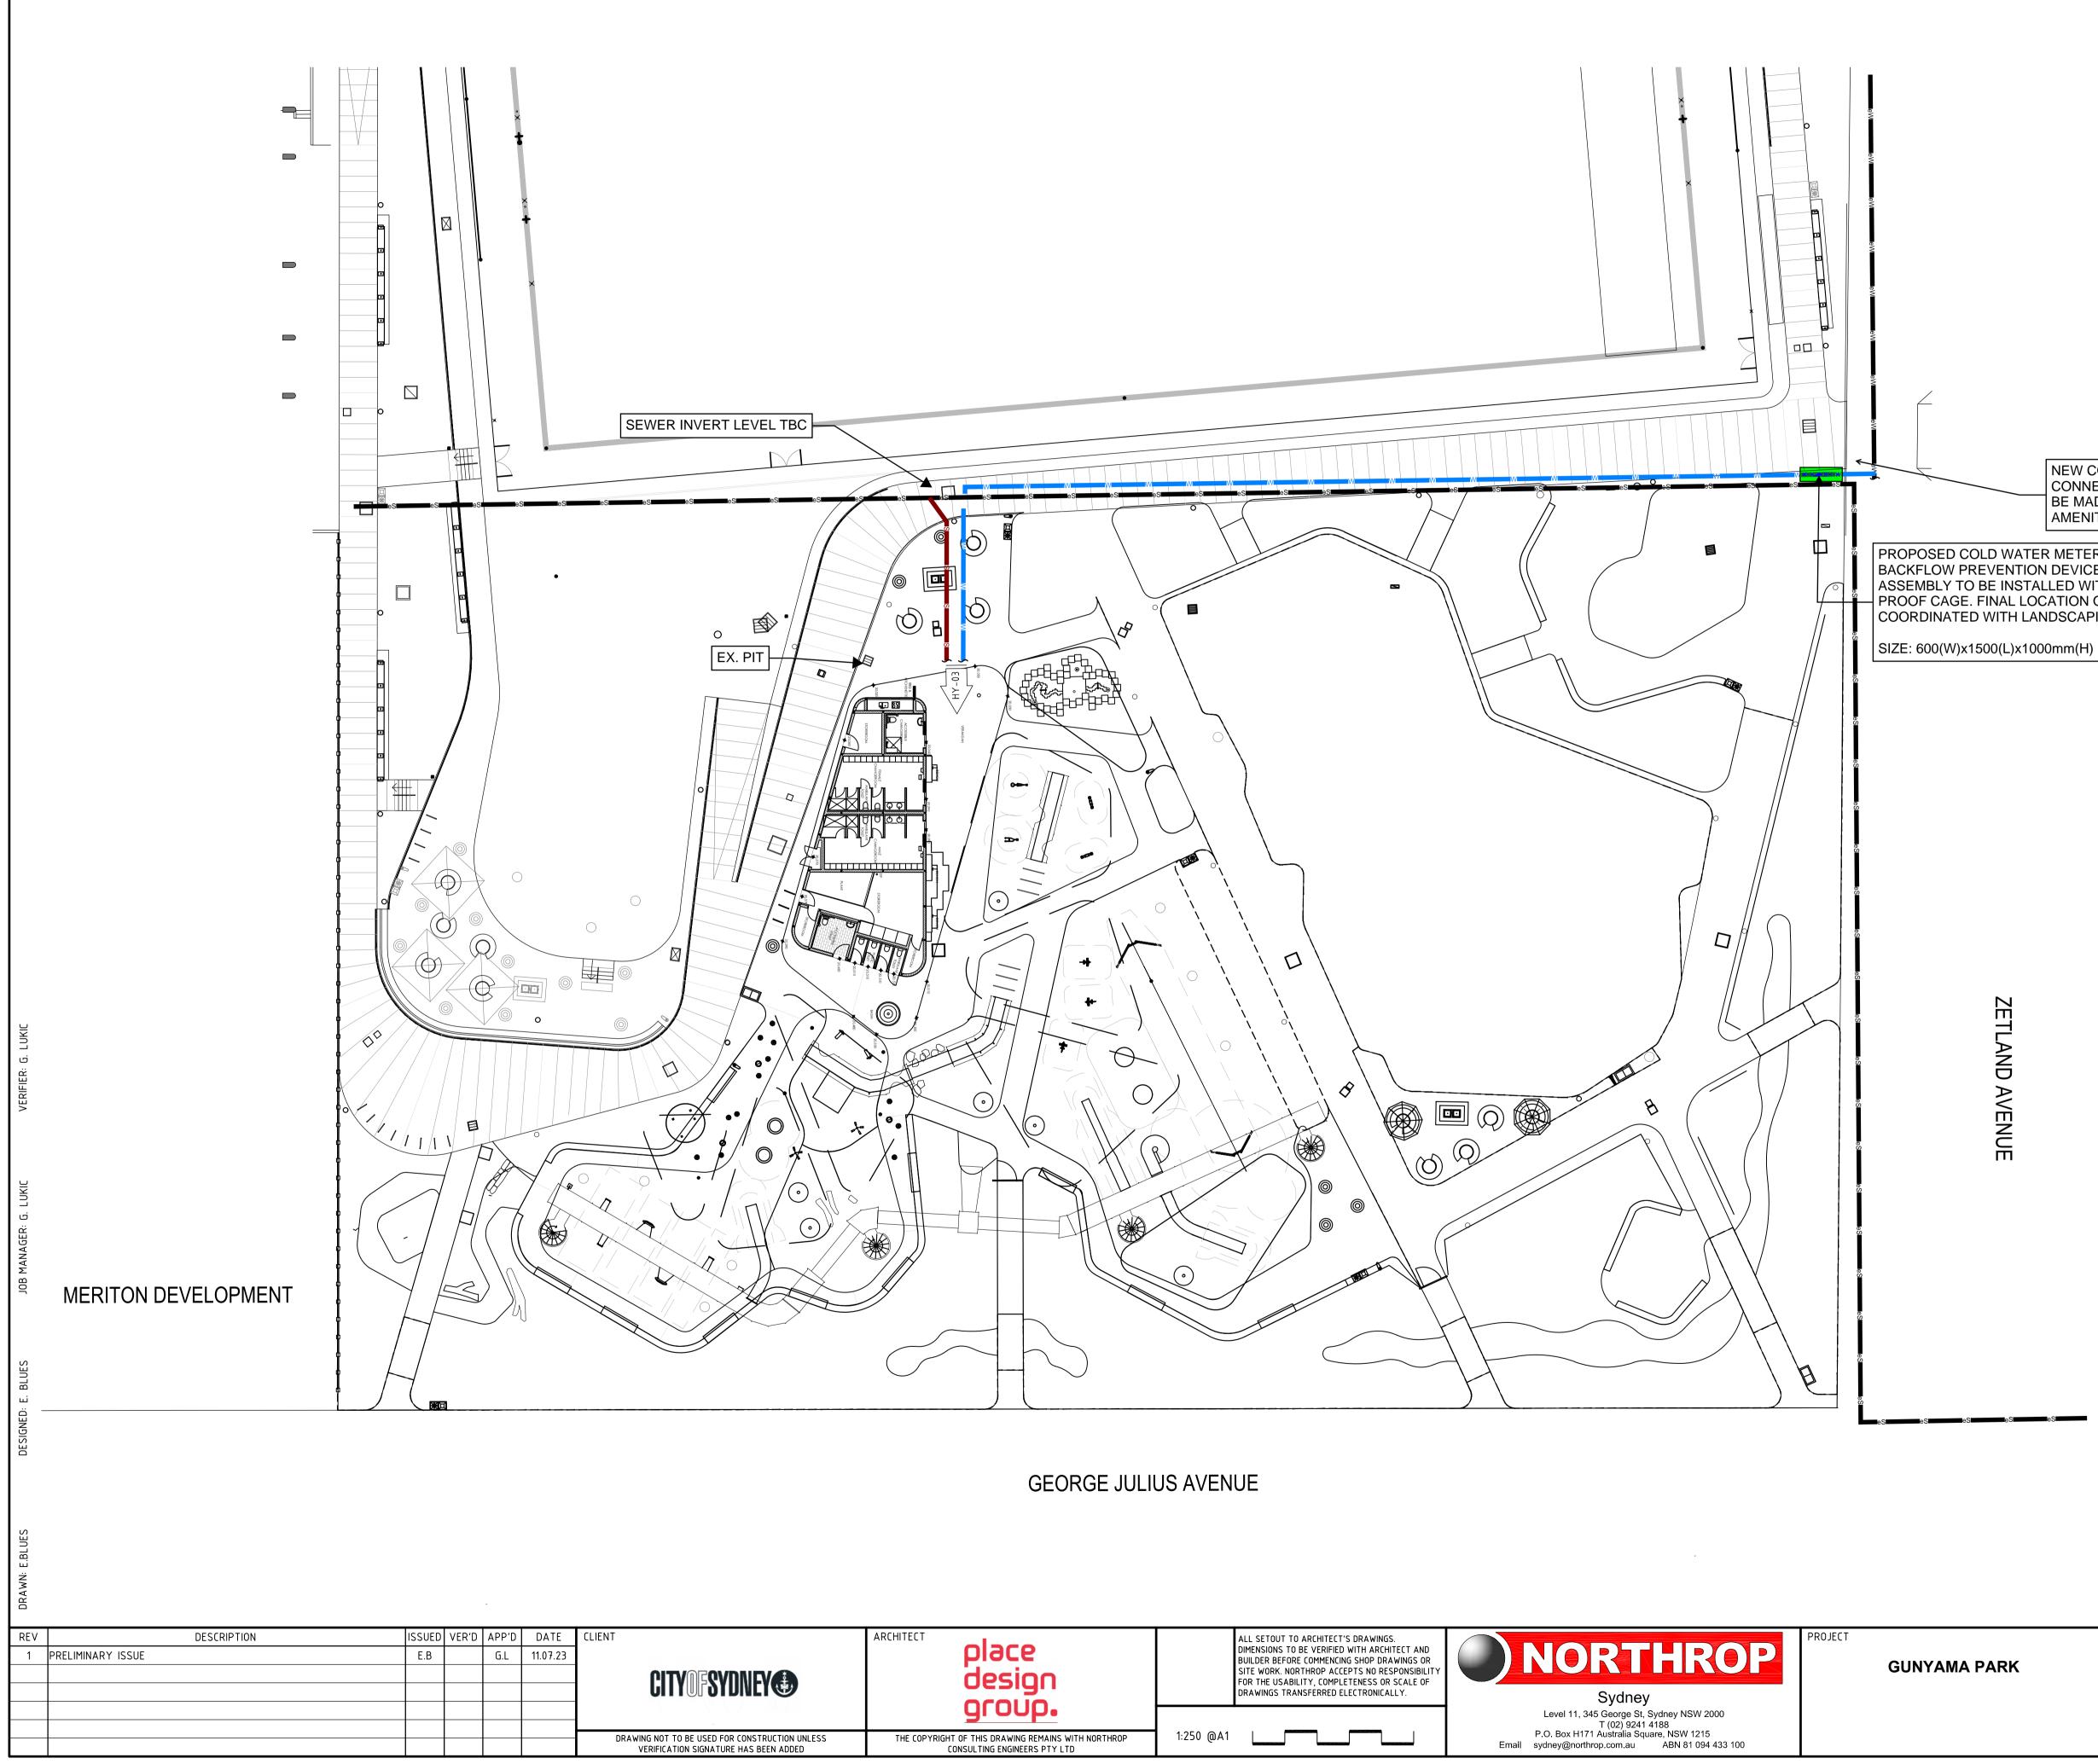

place design	DIMENSIONS TO BI BUILDER BEFORE SITE WORK. NORT	ARCHITECT'S DRAWINGS. E VERIFIED WITH ARCHITECT AND COMMENCING SHOP DRAWINGS OR THROP ACCEPTS NO RESPONSIBILITY TY, COMPLETENESS OR SCALE OF	NORTHROP	PROJECT GUNYAMA PARK	DRAWING TITLE HYDRAULIC SERVICES	JOB NUMBER	
group.	DRAWINGS TRANS	SFERRED ELECTRONICALLY.	Sydney Level 11, 345 George St, Sydney NSW 2000 T (02) 9241 4188		SITE PLAN	DRAWING NUMBER	REVISION 1
F THIS DRAWING REMAINS WITH NORTHROP SULTING ENGINEERS PTY LTD	1:250 @A1		P.O. Box H171 Australia Square, NSW 1215 Email sydney@northrop.com.au ABN 81 094 433 100			DRAWING SHEET SI	ZE = A1

		MATERIALS ARE TO COMPLY WITH ALL PARTS OF AS/NZS3500, AS5601, AS2419 AND AS2441 WHERE APPLICABLE.
	3.	EXISTING SERVICES HAVE BEEN PLOTTED FROM DATA SUPPLIED BY OTHER PARTIES. NORTHROP CONSULTING ENGINEERS DOES NOT GUARANTEE THE ACCURACY OF THIS INFORMATION. THE CONTRACTOR SHALL CONFIRM THE EXACT LOCATION AND DEPTH OF EXISTING SERVICES AND REPORT ANY DISCREPANCIES TO THE SUPERINTENDENT PRIOR TO THE COMMENCEMENT OF ANY WORKS.
	4.	ALL PROPOSED HYDRAULIC SERVICES INDICATED ON THIS DRAWING ARE DIAGRAMMATIC AND SHOW GENERAL ARRANGEMENT ONLY.
	5.	FLOORS, WALLS AND BEAMS SHALL BE CORED AND / OR SAW CUT AND RE-INSTATED IN A METHOD APPROVED BY THE STRUCTURAL ENGINEER. ALL PENETRATIONS TO BE SEALED WITH APPROVED FIRE RATED MATERIAL AND/OR FITTING WHERE REQUIRED TO MAINTAIN THE REQUIRED F.R.L. ALL FINAL CORE LOCATIONS ARE TO BE COORDINATED WITH THE STRUCTURAL ENGINEER PRIOR TO THE COMMENCEMENT OF ANY WORKS (TYPICAL).
NEW COLD WATER CONNECTIONS TO BE MADE FOR AMENITIES BLOCK	6.	REFER TO ARCHITECT'S DRAWINGS AND SPECIFICATION FOR SET-OUT AND COORDINATION OF HYDRAULIC POINTS WITH FIXTURES AS NOTED IN THE FIXTURE SCHEDULE.
R METER TO BE INSTALLED WITH N DEVICE. ALLOW FOR METER	7.	ALL PROPRIETARY ITEMS ARE TO BE INSTALLED IN ACCORDANCE WITH MANUFACTURER'S WRITTEN INSTRUCTIONS OR RECOMMENDATIONS. ANY

NOTE

LEGEND.

1. REFER TO H00.01 FOR GENERAL NOTES AND

2. ALL ELEMENTS OF THE INSTALLATION AND


ASSEMBLY TO BE INSTALLED WITHIN ANTI-VANDAL – PROOF CAGE. FINAL LOCATION OF WATER METER TO BE COORDINATED WITH LANDSCAPING PRODUCTS SPECIFIED OR USED ARE TO BE VERIFIED BY THE CONTRACTOR AS BEING SAFE AND APPROPRIATE FOR USE. NORTHROP DOES NOT TAKE ANY RESPONSIBILITY FOR THE PROVISION OF BANNED BUILDING PRODUCTS AS DEFINED BY NSW

> 8. COORDINATE ALL HYDRAULIC PIPEWORK WITH PROPOSED STRUCTURES AND SERVICES ON SITE PRIOR TO INSTALLATION

BUILDING PRODUCTS (SAFETY) ACT 2017.

9. ALL PLUMBING FIXTURES TO BE LOCATED IN AREAS THAT WILL REDUCE THE LIKELY HOOD OF TAMPERING AND VANDALISM.

NOT FOR CONSTRUCTION

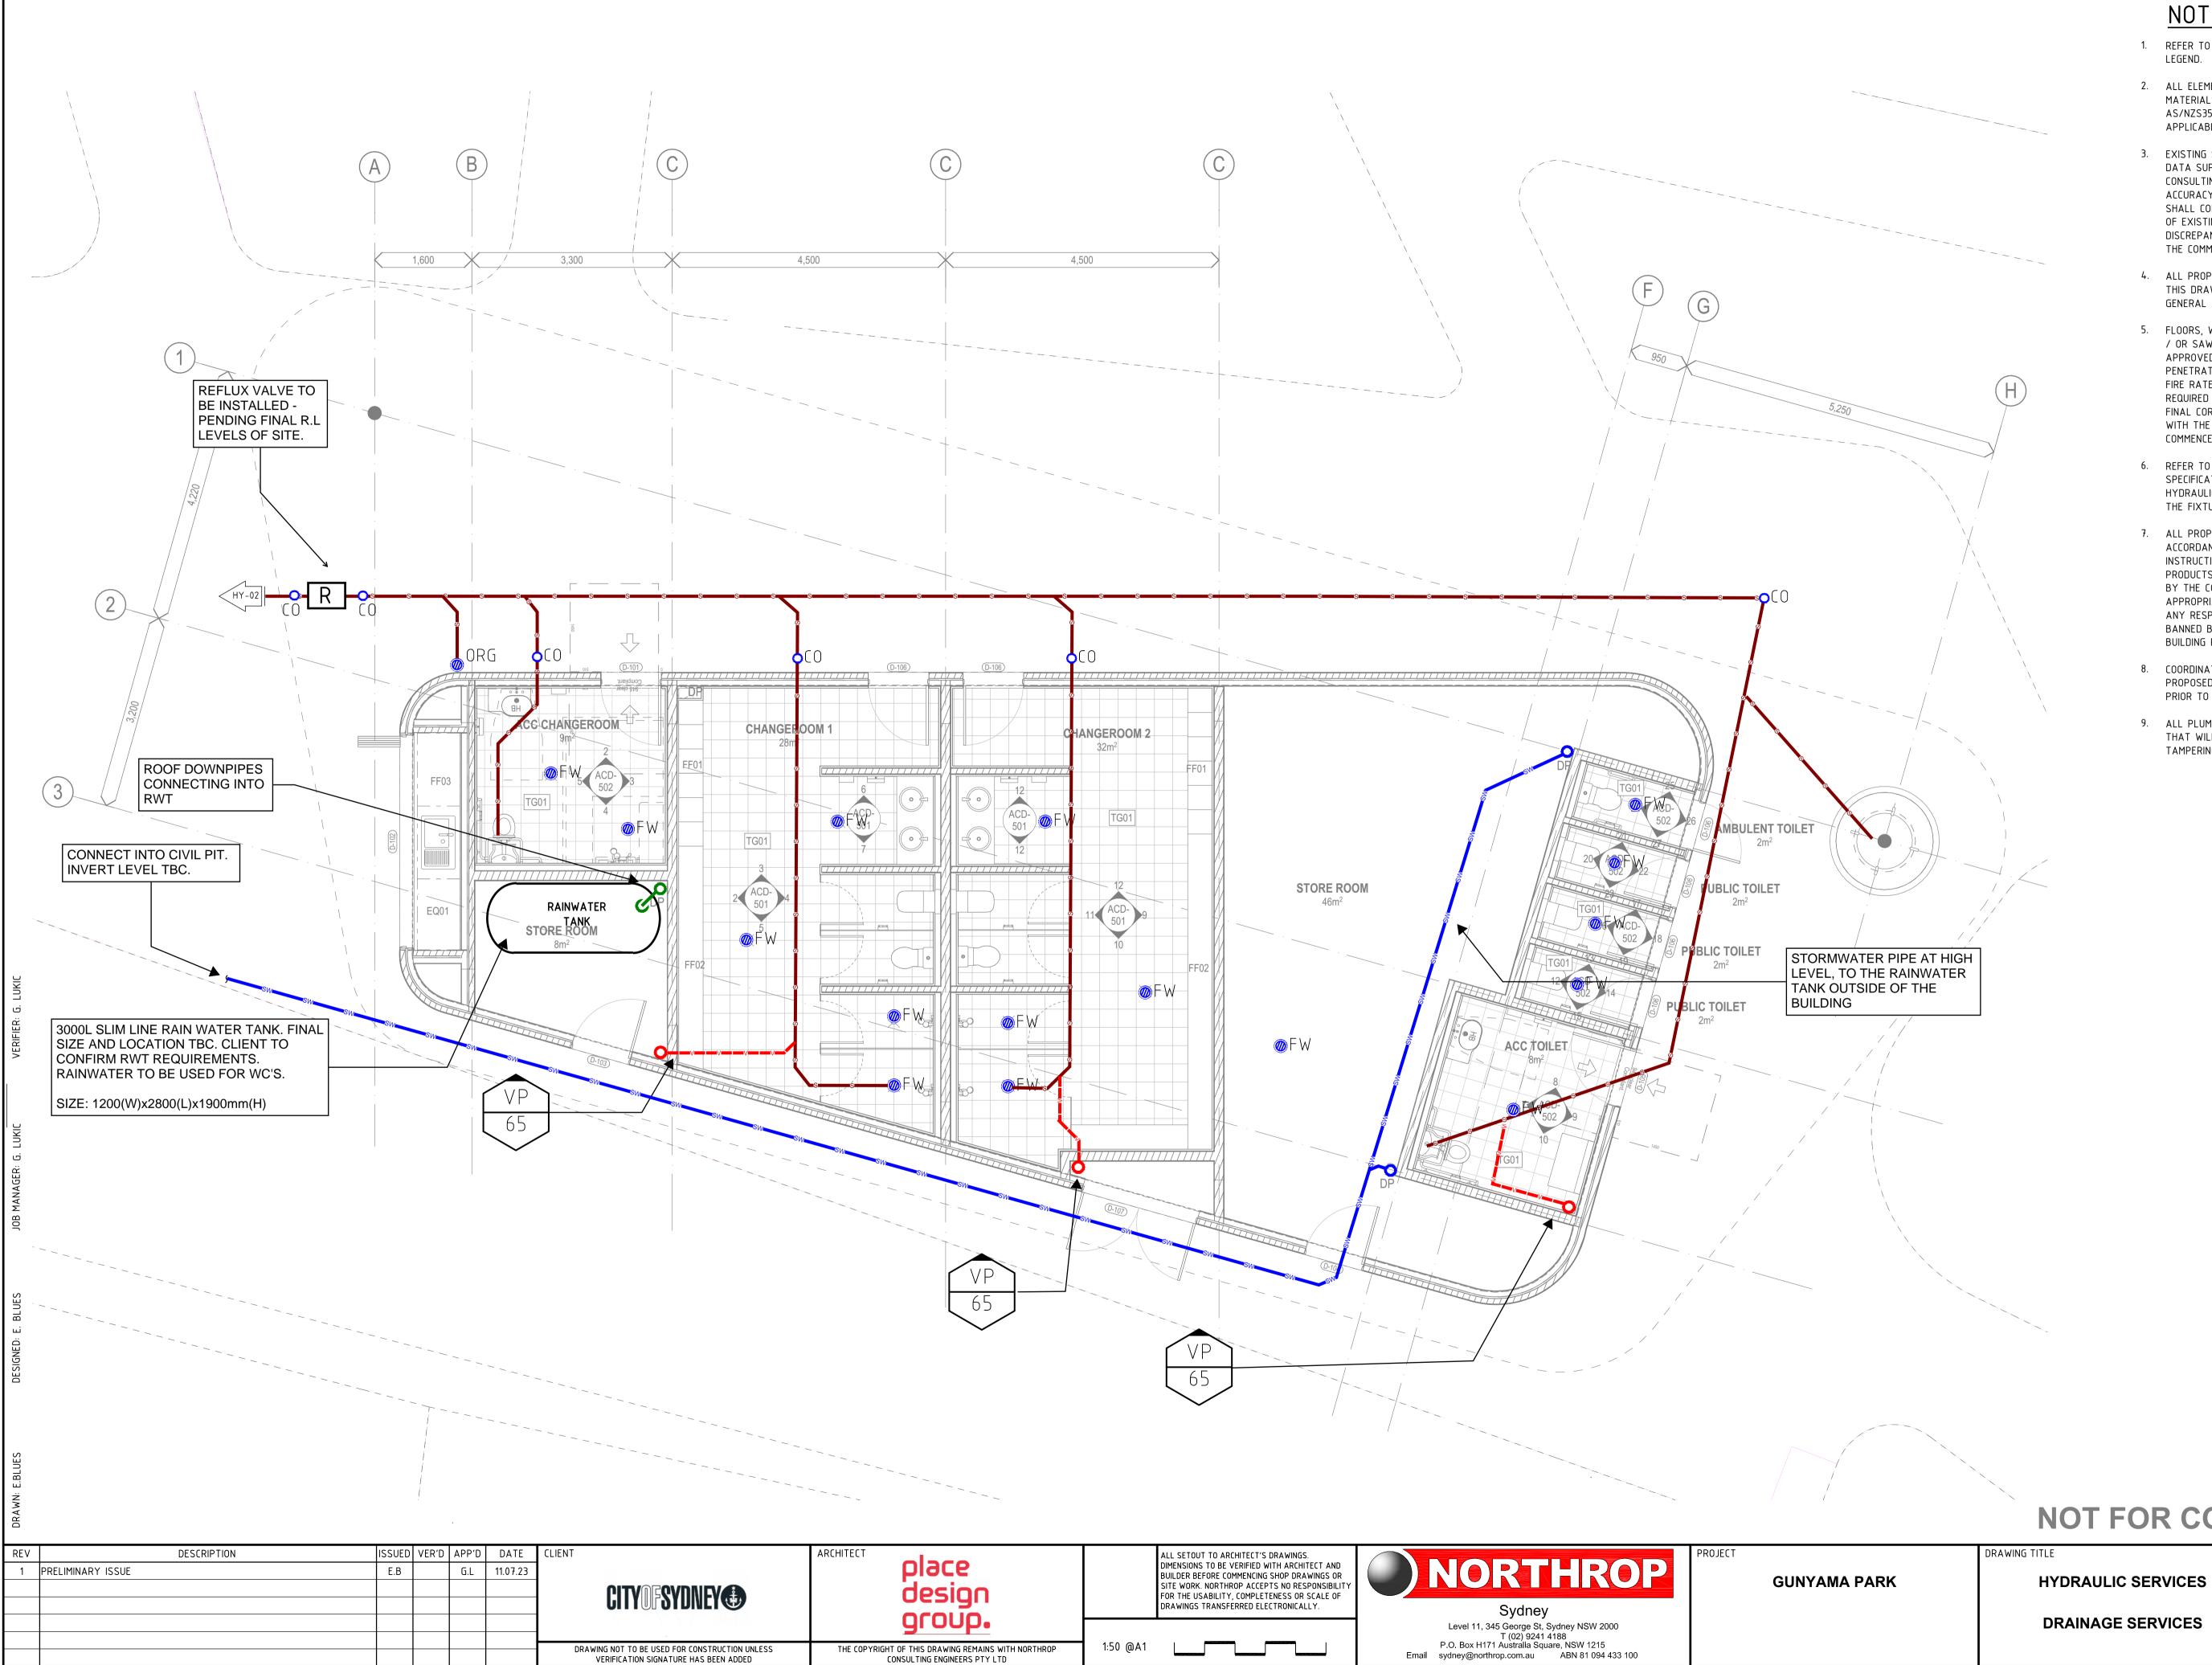

NOTE

- 1. REFER TO H00.01 FOR GENERAL NOTES AND LEGEND.
- 2. ALL ELEMENTS OF THE INSTALLATION AND MATERIALS ARE TO COMPLY WITH ALL PARTS OF AS/NZS3500, AS5601, AS2419 AND AS2441 WHERE APPLICABLE.
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NOT FOR CONSTRUCTION


JOB NUMBER SY223309

DRAWING NUMBER

HY-03

DRAWING SHEET SIZE = A1

REVISION

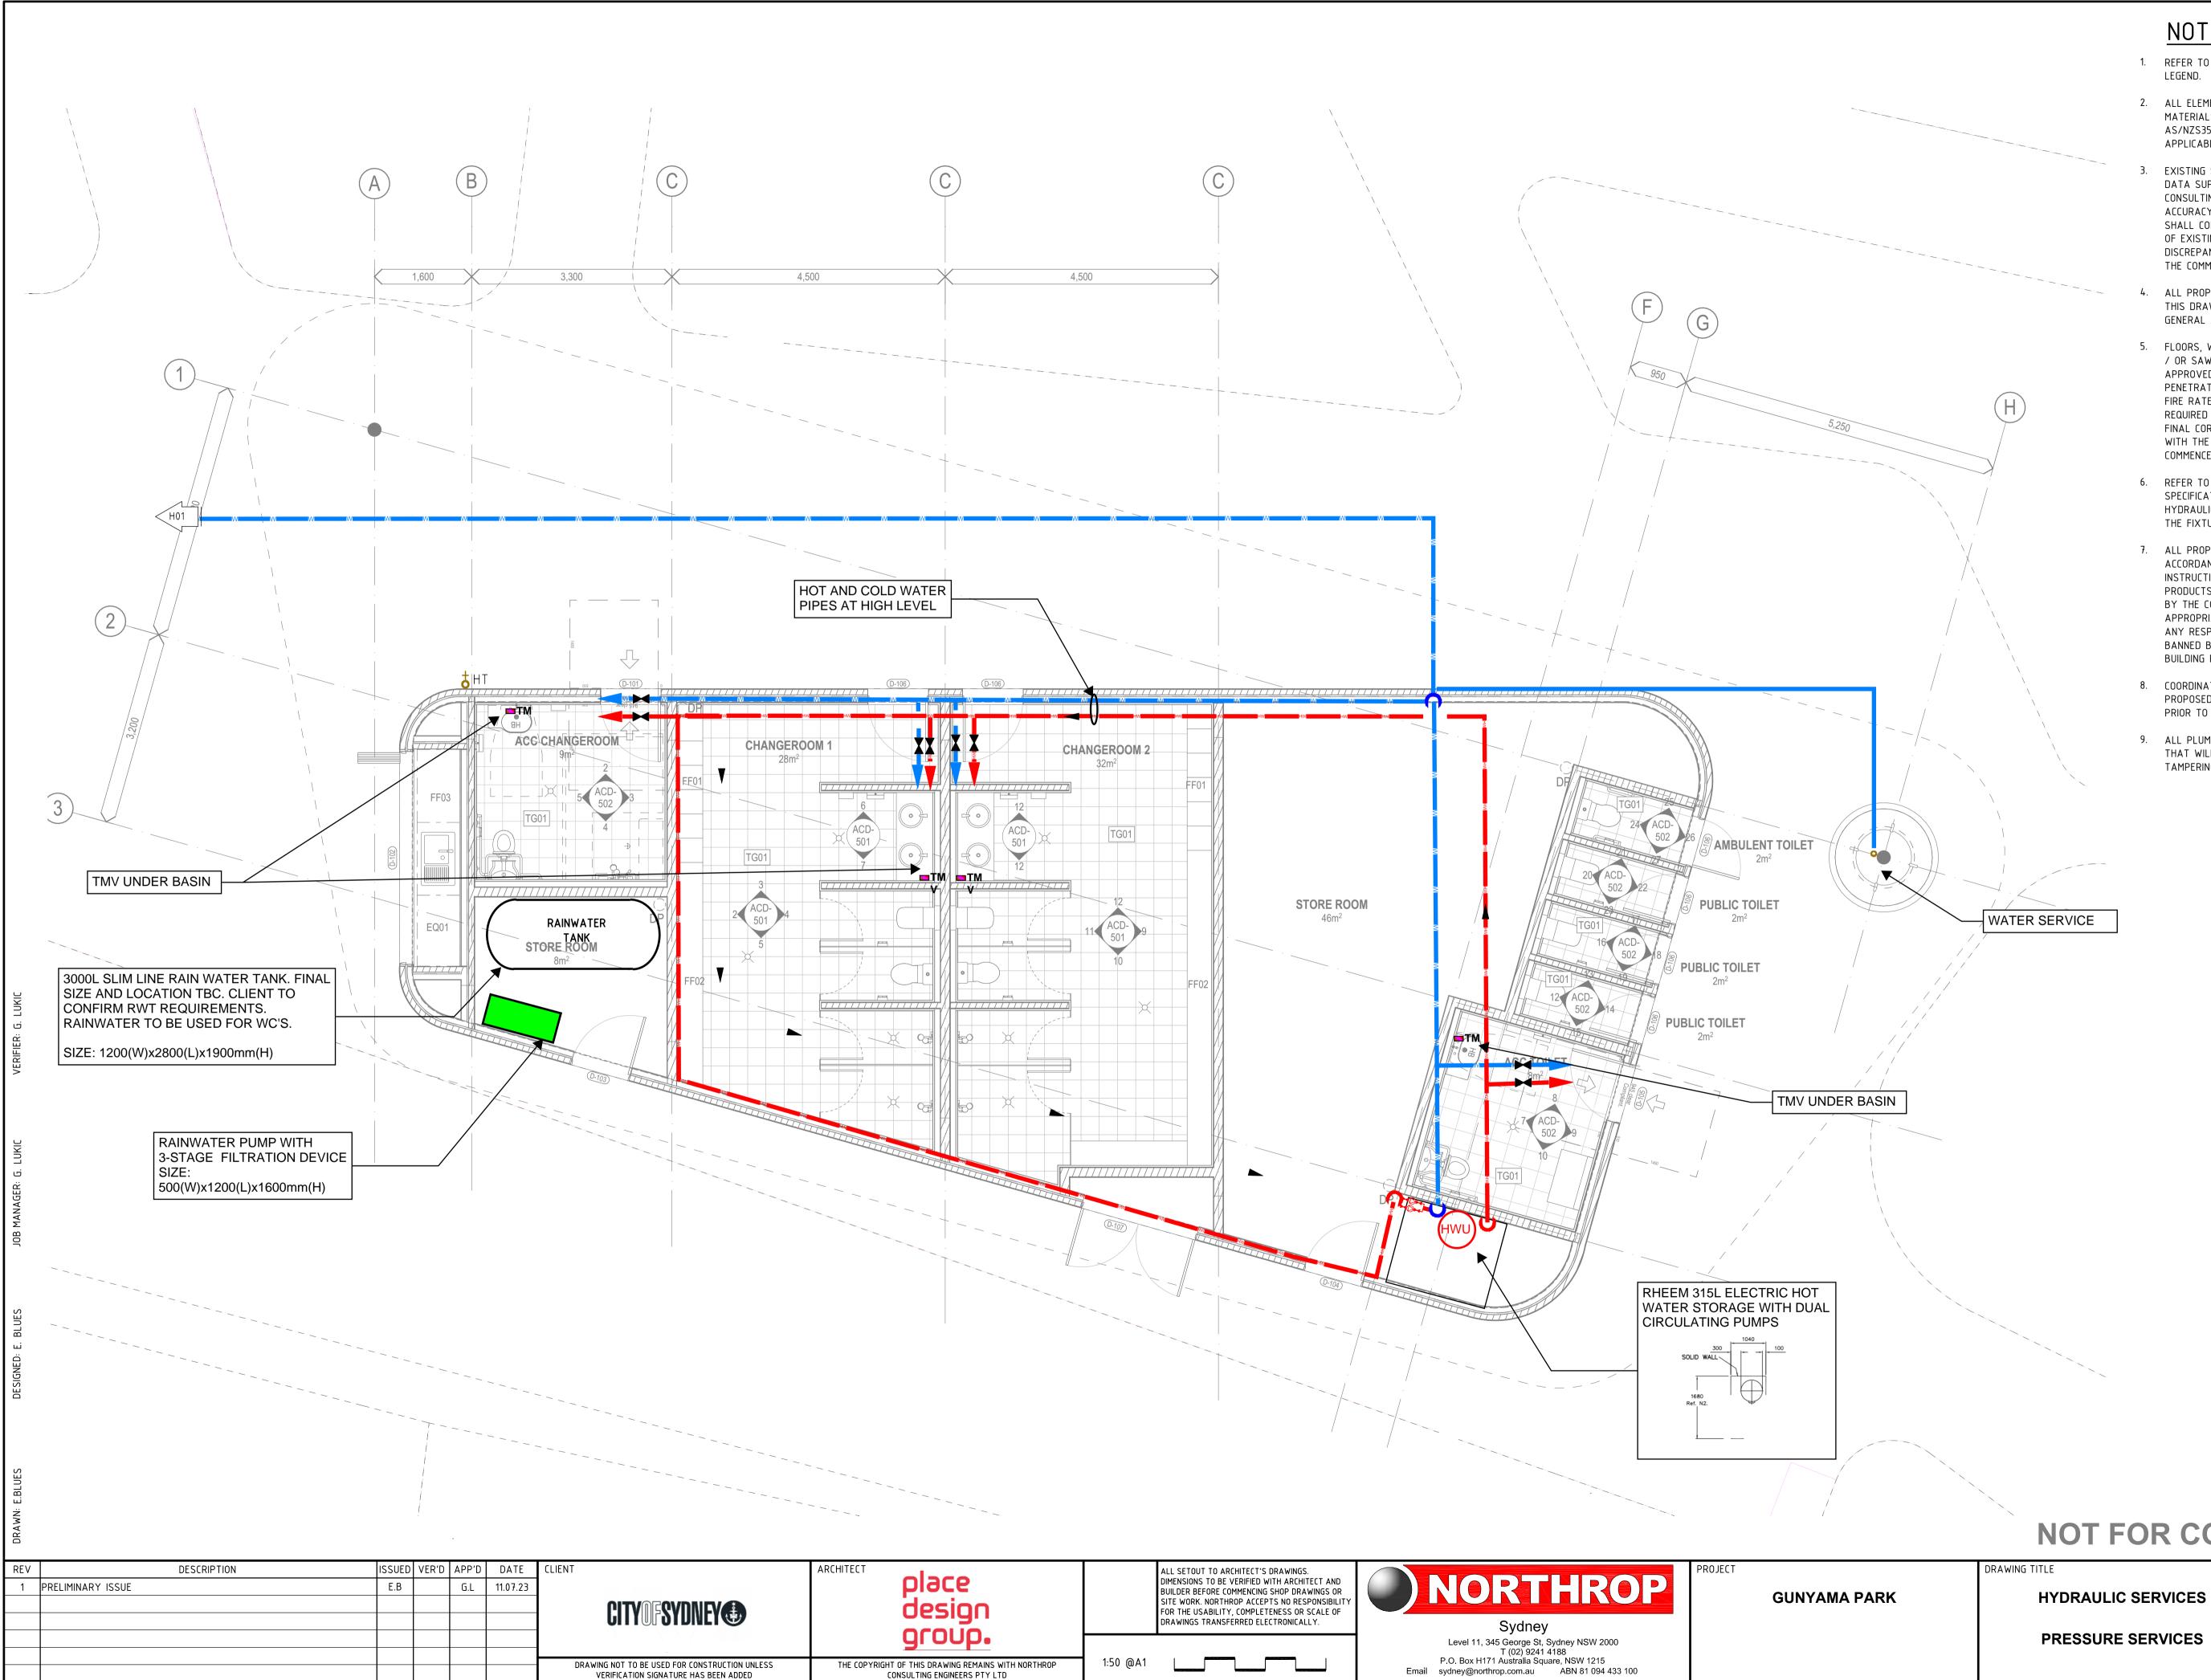

NOTE


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NOT FOR CONSTRUCTION

JOB NUMBER SY223309

DRAWING NUMBER REVISION **HY-04**

DRAWING SHEET SIZE = A1

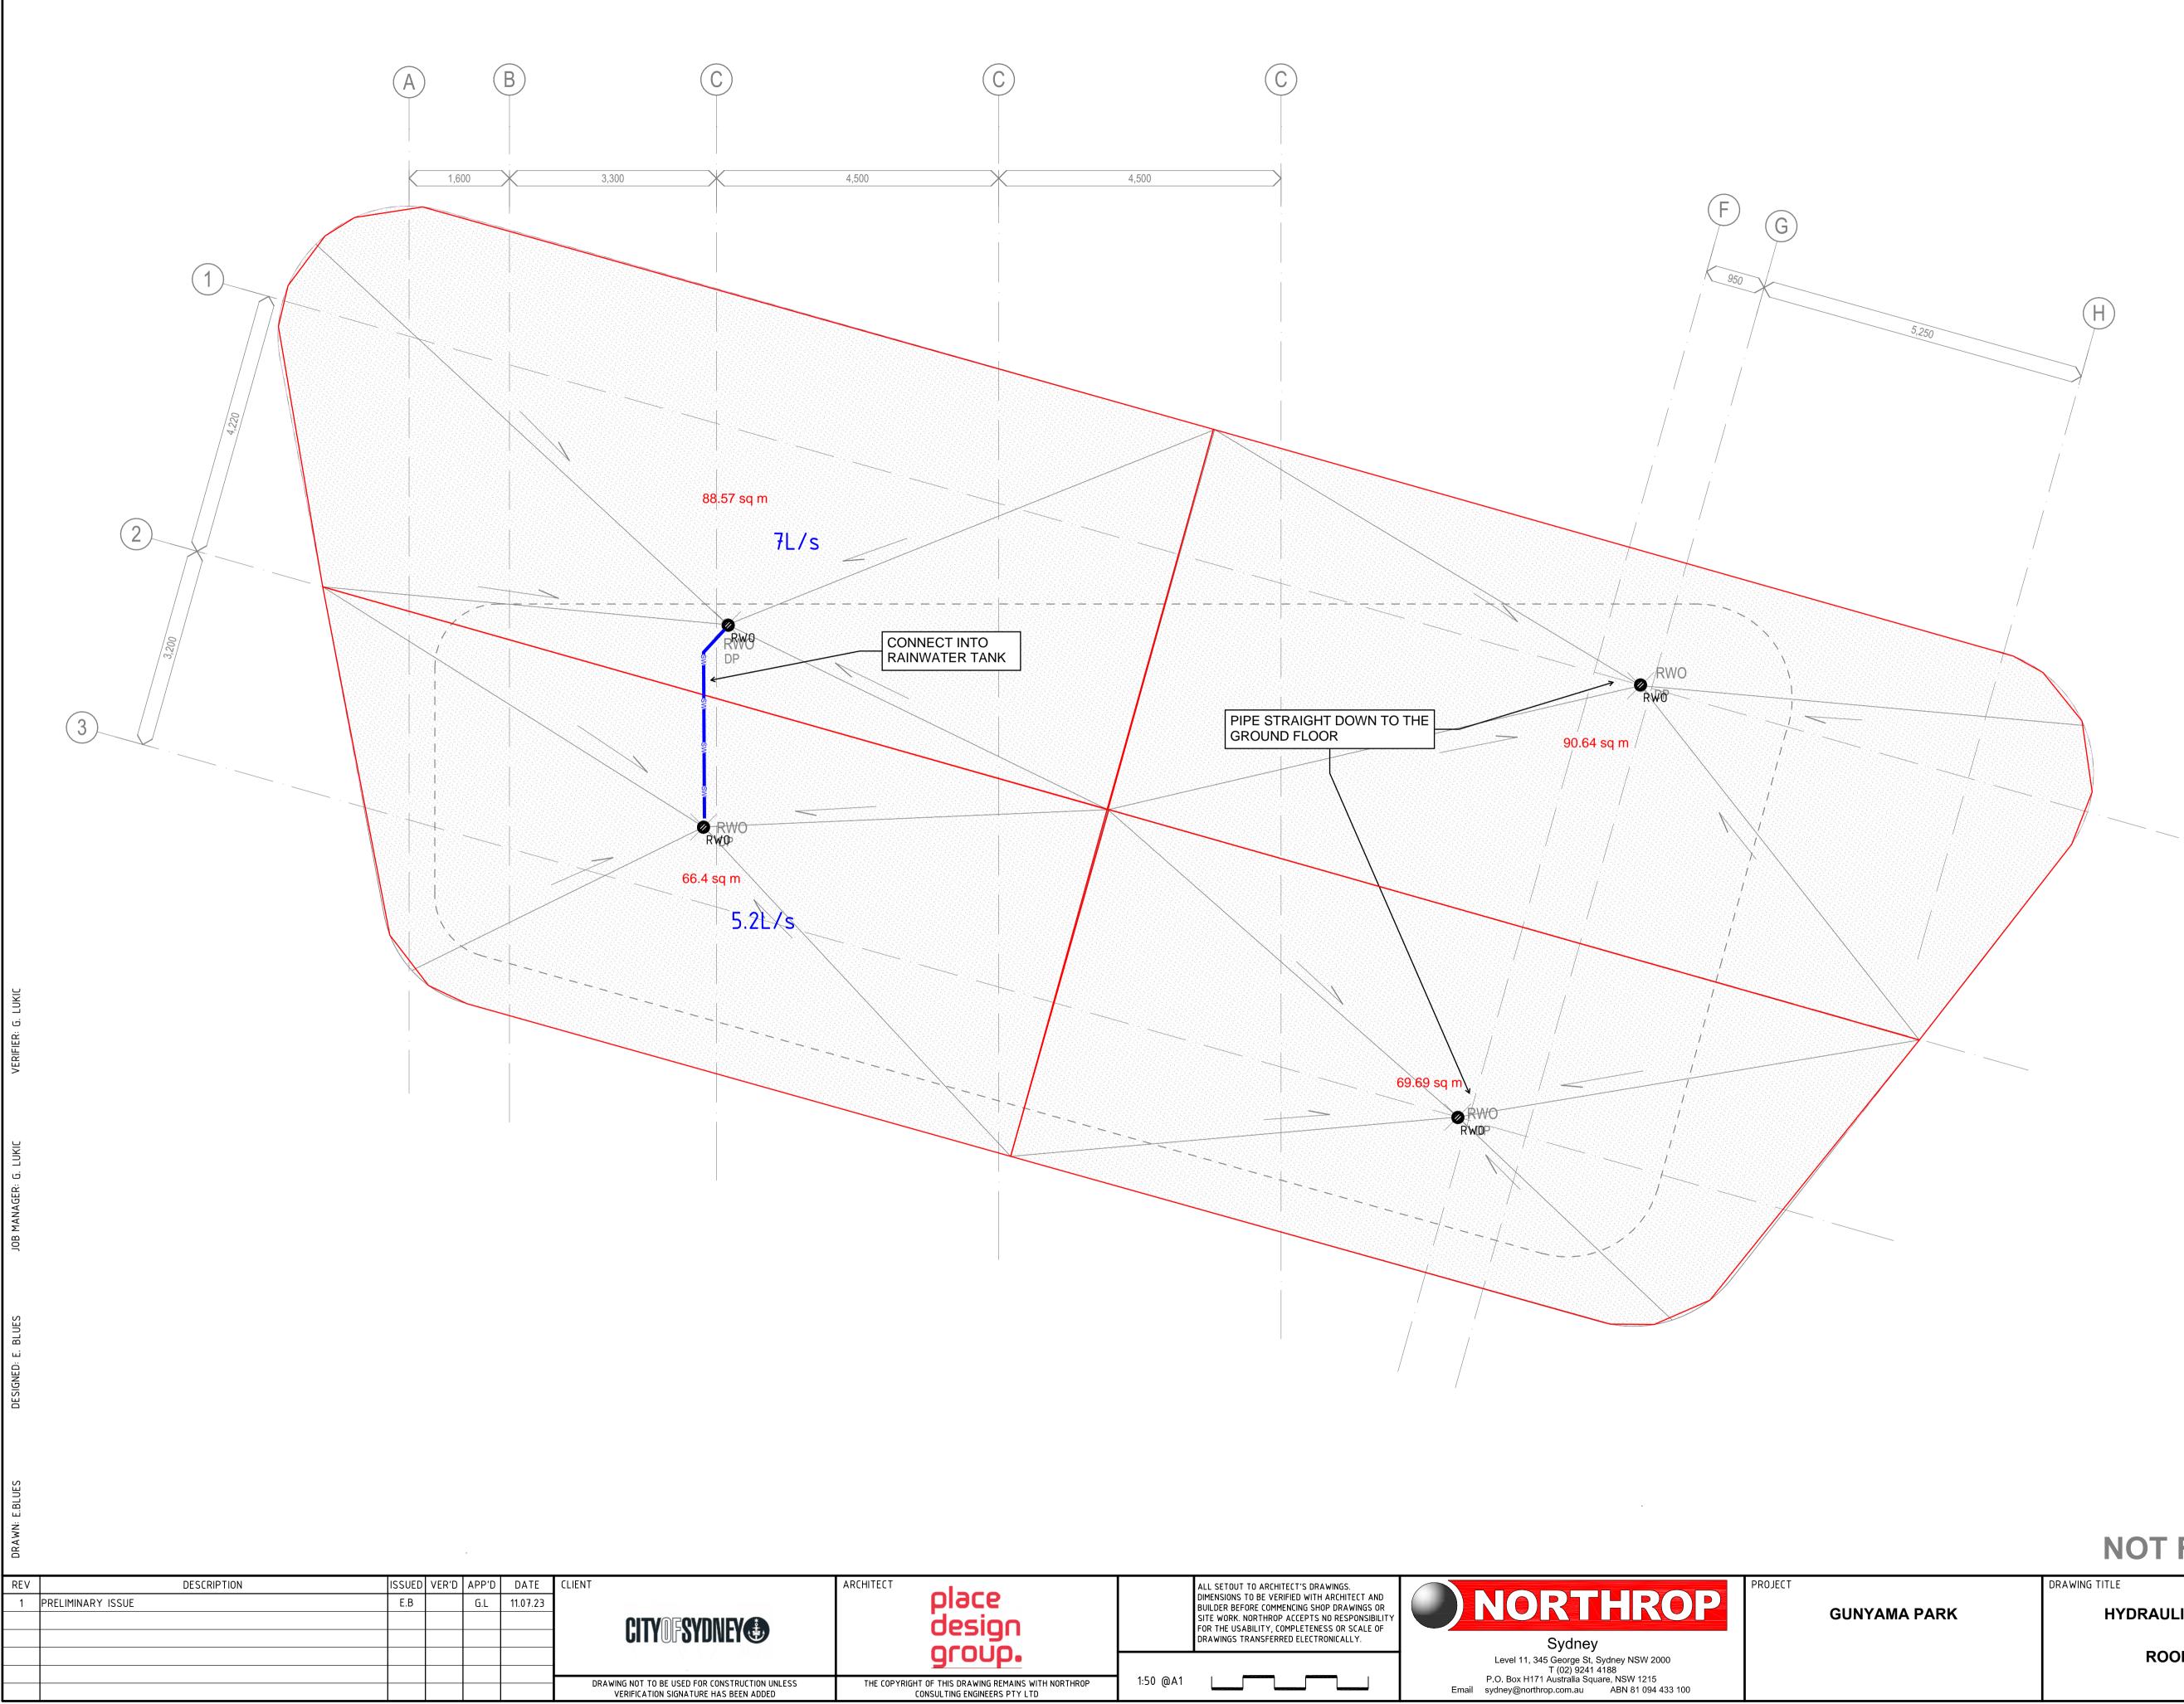

place design	ALL SETOUT TO ARCHITECT'S DRAWINGS. DIMENSIONS TO BE VERIFIED WITH ARCHITECT AND BUILDER BEFORE COMMENCING SHOP DRAWINGS OR SITE WORK. NORTHROP ACCEPTS NO RESPONSIBILITY FOR THE USABILITY, COMPLETENESS OR SCALE OF DRAWINGS TRANSFERRED ELECTRONICALLY.	NORTHROP Sydney	PROJECT
group.		Level 11, 345 George St, Sydney NSW 2000 T (02) 9241 4188	
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JOB NUMBER SY223309 HYDRAULIC SERVICES DRAWING NUMBER REVISION **ROOF PLAN** HY-05 DRAWING SHEET SIZE = A1

ALL SETOUT TO ARCHTECT'S DRAWINGS, DIMENSIONS TO BE VERIFIED WITH ARCHTECT AND BUILDER BEFORE COMMENCING SHOP DRAWINGS OR SITE WORK, NORTHROP ACCEPTS NO RESPONSIBILITY FOR THE USABILITY, COMPLETENESS OR SCALE OF DRAWINGS TRANSFERED ELECTRONICALLY, THE COPYRIGHT OF THIS DRAWING REMAINS THAN FOR THE USABILITY FOR THE

GENERAL

- THESE DRAWINGS SHALL BE READ IN CONJUNCTION WITH SPECIFICATIONS AND OTHER CONSULTANT'S DRAWINGS
- 62. THE WEATHER PROOFING OF THE BUILDING IS THE ARCHITECT'S/BUILDER'S RESPONSIBILITY. THIS INCLUDES (BUT IS NOT LIMITED TO) THE SPECIFICATION AND FIXING DETAILS OF CLADDINGS, SHEETING, FLASHING, MEMBRANES, STEPS, SETDOWNS & RECESSES
- G3. ALL DISCREPANCIES SHALL BE REFERRED TO THE PROJECT MANAGER AND RESOLVED BEFORE PROCEEDING WITH THE WORK.
- G4. ALL DIMENSIONS SHOWN SHALL BE VERIFIED BY THE BUILDER ON SITE. THESE STRUCTURAL DRAWINGS SHALL NOT BE SCALED FOR DIMENSIONS. THE RL'S SHOWN ON THESE DRAWINGS ARE APPROXIMATE AND ARE FOR THE SOLE PURPOSE OF ASSISTING THE STRUCTURAL DOCUMENTATION. THEY ARE NOT TO BE USED FOR CONSTRUCTION PURPOSES. REFER TO ARCHITECTURAL DRAWINGS FOR CONFIRMATION OF ALL RL'S, ALL LEVELS
- ARE IN METRES (m) AND DIMENSIONS ARE IN MILLIMETRES (mm) ALL WORKMANSHIP, TESTING, MATERIALS AND SUPERVISION ARE TO BE IN ACCORDANCE WITH THESE SPECIFICATIONS, THE WORK HEALTH AND SAFETY ACT 2011. ENFORCED BY THE WORKCOVER AUTHORITY AND CURRENT RELEVANT AUSTRALIAN STANDARDS.
- PROPRIETARY ITEMS SPECIFIED SHALL BE INSTALLED IN ACCORDANCE WITH THE MANUFACTURER'S WRITTEN RECOMMENDATIONS. DO NOT VARY SPECIFIED PROPRIETARY PRODUCTS WITHOUT WRITTEN APPROVAL FROM THE ENGINEER.
- G7. THESE DRAWINGS AND ISSUED WRITTEN INSTRUCTIONS DURING THE COURSE OF THE CONTRACT DEPICT THE COMPLETE STRUCTURE. THEY DO NOT DESCRIBE A WORK METHOD. THE ARRANGEMENT, DESIGN AND INSTALLATION OF TEMPORARY WORKS REMAINS THE RESPONSIBILITY OF THE CONTRACTOR
- THE DETERMINATION OF A SAFE WORK METHOD REMAINS THE RESPONSIBILITY OF THE CONTRACTOR. ANY ELEMENT WHICH POSES AN UNACCEPTABLE LEVEL OF SAFETY RISK TO CONSTRUCT SHALL BE REFERRED TO THE STRUCTURAL ENGINEER. TEMPORARY BRACING AND SUPPORT OF STRUCTURE IS THE RESPONSIBILITY OF THE CONTRACTOR AND SHALL BE MAINTAINED DURING ALL STAGES OF CONSTRUCTION.
- G9. NOTES ON ANY DRAWING APPLY TO ALL DRAWINGS IN THE SET UNLESS NOTED OTHERWISE
- G10. ALL ARCHITECTURAL FITMENTS SUCH AS GLAZING, PARTITIONS, CEILINGS ETC. SHOULD ALLOW FOR THE SHORE AND LONG TERM MOVEMENT OF STRUCTURAL ELEMENTS. FOR BEAMS AND SLABS SPANNING LESS THAN 8m AN ALLOWANCE OF AT LEAST 20mm SHOULD BE MADE (CONSULT ENGINEER WHERE SPANS EXCEED 8m).
- G11. THE BUILDER SHALL PROVIDE CERTIFICATION ON ANY DESIGN AND CONSTRUCT COMPONENT BY A CHARTERED PROFESSIONAL ENGINEER (NER).
- G12. THE CONTRACTOR SHALL BE RESPONSIBLE FOR THE LOCATION OF ALL SERVICES IN THE VICINITY OF THE WORKS ANY SERVICES SHOWN ARE PROVIDED FOR INFORMATION ONLY. THE CONTRACTOR SHALL CONFIRM THE LOCATION OF ALL SERVICES PRIOR TO COMMENCING AND SHALL BE RESPONSIBLE FOR THE REPAIR OF ANY DAMAGE CAUSED TO SERVICES, AS WELL AS ANY LOSS INCURRED AS A RESULT OF THE DAMAGE TO ANY SERVICE. G13. THE STRUCTURAL COMPONENTS DETAILED ON THESE STRUCTURAL DRAWINGS ARE JOB SPECIFIC AND HAVE BEEN
- DESIGNED IN ACCORDANCE WITH THE RELEVANT AUSTRALIAN STANDARDS AND BUILDING CODE OF AUSTRALIA FOR THE FOLLOWING FIRE RATINGS, WIND LOADS, FLOOR USAGE AND EARTHQUAKE LOADS. FIRE RATING LEVELS:



Б

ВР

DRAWN:

 \sim

	TINE RATING LEVELS.	
÷	- FLOOR SLAB AND BEAMS	= -/-/-
	 INTERNAL COLUMNS 	= -/-/-
و	 EXTERNAL COLUMNS 	= -/-/-
	- ROOF STRUCTURE	= -/-/-
Ā	WIND LOADS:	
Σ	- IMPORTANCE LEVEL	= 2
ഫ	- REGION	= A2
JOB MANAGER	 ANNUAL PROBABILITY OF EXCEDENCE 	= 1/500
•	- REGIONAL WIND SPEED V	= 45 m/s
	 TERRAIN CATEGORY 	= 2.5
	 TERRAIN MULTIPLIER Mz,cat 	= 0.87
	 WIND DIRECTION MULTIPLIER Md 	= 1
	 SHIELDING MULTIPLIER Ms 	= 1
	- TOPOGRAPHIC MULTIPLIER Mt	= 1
	 SITE WIND SPEED 	= 39.2 m/s
	FLOOR LIVE LOADS:	
	- GENERAL	= 4.0 kPa
_	ROOF LIVE LOADS:	
<u>п</u>	- ROOF	= 0.25 kPa
	EARTHQUAKE LOADS:	
	- IMPORTANCE LEVEL	= 2
	- ANNUAL PROBABILITY OF EXCEDENCE (P)	= 1:500
z	 PROBABILITY FACTOR (kp) 	= 1
9	- HAZARD FACTOR (Z)	= 0.8
DE SIGNED:	– DOMESTIC STRUCTURE?	= N
D	 SITE SUB-SOIL CLASS 	= Ce
	- EARTHQUAKE DESIGN CATEGORY (EDC)	= EDC I
	- DESIGN REQUIRED	= SIMPLE STATIC CHECK

TEMPORARY WORKS

- TW1. THESE DRAWINGS DEPICT THE "PERMANENT" STRUCTURE. TEMPORARY WORKS REMAIN THE RESPONSIBILITY F THE CONTRACTOR
- TW2. BUILDER MUST ENGAGE (NER) QUALIFIED STRUCTURAL ENGINEER FOR THE DESIGN OF ALL TEMPORARY WORKS NECESSARY TO SAFELY ERECT THIS STRUCTURE. AS A MINIMUM THE FOLLOWING WORKS REQUIRE ATTENTION:
- FORMWORK / TEMPORARY PROPPING / NEEDLE BEAMS / SCAFFOLDING / UNDERPINNIN


TW3. BUILDER SHALL CONTACT NORTHROP CONSULTING ENGINEERS IF THEY CONSIDER ANY PART OF THIS STRUCTURE IS UNSAFE TO ERECT

CONSTRUCTION PHASE SERVICES (WITNESS POINTS)

- WP1. OBTAIN NORTHROP CONSULTING ENGINEERS WRITTEN INSTRUCTION AT THE FOLLOWING HOLD POINTS: PREPARATION OF FOUNDING MATERIAL REINFORCEMENT PRIOR TO PLACEMENT OF CONCRETE or COREFILLING OF BLOCKWORK
- STEEL FRAME INSPECTION PRIOR TO SHEETING.
- WP2. PROVIDE MINIMUM 48 HOURS NOTICE FOR ANY REQUIRED INSPECTIONS.

FOUNDATIONS

- F1. ASSUMED ALLOWABLE BEARING CAPACITY:
 - PAD FOOTINGS = 150 kPa STRIP FOOTINGS = 150 kPa
 - SLABS ON GROUND = 150 kPa
- A GEOTECHNICAL REPORT HAS BEEN CARRIED OUT, REFER TO REPORT No. 73743.06 PREPARED BY F2. DOUGLAS PARTNERS. THIS REPORT IS FOR INFORMATION ONLY, IT IS NOT A COMPLETE DESCRIPTION OF CONDITIONS AT OR BELOW GROUND LEVEL.
- THE SLAB AND FOOTINGS HAVE BEEN DESIGNED IN ACCORDANCE WITH AS2870-2011 FOR CLASS [S] SITE. A SUITABLY QUALIFIED GEOTECHNICAL ENGINEER TO BE CONTACTED DURING EXCAVATION TO CONFIRM THE SITE ΓΙ ΔSSIFICATION
- F4. THE CONTRACTOR SHALL ALLOW TO ENGAGE A QUALIFIED (NER) GEOTECHNICAL ENGINEER TO APPROVE THE FOUNDATION MATERIAL. OBTAIN GEOTECHNICAL ENGINEERS APPROVAL AND SUBMIT CERTIFICATE IN WRITING TO
- NORTHROP CONSULTING ENGINEERS PRIOR TO CONCRETING FOUNDATIONS. ENSURE STABILITY OF ADJACENT BUILDINGS AND PATHS IS MAINTAINED DURING ALL STAGES O F5.
 - CONSTRUCTION.
- DO NOT ALLOW EXCAVATED MATERIAL TO BE STOCKPILED WITHIN 1500mm OF FOOTING TRENCHES OR PITS. F6. NO EARTH OR DETRITUS IS TO FALL INTO THE FOOTING TRENCHES BEFORE OR DURING CONCRETE PLACEMENT
- F7. THE UNDERSIDE OF FOUNDATIONS SHALL CONFORM TO THE FOLLOWING REGARDLESS OF NOMINATED LEVELS:

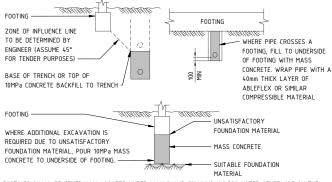

FOOTINGS SHALL BE CENTRALLY LOCATED UNDER WALLS AND COLUMNS UNLESS NOTED OTHERWISE ON THE F8. STRUCTURAL DRAWINGS.

- FOOTINGS SHALL BE EXCAVATED TO THE DETAILED DEPTH AND WIDTH. FOOTINGS SHALL BE INSPECTED AND FILLED WITH CONCRETE AS SOON AS POSSIBLE TO AVOID EITHER SOFTENING OF THE FOUNDATION MATERIAL OF DRYING OUT BY EXPOSURE.
- THE BASE OF ALL PIER HOLES SHALL BE FREE OF WATER AND CLEANED OF LOOSE MATERIAL OR DEBRIS PRIOR TO PLACEMENT OF CONCRETE, ALLOW TO PROVIDE TEMPORARY LINERS AS DEEMED NECESSARY.

WORKPLACE HEALTH AND SAFETY

- WHS1. THE CONTRACTOR AND ALL SUBCONTRACTORS ARE RESPONSIBLE FOR CONSTRUCTING THE WORK IN ACCORDANCE WITH THE WORK HEALTH AND SAFETY (WHS) ACT 2011. WHS REGULATIONS 2011. RELEVANT CODES OF PRACTICE, AUSTRALIAN STANDARDS AND OTHER REGULATORY REQUIREMENTS. THE PRINCIPLE CONTRACTOR MUST INFORM ALL STAKEHOLDERS INCLUDING NORTHROP OF NEW HAZARDS IDENTIFIED IN THE COURSE OF PLANNING AND UNDERTAKING THE WORKS.
- WHS2. DURING THE DESIGN OF THE STRUCTURE NORTHROP HAS IDENTIFIED RESIDUAL HAZARDS RELATING TO THE DESIGN OF THE STRUCTURAL WORKS THAT WE CONSIDER TO BE UNUSUAL OR NON-TYPICAL. HAZARDS WHICH ARE NORMAL WORKPLACE HAZARDS, ARE TO BE MANAGED BY PERSONS IN CONTROL OF THE WORKPLACE THROUGH A WHS SYSTEM TO MANAGE THE NORMAL HAZARDS ASSOCIATED WITH CONSTRUCTION, USE AND MAINTENANCE OF THE STRUCTURE. THE RESIDUAL HAZARDS IDENTIFIED ON THE NORTHROP DRAWINGS ARE NOT AN ENTIRE ASSESSMENT OF HAZARDS, AND DO NOT RELIEVE OTHER PARTIES OR STAKEHOLDERS OF THE THEIR RESPONSIBILITY UNDER THE WHS ACT 2011. WHS REGULATIONS 2011, AND THE CODE OF PRACTICE FOR SAFE DESIGN OF STRUCTURES. WHS3. TEMPORARY BRACING AND SUPPORT OF STRUCTURE IS THE RESPONSIBILITY OF THE CONTRACTOR AND
- SHALL BE MAINTAINED DURING ALL STAGES OF CONSTRUCTION.

WHS4. RESIDUAL HAZARDS ARE SHOWN ON THE NORTHROP DRAWINGS. IDENTIFIED BY: S1

FORMWORK

- FW1. THE DESIGN, CERTIFICATION, CONSTRUCTION, INSPECTION AND PERFORMANCE OF THE FORMWORK AND FALSE WORK SHALL BE THE RESPONSIBILITY OF THE FORMWORK SUB-CONTRACTOR, EXCEPT TO THE EXTENT THAT FORMWORK DESIGN IS SHOWN ON THE STRUCTURAL DRAWINGS.
- FW2. FORMWORK SHALL BE CERTIFIED BY A STRUCTURAL ENGINEER EXPERIENCED IN FORMWORK DESIGN IN ACCORDANCE WITH WORKCOVER REGULATIONS AND THE WORKCOVER CODE OF PRACTICE.
- FW3. FORMWORK SHALL BE DESIGNED IN ACCORDANCE WITH AS3610-1995. THE DESIGN SHALL ACCOMMODATE MOVEMENTS AND LOAD RE-DISTRIBUTION DUE TO ANY POST TENSIONING.
- FWA PROVIDE RESTRAINT OR SUPPORT TO ENSURE STABILITY OF FORMWORK THAT IS INDEPENDENT OF THE PERMANENT STRUCTURE. APPROVAL FROM NORTHROP CONSULTING ENGINEERS IS REQUIRED IF FORMWORK SUPPORT IS REQUIRED FROM THE PERMANENT STRUCTURE
- FW5. FOUNDATIONS SUPPORTING THE FORMWORK SHALL BE DETERMINED BY THE FORMWORK SUB-CONTRACTOR FROM THE CONDITIONS EXISTING ON SITE AT THE TIME OF CONSTRUCTION. REFER TO THE GEOTECHNICAL REPORT FOR THE SITE.
- FORMWORK CONSTRUCTION DIMENSIONAL TOLERANCES AND STRIPPING TIMES SHALL COMPLY WITH
- AS3610-1995 AND AS3600-2009 UNLESS OTHERWISE APPROVED BY NORTHROP CONSULTING ENGINEERS. FW7. DURING CONSTRUCTION, SUPPORT PROPPING WILL BE REQUIRED WHERE LOADS FROM STACKED MATERIALS, FORMWORK AND OTHER SUPPORTED SLABS INDUCE LOADS IN A SLAB OR BEAM WHICH EXCEED THE DESIGN CAPACITY FOR STRENGTH OR SERVICEABILITY LIMIT STATES AT THAT AGE. ONCE THE NOMINATED 28 DAY STRENGTH HAS BEEN ATTAINED, THESE LOADS SHALL NOT EXCEED THE DESIGN SUPERIMPOSED LOADS SET OUT IN THESE GENERAL NOTES AT ITEM G13.
- FW8. IT IS TO BE ANTICIPATED IN MULTI-STOREY CONSTRUCTION THAT BACK-PROPPING MAY BE REQUIRED TO EXTEND A NUMBER OF LEVELS BELOW THE FLOOR BEING CAST, PROP REMOVAL IS TO BE PROGRAMMED TO AVOID DISTRESS TO PREVIOUSLY CAST FLOORS. RE-SHORING OR BACKPROPPING PROPOSALS SHALL RE SUBJECT TO THE APPROVAL OF NORTHROP CONSULTING ENGINEER'S
- FW9. FORMED CONCRETE SURFACES SHALL HAVE FORMWORK CLASS AND SURFACE FINISHES IN ACCORDANCE WITH AS3610-1995, AS SPECIFIED BY THE PROJECT ARCHITECT, AND THE CONCRETE SECTION OF NORTHROP CONSULTING ENGINEERS STRUCTURAL NOTES.
- FW10. DO NOT PLACE PERMANENT LOADS ON THE CONCRETE STRUCTURE UNTIL AFTER FORMWORK AND PROPPING IS REMOVED.
- FW11. REFER TO PROJECT ARCHITECT'S DRAWINGS FOR TEST PANEL REQUIREMENTS. REINFORCEMENT FOR TEST PANELS SHALL BE SIMILAR TO THAT IN THE PERMANENT STRUCTURE REPRESENTED BY THE TEST PANEL
- FW12. BEFORE PLACING REINFORCEMENT IN THE FORMWORK, APPLY A RELEASE AGENT TO THE FACE OF THE FORMWORK IN ACCORDANCE WITH MANUFACTURER'S RECOMMENDATIONS.
- FW13. DO NOT APPLY A RELEASE AGENT TO THE FACE OF CONCRETE WHERE CONCRETE SURFACE FINISH OR APPLIED COVERINGS ARE INCOMPATIBLE WITH RELEASE AGENT.
- FW14. CHAMFER RE-ENTRANT ANGLES AND FILLET ALL CORNERS BY 25mm U.N.O. PROVIDE DRIP GROOVES TO UNDERSIDE OF ALL EXPOSED EDGES. FW15. BEFORE PLACING CONCRETE, REMOVE ALL WATER, DUST AND DEBRIS FROM THE FORMWORK
- FW16. FILL ALL HOLES LEFT BY FORMWORK TIE BOLTS WITH MORTAR MATCHING THE COLOUR OF THE FINISHED

CONCRETE

C1. CARRY OUT ALL CONCRETE WORK IN ACCORDANCE WITH AS3600-2018 AND NATSPEC CONCRETE STANDARDS C2. CONCRETE PROPERTIES AND COVER TO REINFORCING

			CONCRETE	MAXIMUM		
	ELEMENT		STRENGTH f'c (MPa)	56 DAY DRY SHRINKAGE	COVER	? (mm)
SLABS ON	EXTERNAL	NO MEMBRANE)	40	650 um	TOP 50	BTM 50
SROUND	INTERNAL (WITH MEMBRANE)	40	050 011	TOP 50	BTM 50
USPENDED SLA	35		40	650 um	50	
ILE CAPS			40	650 um	5	0
MAXIMUM AGGF	EGATE SIZE = 2	0mm U.N.O.				
SLUMP DURING	PLACING = 8	0mm ±10mm				
EXPOSURE CLA	SSIFICATION = [A1] (INTERNAL C	ONCRETE ELEMEN	NTS)		
	= [B1] (EXTERNAL	CONCRETE ELEME	NTS)		
		d in the concre	ETE MIX UNLESS	APPROVED BY NOR	RTHROP CON	SULTING
ENGINEERS IN V						
			SHALL BE VARIE	D FROM NORMAL C	LASS AS FO)LLOWS:
	UM CEMENT CONT	2				
			= AS NOMINATED			
				VIDE DRYING SHRIN		
				PECIFIED DRYING SI	HRINKAGE LI	MITS CAN
	HIEVED USING N					
				CORDANCE WITH A		A C 10 12 /
			DR SUB-ALPINE A		122000 AND	AS1012.4
	PROVAL THE FO			INEAS.		
			NOT PERMITTED)			
	PING AND BACK					
- DETA	IS AND LOCATIO	N OF CONDUITS	AND PENETRATIC	INS		
	TRUCTION JOINT I					
FOR TENDER PI	JRPOSES ASSUME	MINIMUM STRIP	PING TIMES AND	EXTENT OF BACK	PROPPING AS	S PER
AS3610-1995 S	ECTION 5.0 AND	AS PER GENERAL	NOTES FOR FOR	MWORK AND PROP	PING.	
FORMWORK FIN	SH CLASSIFICATI	ON TO AS3610.1-	2010 :			
ELEM		s				
INGDO	UND FOOTINGS	5				
- INURU						
	S & SLABS	2				
	S & SLABS	2				
	S & SLABS	2				

REV	DESCRIPTION	ISSUED	VER'D	APP'D	DATE	NORTHROP	PROJECT	DRAWING TITLE
1	50% ISSUE	BP	XX	BP	18.07.2023	Sydney		
						Level 11, 345 George St, Sydney NSW 2000 T (02) 9241 4188	GUNYAMA PARK - STAGE 2	STRUCTURAL PACKAGE
						sydney@northrop.com.au ABN 81 094 433 100		
						CLIENT		SPECIFICATION NOTES
						CITYOFSYDNEY		SHEET 1
								ONLET

CR.

C9.

- - C13. REINFORCEMENT QUALITY AND NOTATION

SYM

C7. SURFACE FINISHES :

- COLUMNS & WALLS OFF FORM
- FLOOR SLARS (LINO) MACHINE FLOAT
- WOOD FLOAT - SLABS TO BE TILED
- STAIRS STEEL TROWE

COMPACT ALL CONCRETE INCLUDING FOOTINGS AND SLABS USING MECHANICAL VIBRATORS.

PLACE CONCRETE CONTINUOUSLY BETWEEN CONSTRUCTION JOINTS SHOWN ON PLAN. DO NOT BREAK OR INTERRUPT SUCCESSIVE POURS SUCH THAT COLD JOINTS OCCUR. ANY REVISIONS OR ADDITIONS TO CONSTRUCTION JOINTS SHOWN ON PLAN REQUIRE APPROVAL FROM THE NORTHROP CONSULTING FNGINFERS

C10. CONCRETE PROFILES

- BEAM DEPTHS ARE WRITTEN FIRST AND INCLUDE THE SLAB THICKNESS
- SIZES OF CONCRETE ELEMENTS DO NOT INCLUDE THICKNESS OF APPLIED FINISHES.
- NO HOLES CHASES OR EMBEDMENT OF PIPES OTHER THAN SHOWN IN THE STRUCTURAL DRAWINGS SHALL BE MADE IN CONCRETE MEMBERS WITHOUT THE PRIOR WRITTEN APPROVAL OF NORTHROP CONSULTING ENGINEERS
- PROVIDE DRIP GROOVES AT ALL EXPOSED EDGES. CHAMFERS, DRIP GROOVES, REGLETS ETC TO ARCHITECT'SDETAILS.

C11. ALL PENETRATIONS TO HAVE 2/N16 TRIMMER BARS TOP AND BOTTOM TO EACH FACE, U.N.O. EXTEND FRIMMERS 600 BEYOND PENETRATION

C12. SETDOWNS OR FALLS IN FLOOR SURFACES ARE NOT PERMITTED UNLESS SHOWN ON DRAWINGS, MAINTAIN MINIMUM SLAB THICKNESS SHOWN ON PLAN WHERE FALLS OCCUR.

	RE	INFORCEMENT N	OTATION	
SYMBOL	BAR TYPE	STRENGTH GRADE (MPa)	DUCTILITY CLASS	TO COMPLY WITH AUSTRALIAN STANDARD
s	STRUCTURAL GRADE DEFORMED RIB BAR	250	NORMAL	AS/NZS 4671-2001
Ν	HOT ROLLED DEFORMED RIB BAR	500	NORMAL	AS/NZS 4671-2001
R	PLAIN ROUND BAR	250	NORMAL	AS/NZS 4671-2001
RL	RECTANGULAR MESH OF DEFORMED RIB BAR	500	LOW	AS/NZS 4671-2001
SL	SQUARE MESH OF DEFORMED RIB BAR	500	LOW	AS/NZS 4671-2001
L-TM	TRENCH MESH	500	LOW	AS/NZS 4671-2001

ALL REINFORCING BARS SHALL BE GRADE D500N TO AS/NZS 4671-2001 AND ALL MESH SHALL BE GRADE 500L TO AS/NZS 4671-2001, UNLESS NOTED OTHERWISE CLASS L REINFORCEMENT SHALL NOT BE USED.

REINFORCEMENT LABELS 12-300- SPACING (mm)

- BAR SIZE (mm)

— TYPE OF REINFORCEMEN

/N20 - BAR SIZE (mm) - NUMBER OF BARS



REINFORCEMENT IS REPRESENTED DIAGRAMMATICALLY, AND NOT NECESSARILY IN TRUE PROJECTION. BARS SHOWN ARE INDICATIVE ONLY AND LENGTHS MAY VARY, BEAM ELEVATIONS TAKE PRECEDENCE OVER SECTIONS. SLAB PLANS TAKE PRECEDENCE OVER SECTIONS. REFER TO SECTIONS FOR EXTRA BARS THAT MAY BE REQUIRED.

USE ONLY PLASTIC OR CONCRETE CHAIRS AT EXTERNAL SURFACES.

SITE BENDING OF REINFORCEMENT BARS SHALL BE DONE WITHOUT HEATING USING A RE-BENDING TOOL. THE BARS SHALL BE RE-BENT AGAINST A FLAT SURFACE OR A PIN WITH A DIAMETER NOT LESS THAN THE MINIMUM PIN SIZE PRESCRIBED IN AS3600-2018

SPLICES IN REINFORCEMENT SHALL BE MADE ONLY IN POSITIONS SHOWN ON THE STRUCTURAL DRAWINGS OR IN POSITIONS OTHERWISE APPROVED IN WRITING BY NORTHROP CONSULTING ENGINEERS, LAPS SHALL NOT BE LESS THAN THE DEVELOPMENT LENGTH FOR EACH BAR AND IN ACCORDANCE WITH AS3600-2009 SECTION 13.

LAPS IN MESH SHALL BE IN ACCORDANCE WITH AS3600-2018 SECTION 13

WELDING OF REINFORCEMENT SHALL NOT BE PERMITTED UNLESS SHOWN ON THE STRUCTURAL DRAWINGS OR APPROVED BY NORTHROP CONSULTING ENGINEERS.

AT EXTERNALLY EXPOSED SURFACES NO METALLIC ITEMS INCLUDING FORM BOLTS, FORM SPACERS

METALLIC BAR CHAIRS AND TIE-WIRE ARE TO BE PLACED IN THE COVER ZONE. ALL REINFORCEMENT ANCHOR BOLTS AND OTHER CONCRETE INSERTS SHALL BE WELL SECURED IN POSITION AND INSPECTED BY NORTHROP CONSULTING ENGINEERS PRIOR TO PLACING CONCRETE.

HOLD DOWN BOLTS SHALL BE HOT DIPPED GALVANISED. U.N.O. ALL MASONRY ANCHORS INTO CONCRETE SHALL BE RAMSET TRUBOLTS (LONGEST VERSION) OR APPROVED EQUIVALENT. BOLTS SHALL BE GALVANISED WHERE THEY ARE ADJOINING NON FERROUS OR

PREPAINTED MEMBERS. PROVIDE STAINLESS STEEL BOLTS FOR ALL EXTERNAL CONDITIONS, OR WHERE EXPOSED TO THE WEATHER.

ALL CONCRETE MIXES SHALL BE DESIGNED BY A RECOGNISED TESTING LAB AND SUBMITTED FOR REVIEW BY NORTHROP CONSULTING ENGINEERS

ALL COMPRESSIVE STRENGTH TEST REPORTS SHALL BE SUBMITTED TO NORTHROP CONSULTING ENGINEERS FOR REVIEW.

PROJECT CONTROL TESTING SHALL BE CARRIED OUT ON ALL CONCRETE IN ACCORDANCE WITH

AS1379-2007. TEST CYLINDERS ARE TO BE KEPT ON SITE.

CURING OF ALL CONCRETE IS TO BE ACHIEVED BY KEEPING SURFACES CONTINUOUSLY WET FOR A PERIOD

OF 7 DAYS. UNLESS SPECIFIED OTHERWISE, APPROVED SPRAY ON CURING COMPOUNDS THAT COMPLY WITH AS3799-1998 MAY BE USED WHERE FLOOR FINISHES WILL NOT BE AFFECTED. POLYTHENE SHEETING OR WET HESSIAN MAY BE USED TO RETAIN CONCRETE MOISTURE WHERE PROTECTED FROM WIND AND

TRAFFIC. CURING IS TO COMMENCE IMMEDIATELY AFTER CONCRETE PLACEMENT FOR ELAPSED TIME BETWEEN THE WETTING OF THE MIX AND THE DISCHARGE OF THE MIX, REFER TO

CONCRETE - ELAPSED DELIVERY TIMES NOTE.

NOT FOR CONSTRUCTION

DRAWING NUMBER

SK-01

SY223309-00

DRAWING SHEET SIZE = A3

REVISION

JOB NUMBER

PACKAGE

ALL SETOUT TO ARCHTECT'S DRAWINGS, DIMENSIONS TO BE VERIFIED WITH ARCHTECT AND BUILDER BEFORE COMMENCING SHOP DRAWINGS OR SITE WORK, NORTHROP ACCEPTS NO RESPONSIBILITY FOR THE USABILITY, COMPLETENESS OR SCALE OF DRAWINGS TRANSFERED ELECTRONICALLY, THE COPYRIGHT OF THIS DRAWING REMAINS THAN FOR THE USABILITY FOR THE

STEELWORK (CONTINUED)

ARE TO BE HOT DIP GALVANISED.

DRAWINGS.

TERM

BOTH SIDES

BLOCK WALL

BRICK WALI

CENTRE LINE

CENTRES

SECTION

CONCRETE

CENTRALLY PLACED

CIRCULAR HOLLOW

CONCRETE WALL

DFFP/DFPTH

DIAMETER INSIDE

DIAMETER NOMINAL

DIAMETER OUTSIDE

DIAMETER

DRAWING

ΕΔΓΗ ΕΔΓΕ

EACH WAY

EXPANSION JOINT

FINISHED FLOOR LEVEL

EXISTING

FAR SIDE

FAR FACE

GAL VANISED

HIGH/HEIGHT

HORIZONTAL

(LIVE LOAD)

LONG/LENGTH

LENGTH VARIES

BRACKET

GENERAL PURPOSE

IMPOSED ACTION

INTERSECTION POINT

GUNYAMA PARK - STAGE 2

EQUAL

CONSTRUCTION JOINT

BOTTOM

COMPRESSIVE STRENGTH AT 7 DAYS OF 40MPa.

ABBREVIATION

B/S

BW

BRW

CENT

CTS

CHS

LUNL

CW

CJ

DN

Π

EW

ΕQ

FΙ

FFI

GAL V

HORIZ

ΙV

GPB

FXST

S21. GROUT ALL STEEL BASES BY DRY PACKING USING GROUT WHICH IS NON-SHRINK AND HAS A MINIMUM

S22. PROVIDE SEAL PLATES TO THE ENDS OF ALL HOLLOW SECTIONS, WITH 'BREATHER' HOLES IF MEMBERS

\$23 THESE DRAWINGS MAY NOT IDENTIFY ALL SECONDARY STEEL WORK ELEMENTS THAT ARE REQUIRED FOR

THE INCLUSION OF SUCH STEELWORK ELEMENTS TO THE EXTENT REQUIRED ON THE ARCHITECT'S

LEGEND

SUPPORT, FIXING AND FINISHING OF GLAZING, CLADDING AND LINING. THE TENDERER IS RESPONSIBLE FOR

TERM

MAXIMUM

MINIMUM

MISCELLANEOUS

NOT SHOWN ON PLAN

NOT SHOWN ON

NOT TO SCALE

FLANGE CHANNEL

(DEAD LOAD)

DUANTITY

RADIUS

POST TENSION

RECTANGULAR

HOLLOW SECTION

REINFORCEMENT

HOLLOW SECTION

TOP & BOTTOM

UNEQUAL ANGLE

UNIVERSAL BEAM

UNLESS NOTED

OTHERWISE

WIDE/WIDTH

VERTICAL

UNIVERSAL COLUMN

REQUIRED

SQUARE

SQUARED

ΤΥΡΙΓΑΙ

UNDER SIDE

REINFORCED CONCRETE

PERMANENT ACTION

NEAR FACE

NEAR SIDE

ELEVATION

OPPOSITE

OVERALL

PARALLEL

PLATE

NOMINAL

ABBREVIATION

MAX

MIN

MISC

N/S

NOM

NSOF

NSOE

NTS

OPF

0/A

PFC

PI

ΡT

OTY

RAD

RHS

REINF

RFQ'D

SO

SHS

T&B

TYP

U/S

UB

١ſ

UNO

VERT

DRAWING TITLE

CHEMICAL ANCHORS

- CA01. UNLESS NOTED OTHERWISE, CHEMICAL ANCHORS SPECIFIED IN THESE DRAWINGS REFER TO HII TI HIT-HY 200 + HIT-V CHEMICAL INJECTION ANCHORS.
- CA02. ALTERNATIVE CHEMICAL ANCHORS MAY BE SUBSTITUTED WITH PRIOR PERMISSION FROM THE SUPERINTENDENT.
- CA03. MINIMUM EDGE DISTANCE AND SPACING SETOUT OF THE ANCHORS ARE SPECIFIED ON THESE DRAWINGS. IF THE INSTALLED DISTANCES ARE LESS THAN THAT SPECIFIED NOTIFY THE SUPERINTENDENT FOR INSTRUCTION.
- CAOL CHEMICAL ANCHORS ARE TO BE STIRCTLY INSTALLED TO MANUFACTURERS INSTALLATION PROCEDURE CA05. DIAMETER OF HOLES TO MANUFACTURES SPECIFICATION FOR NOMINATED BOLT/BAR DIAMETER. DRILL
- HOLES USING A ROTARY PERCUSSION DRILL, DO NOT CORE DRILL HOLES.
- CA06. CLEAN AND DEGREASE BOLT/BARS PRIOR INSTALLATION.
- CA07. ENSURE CHEMICAL IS ALLOWED TO FULLY CURE IN ACCORDANCE WITH MANUFACTURE'S DETAILS PRIOR TO LOADING BOLTS/BARS.

TESTING REGIME FOR THE HILTI HIT-HY 200

AND HIT-V CHEMICAL INJECTION ANCHORS

- TR01. HOLD DOWN ANCHORS: TEST MIN. 1 ANCHOR PER BASE PLATE.
 - SHOULD THERE BE A FAILURE, ALL ANCHORS NEED TO BE TESTED FOR THAT BASE PLATE
- TEST LOADING IS AS FOLLOWS:

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MANAGER

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ВР

6

ВР

REV

1

- - THIS IS BASED ON AN 80% OF ULTIMATE CAPACITY OF THE BOLT, CARE SHOULD BE TAKEN NOT TO EXCEED THIS LOAD.

CONCRETE MASONRY

- CM1. MASONRY CONSTRUCTION IS TO CONFORM TO AS3700-2011.
- MORTAR CLASSIFICATION DURABILITY CLASSIFICATION OF BUILT IN COMPONENTS = R1
- DURABILITY GRADE OF EXTERNAL MASONRY UNITS
- = PROTECTED CM2. THE CHARACTERISTIC UNCONFINED COMPRESSIVE STRENGTH OF THE MASONRY UNITS SHALL BE 15MPa OR
- CM3. BED UNITS IN FRESHLY PREPARED MORTAR, UNIFORMLY MIXED CEMENT, LIME AND SAND IN THE RATIO OF 1:1:6 or 1:0:5 CONFORMING TO AS3700-2011.
- GROUT FILL FOR BLOCKWORK CM4.
 - COMPRESSIVE STRENGTH = N20MPa
 - MAXIMUM AGGREGATE SIZE = 10mm
 - SI UMP = 225mm
 - MINIMUM PORTLAND CEMENT CONTENT = 300kg/m³
 - COMPACT THE GROUT USING A MECHANICAL VIBRATOR AT CONTROL OR CONSTRUCTION JOINTS IN SLABS
- CONTROL JOINTS IN REINFORCED WALLS SHALL BE PROVIDED AT 12.0m CENTRES, PROVIDE R16-400 CM7. (600 LONG) DOWELS, PAINT ONE END WITH BITUMEN & PROVIDED EXPANSION CAP
- THE BOTTOM COURSE OF ALL REINFORCED BLOCKWORK SHALL CONSIST OF E-SHAPED BLOCKS TO ENABLE CM8. CLEANOUT AND TYING OF STEEL
 - FULLY BED FACE SHELLS ONLY
 - CLEAN OUT ALL CORES AFTER EACH DAY'S LAYING.
 - ENSURE STARTER BARS ARE CORRECTLY LOCATED IN FOOTINGS.
- MASONRY TIES SHALL BE HOT DIP GALVANISED WITH MINIMUM COATING MASS OF 300g/m² AND MEDIUM DUTY CLASSIFICATION FOR CAVITIES UP TO 60mm WIDE & HEAVY DUTY FOR CAVITIES OVER 60mm WIDE ANY FACE FIXED TIES SHALL BE FIXED USING A SCREW FIXING AND SHALL NOT BE NAILED. CM10. THE TOP COURSE OF ALL FREESTANDING HOLLOW BLOCK MASONRY SHALL CONSIST OF SOLID CAPPING
- CM11. SPACING OF MASONRY TIES:
- - ADJACENT TO WINDOWS AND RETURN WALLS = 400mm VERTICAL AND HORIZONTAL. = 400mm VERTICAL AND HORIZONTAL SOLID MASONRY
- OTHERWISE = 800mm VERTICAL AND HORIZONTAL
- CM12. NON-LOADBEARING HOLLOW BLOCK WALLS SHALL FINISH 20mm SHORT OF SLAB SOFFIT AND SHALL BE FASTENED TO THE SOFFIT USING M.E.T - 4 SLIDING TIES OR APPROVED EQUIVALENT AT 400mm CENTRES
- CM13. LOADBEARING HOLLOW BLOCK WALLS SHALL BE CAPPED WITH M.E.T. GRAPHITE GREASED SLIP JOINT OVER TOP COURSE OF BLOCKWOR
- CM14. WHERE MASONRY IS BUILT INTO STRUCTURAL STEEL OR PASSES A RETURN WALL ON THE INNER SKIN INSTALL MEDIUM DUTY TIES @ 400 MAXIMUM CT. SHOT FIX TIES TO STEELWORK.
- CM15. MINIMUM COVER TO REINFORCEMENT FROM THE INSIDE FACE OF THE FACE SHELL IS TO BE 25mm CM16. NO AIR ENTRAINING AGENTS (BYCOL, ETC.) ARE TO BE USED WITHOUT PRIOR WRITTEN PERMISSION FROM NORTHROP CONSULTING ENGINEERS
- CM17. MATERIALS INCLUDING MORTAR, CONCRETE, GROUT SHALL COMPLY WITH SECTION 10 OF AS3700-2001 MASONRY UNITS SHALL COMPLY WITH AS/NZS 4455.1-2008. WALL TIES SHALL COMPLY WITH AS/NZS 2699.1-2000
- CM18. MASONRY SHALL BE CONSTRUCTED IN ACCORDANCE WITH SECTION 11 OF AS3700-2011.
- CM19. DO NOT CONSTRUCT UNREINFORCED OR NON-LOAD BEARING REINFORCED MASONRY WALLS ON SUSPENDED
- CONCRETE SLABS UNTIL SLAB HAS BEEN STRIPPED AND DE-PROPPED. CM20. ALL LINTELS SUPPORTING BLOCKWORK ARE TO BE HOT DIP GALVANISED WITH MINIMUM COATING MASS OF 300n/m²

PROVIDE 1 LINTEL TO EACH WALL LEAF. DO NOT CUT ON SITE. KEEP LINTELS 6mm CLEAR OF DOOR HEADS AND WINDOW FRAMES. PACK MORTAR BETWEEN THE ANGLE UPSTAND AND SUPPORT MASONRY UNITS.

- MINIMUM BEARING EACH END OF LINTELS: SPANS 0mm to 1800mm = 200mm BEARING EACH END.
- SPANS 1801mm to 3000mm = 400mm BEARING EACH END.
- PROPPING OF LINTELS:

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TO PREVENT DEFLECTION OR EXCESSIVE ROTATION. TEMPORARILY PROP PROPRIETARY COLD-FORMED LINTELS UNTIL THE MASONRY REACHES ITS REQUIRED STRENGTH. MINIMUM PROPPING PERIOD IS TO BE 7 DAYS

- **STEELWORK**
- FABRICATE AND ERECT STRUCTURAL STEELWORK IN ACCORDANCE WITH AS4100-1998.
- PROVIDE HOLES, CLEATS AND FIXING FOR LIGHT STEEL/TIMBER FRAMING, FINISHES, ETC. SHOWN ON S2. ARCHITECTURAL DRAWINGS.
- S3. THESE DRAWINGS HAVE BEEN PREPARED TO INDICATE THE STRUCTURAL INTENT. THE SHOP DETAILER IS TO USE THESE DRAWINGS AS A BASIS FOR DIMENSIONAL COORDINATION WITH OTHER CONSULTANT'S DRAWINGS AND IS TO PREPARE DETAILED SHOP DRAWINGS. WHERE NECESSARY, THE SHOP DETAILER IS TO MAKE ASSUMPTIONS AND SUBMIT TO NORTHROP CONSULTING ENGINEERS FOR RESOLUTION, SHOP DETAILER IS TO ALLOW TO RE-WORK SHOP DRAWINGS AS NECESSARY. FABRICATOR SHALL PREPARE SHOP DRAWINGS AND SUBMIT THEM TO THE BUILDER FOR THEIR APPROVAL, BUILDER SHALL LODGE TWO HARD COPIES OF APPROVED DRAWINGS TO NORTHROP CONSULTING ENGINEERS FOR REVIEW PRIOR TO
- FABRICATION. (ALLOW 5 WORKING DAYS FOR REVIEW). S4. TYPICAL STEELWORK CONNECTIONS (UNLESS NOTED OTHERWISE):
 - COLUMN BASE PLATES: 10 BASE PLATE, 4/M16 HILTI HIT-HY200-R CHEMICAL INJECTION ANCHORS. BEAM TO TOP OF COLUMN: CAP PLATE, 2 BOLTS TO CHANNELS, 4 BOLTS TO RHS/CHS/SHS/UB/UC,
 - BEAM TO SIDE OF COLUMN: FIN PLATE, 2 BOLTS.
 - BEAM TO SIDE OF BEAM: END OR FIN PLATE, 2 BOLTS.
 - COLUMNS TO TOP OF BEAM: BASE PLATE, 2 BOLTS TO CHANNELS, 4 BOLTS TO UB/UC SECTIONS.
 - ALL ROOF & WALL BRACING: CLEAT PLATES, 2 BOLTS.
 - PURLINS/WALL GIRTS: 8 CLEAT PLATES. 2 PURLIN BOLTS.
 - UNLESS NOTED OTHERWISE USE:
 - 10mm BASE CAP GUSSET FIN AND END PLATES M20 8.8/S BOLTS. (4.6/S GRADE TO BE USED FOR HOLD DOWN BOLTS).
 - 6mm CONTINUOUS FILLET WELDS MADE WITH E4918 MILD STEEL ELECTRODES.
 - ALL WELDS SP CATEGORY.
- S5. NO PAINT ON MATING SURFACES WITH TF OR TB BOLTING UNLESS APPROVED BY NORTHROP CONSULTING ENGINEERS
- TF or TB BOLTS TO BE INSTALLED WITH ONE HARDENED WASHER UNDER THE TURNED PART.
- USE LOAD INDICATING WASHERS FOR ALL TB AND TF CONNECTIONS
- S8. ALL BOLTS, SCREWS, HOLD DOWN BOLTS, MASONRY ANCHORS SHALL BE HOT DIP GALVANISED TO AS1214-1983, AS/NZS 4534-2006, AS/NZS 4680-2006 & AS/NZS 4792-2006. NO CONNECTION SHALL HAVE LESS THAN 2 BOLTS. ALL BOLTS AND WASHERS SHALL BE GALVANISED. ALL HOLES SHALL BE 2mm LARGER THAN THE BOLT DIAMETER UNLESS NOTED OTHERWISE
- S9. MINIMUM YIELD STRESS:
 - HOT ROLLED SECTIONS SQUARE HOLLOW SECTIONS
 - = 350MPa. RECTANGULAR HOLLOW SECTIONS = 350MPa.
 - CIRCULAR HOLLOW SECTION = 250MPa.
- HOT ROLLED PLATE = 250MPa.
- S10. COLD FORMED SECTIONS TO CONFORM WITH:
- AS/NZS 1594-2002, AS/NZS 1595-1998, AS/NZS 4600-2005 AND AS 1397-2001, AS1397, AS/NZS1594 AND AS/NZS1595.
- MINIMUM YIELD STRESSES SECTIONS 450MPa.
- SII. SURFACE TREATMENT UNLESS NOTED OTHERWISE:
 - PROTECTED FROM WEATHER
 - EXPOSED TO WEATHER = AS/NZS 2312-IZS2
 - BUILT INTO THE INTERNAL SKIN OF EXTERNAL WALLS = AS/NZS 2312-IZS2. **REFER TO PURLIN & GIRTS NOTES FOR SURFACE TREATMENT OF THESE ITEMS**
- S12. UNLESS OTHERWISE DETAILED, FABRICATOR SHALL PROVIDE C100 15 TRIMMER PURLINS ALONG WITH GENERAL
- PURPOSE BRACKETS TO SUPPORT EDGE OF ROOF SHEETING AT ALL HIPS, VALLEYS AND PENETRATIONS.

= AS/NZS 2312-IZS2.

- S13. FIX CROSS BRACING TO PURLINS AT 3000 MAX CENTRES WITH M10 BOLTS OR M6 HOOKS. BOLTS ARE TO RE MECHANICALLY FIXED TO PURLINS WITH HOOKS TO BE LOOPED THROUGH THE WEB OF THE PURLINS AND SECURED USING A NUT TO ENSURE THEY WILL NOT BECOME LOOSE DURING MOVEMENT OF THE ROOF. ALTERNATIVELY GALVANISED STRAP MAY BE USED TO SECURE THE BRACING. THE STRAP IS TO BE NSTALLED TO LIFT THE BRACE SUCH THAT IT IS PLUMB, WITH THE BRACE SCREW FIXED TO THE WEB OF THE PURLIN AT BOTH ENDS USING 2/12-14 TEKS SCREWS.
- S14. ALL BURIED STEEL WORK TO BE TREATED BY: THE APPLICATION OF A SINGLE COAT OF INTERNATIONAL PROTECTIVE COATINGS INTERZONE 954
 - APPLIED TO BARE CLEAN STEEL (THICKNESS 300-400 MICRONS), APPLY TO WHOLE OF RELEVANT MEMBER, TOP COAT IF REQUIRED BY ARCHITECT FOR VISUAL APPEARANCE.
 - THE APPLICATION OF HDG AS SPECIFIED IN S11 ABOVE FOLLOWED BY AN APPLICATION OF TWO COATS OF INTERNATIONAL PROTECTIVE COATINGS INTERPLUS 1180 (EACH COAT 150-250 MICRONS) HERE BURIED IN THE GROUND.
 - THEN
- CONCRETE ENCASE STEELWORK WITH MASS CONCRETE (MINIMUM 75mm COVER TO STEELWORK). \$15. STEELWORK TO BE CONCRETE ENCASED FOR FIRE RATING PURPOSES SHALL BE FREE FROM ALL LOOSE RUST, LOOSE MILL SCALE, DIRT, OIL, GREASE, ETC. AND REINFORCED WITH SL41 FABRIC OR EQUIVALENT BLACK IRON WIRE, 3mm DIA.
- S16. BOLT SYMBOLS:

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4.6/S = GRADE 4.6 BOLT / SNUG TIGHTENED

AND AS2207-2007 AS APPROPRIATE.

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- 8.8/S = GRADE 8.8 BOLT / SNUG TIGHTENED.
- 8.8/TF = GRADE 8.8 BOLT / FULLY TENSIONED FRICTION TYPE (USE LOAD INDICATOR WASHERS).

8.8/TB = GRADE 8.8 BOLT / FULLY TENSIONED BEARING TYPE (USE LOAD INDICATOR WASHERS). S17. THE CONTRACTOR SHALL SUPPLY WRITTEN CERTIFICATION TO THE STRUCTURAL ENGINEER PRIOR TO TH

ERECTION OF ANY STRUCTURAL STEEL STATING THAT THE BOLTS PROPOSED TO BE USED COMPLY WITH AS/NZS 1252-1996. HIGH STRENGTH BOLTS (8.8) ARE NOT TO BE WELDED.

RADIOGRAPHIC OR ULTRASONIC EXAMINATION SHALL BE TO AS/NZS 1554.1-2004, AS 2177-2006

NORTHROP

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sydney@northrop.com.au ABN 81 094 433 100

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- S18. THE FABRICATION AND ERECTION OF THE STRUCTURAL STEEL WORK SHALL BE SUPERVISED BY A QUALIFIED PERSON EXPERIENCED IN SUCH SUPERVISION, IN ORDER TO ENSURE THAT ALL REQUIREMENTS OF THE DESIGN ARE MET.
- S19. ALL MEMBERS SHALL BE SUPPLIED IN SINGLE LENGTHS. SPLICES SHALL ONLY BE PERMITTED IN LOCATIONS SHOWN ON THE STRUCTURAL DRAWINGS.
- S20. ALL BUTT WELDS SHALL BE COMPLETE PENETRATION BUTT WELDS CATEGORY SP TO AS1554.1-2004 U.N.O THE EXTENT ON NON-DESTRUCTIVE WELD EXAMINATION SHALL BE AS NOTED BELOW:

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JOB NUMBER

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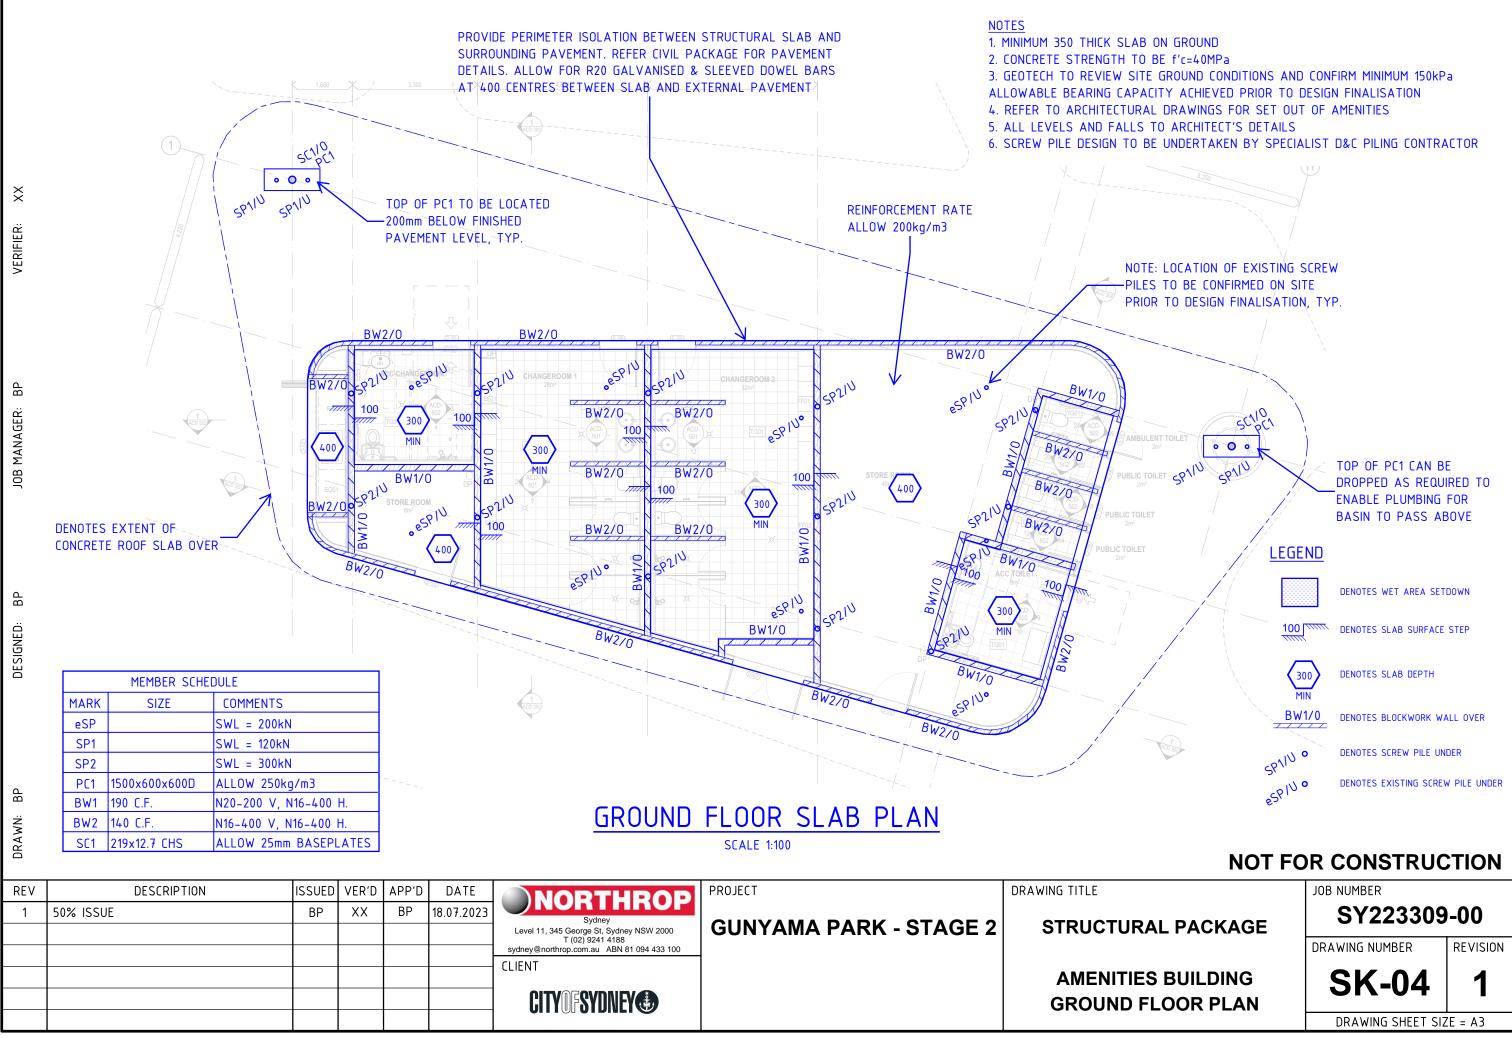


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STRUCTURAL PACKAGE

SPECIFICATION NOTES


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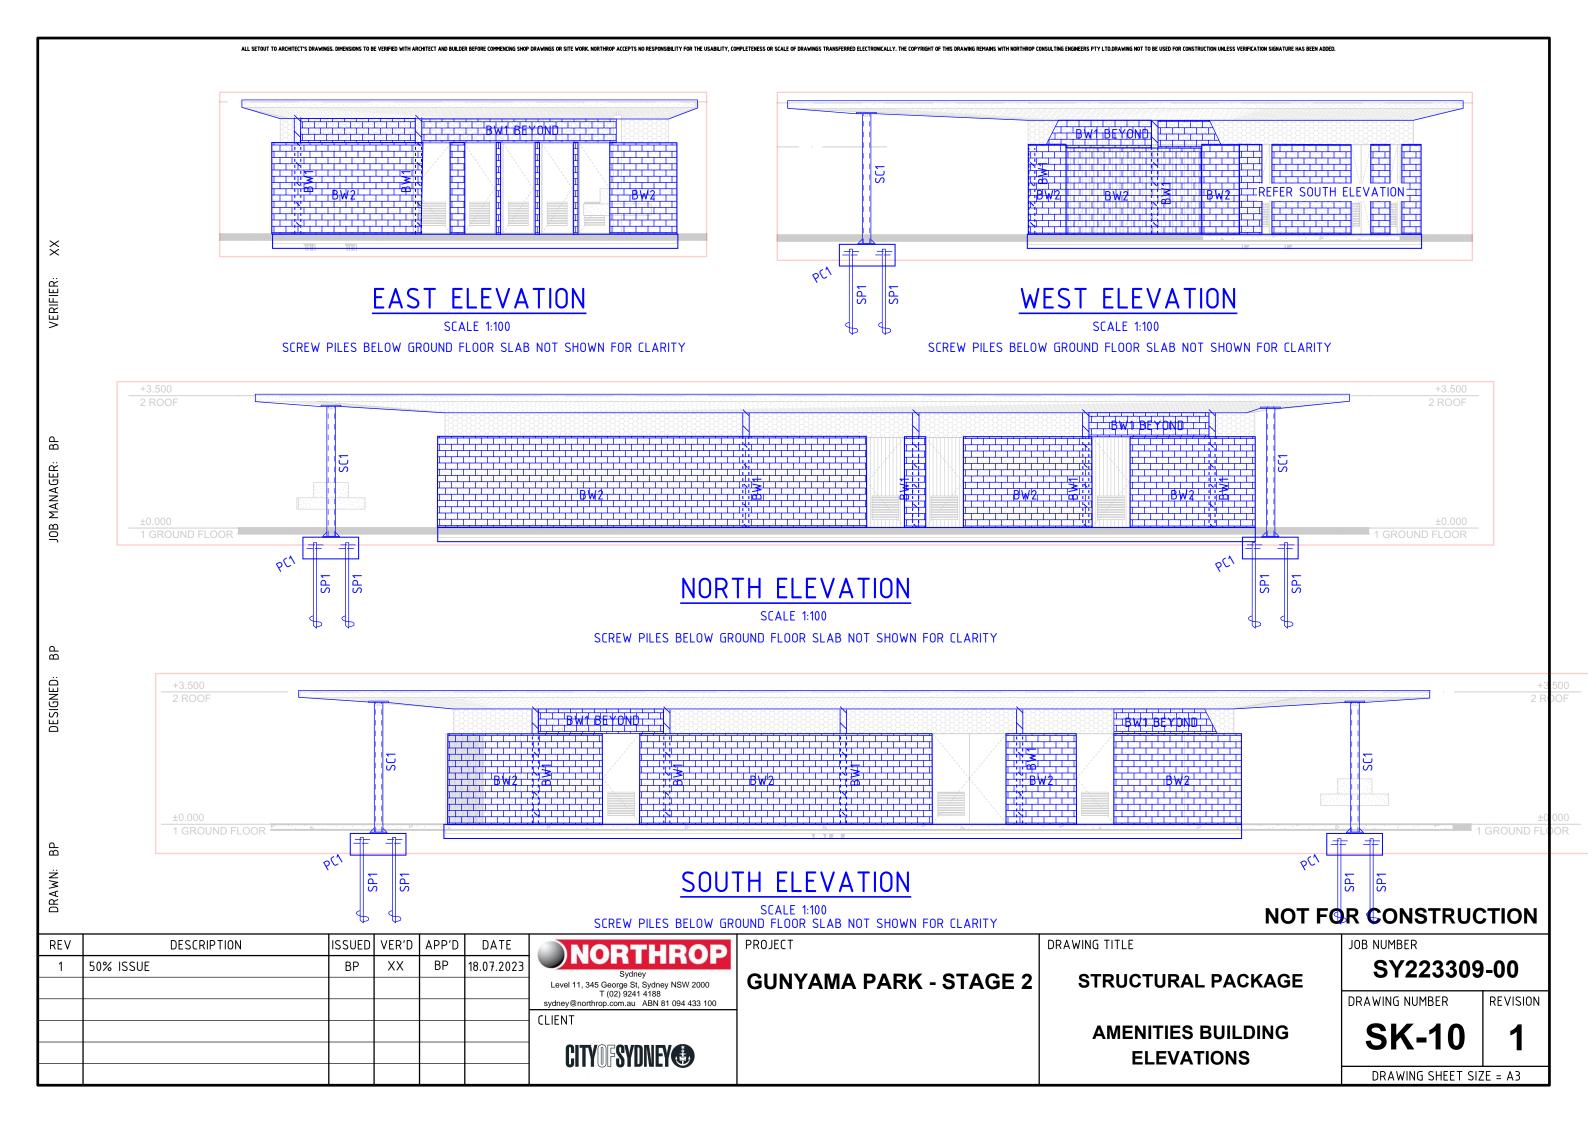



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VERIFIER:

DESIGNED:

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- GROUT FILL CORES IN MAX 1000 INCREMENTS

- CAST STARTER BARS INTO SLAB BELOW

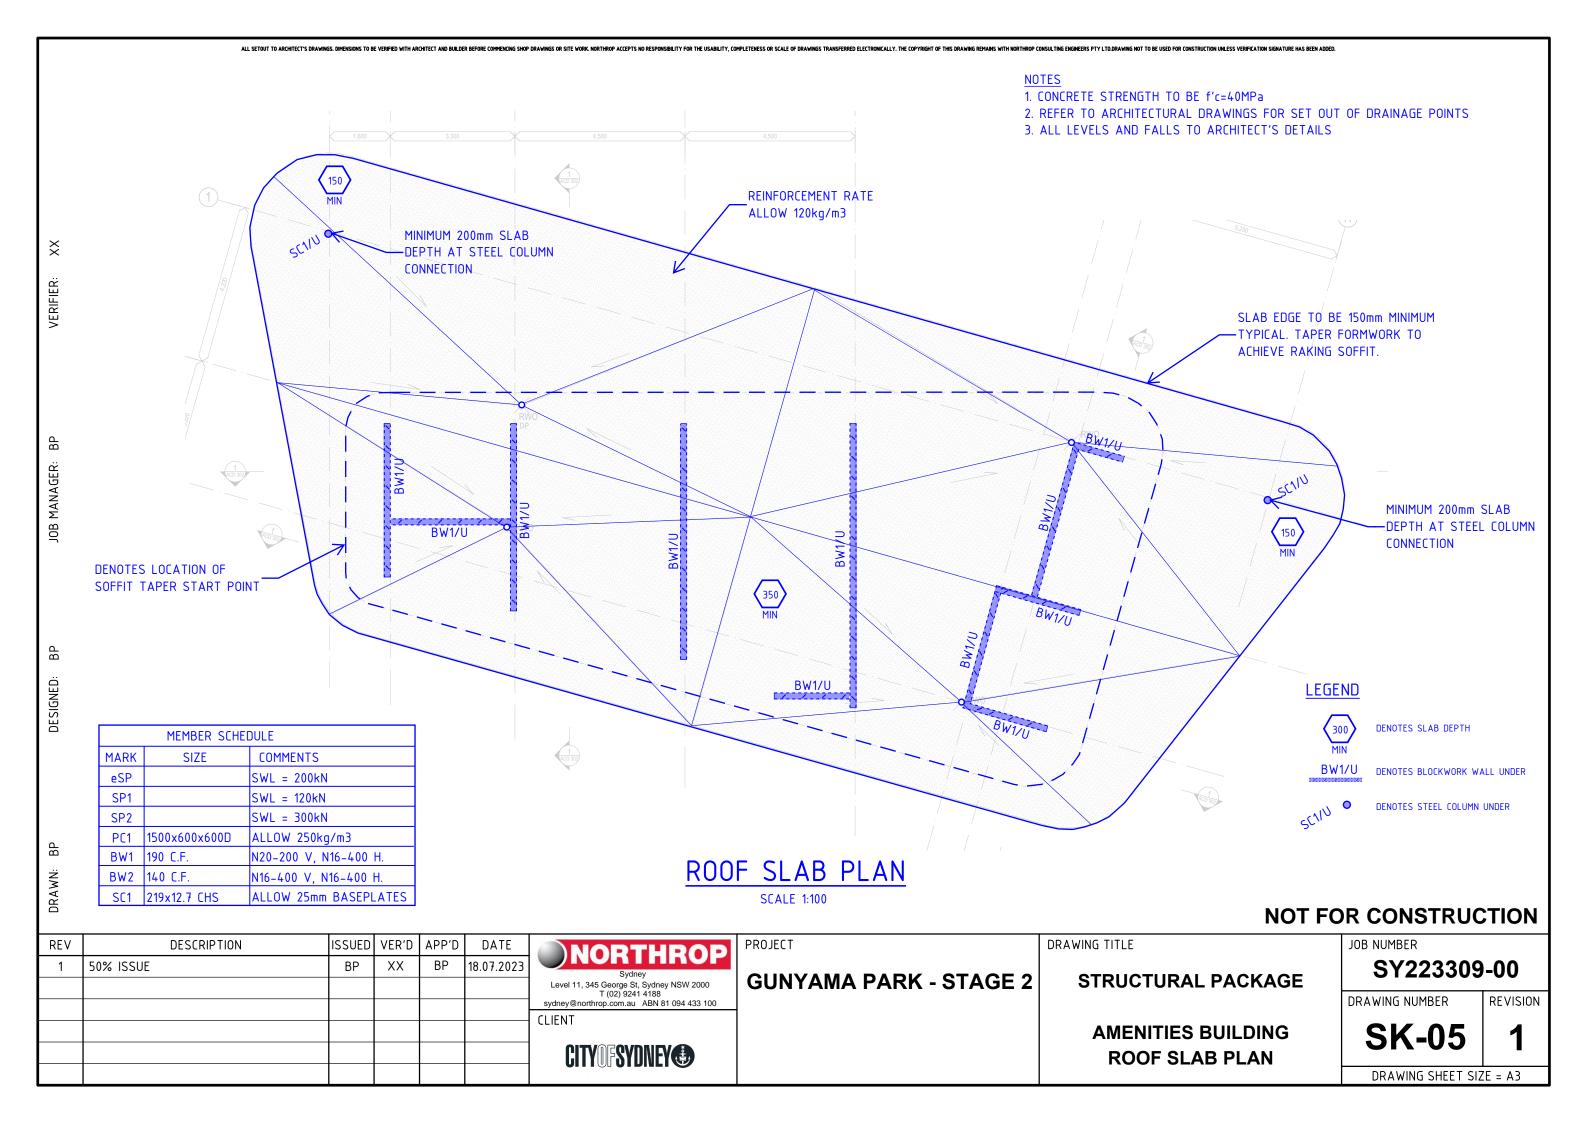
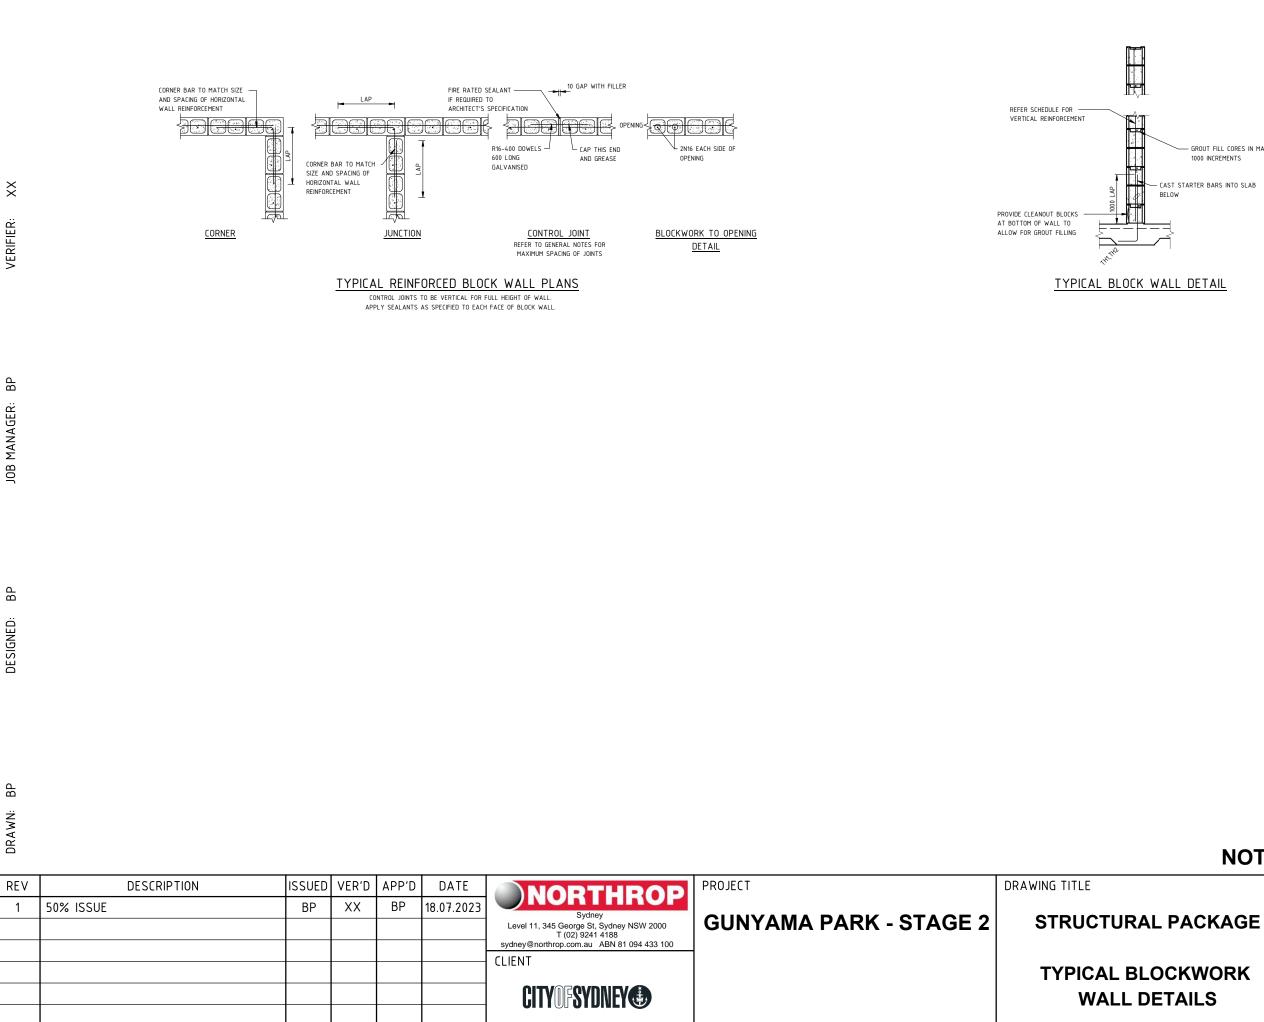
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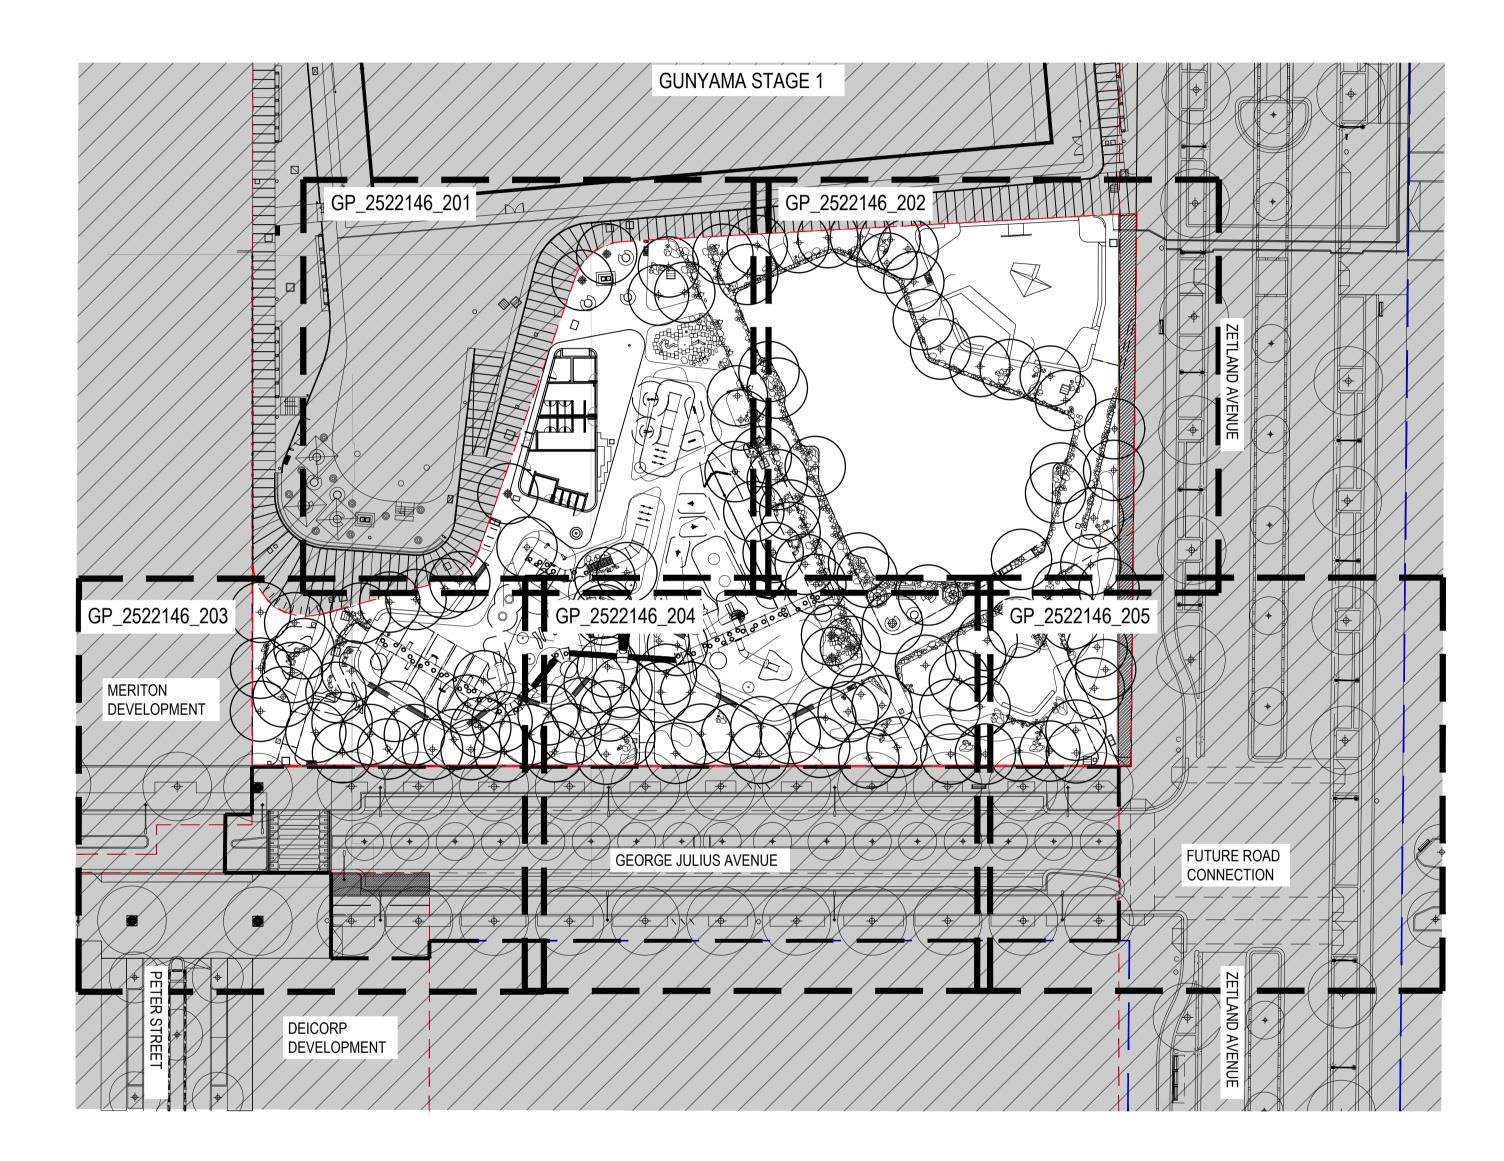
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DESIGN : BP DOCUMENT : RH PROJECT : 2522146

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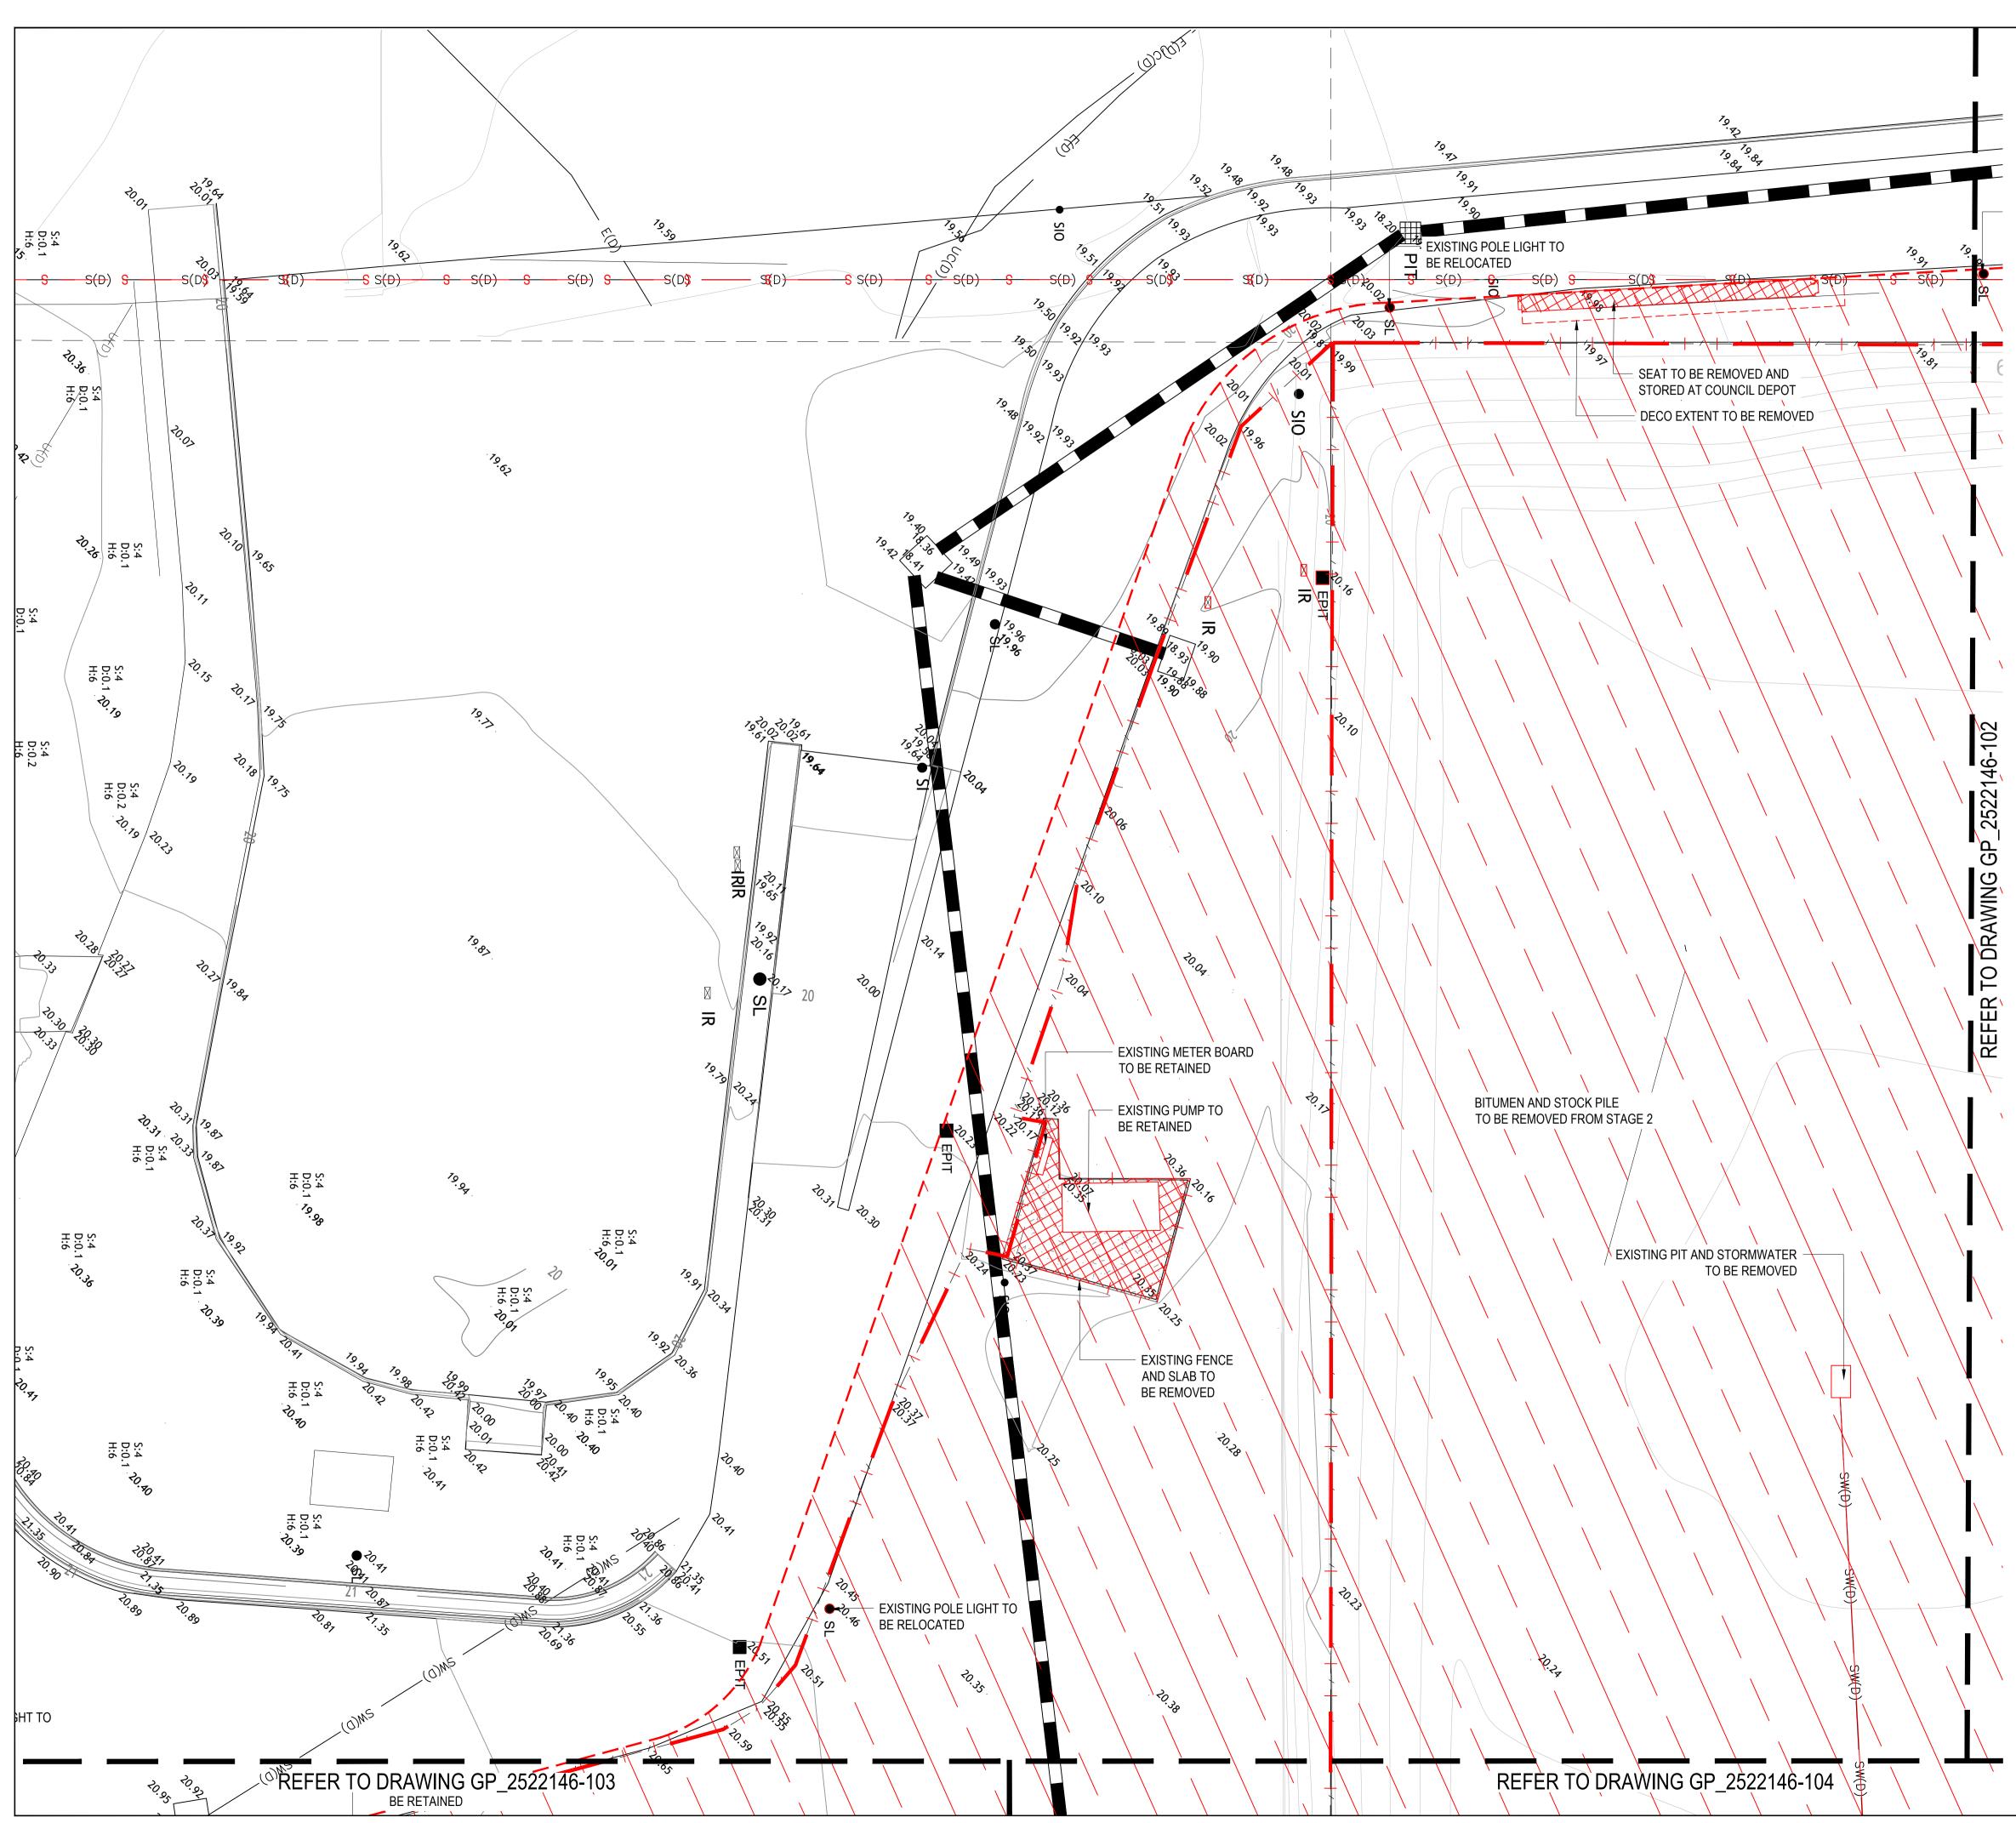
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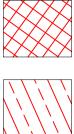
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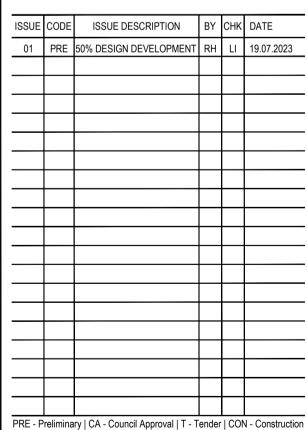
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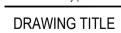
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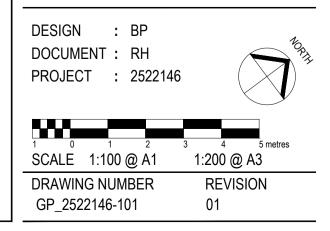
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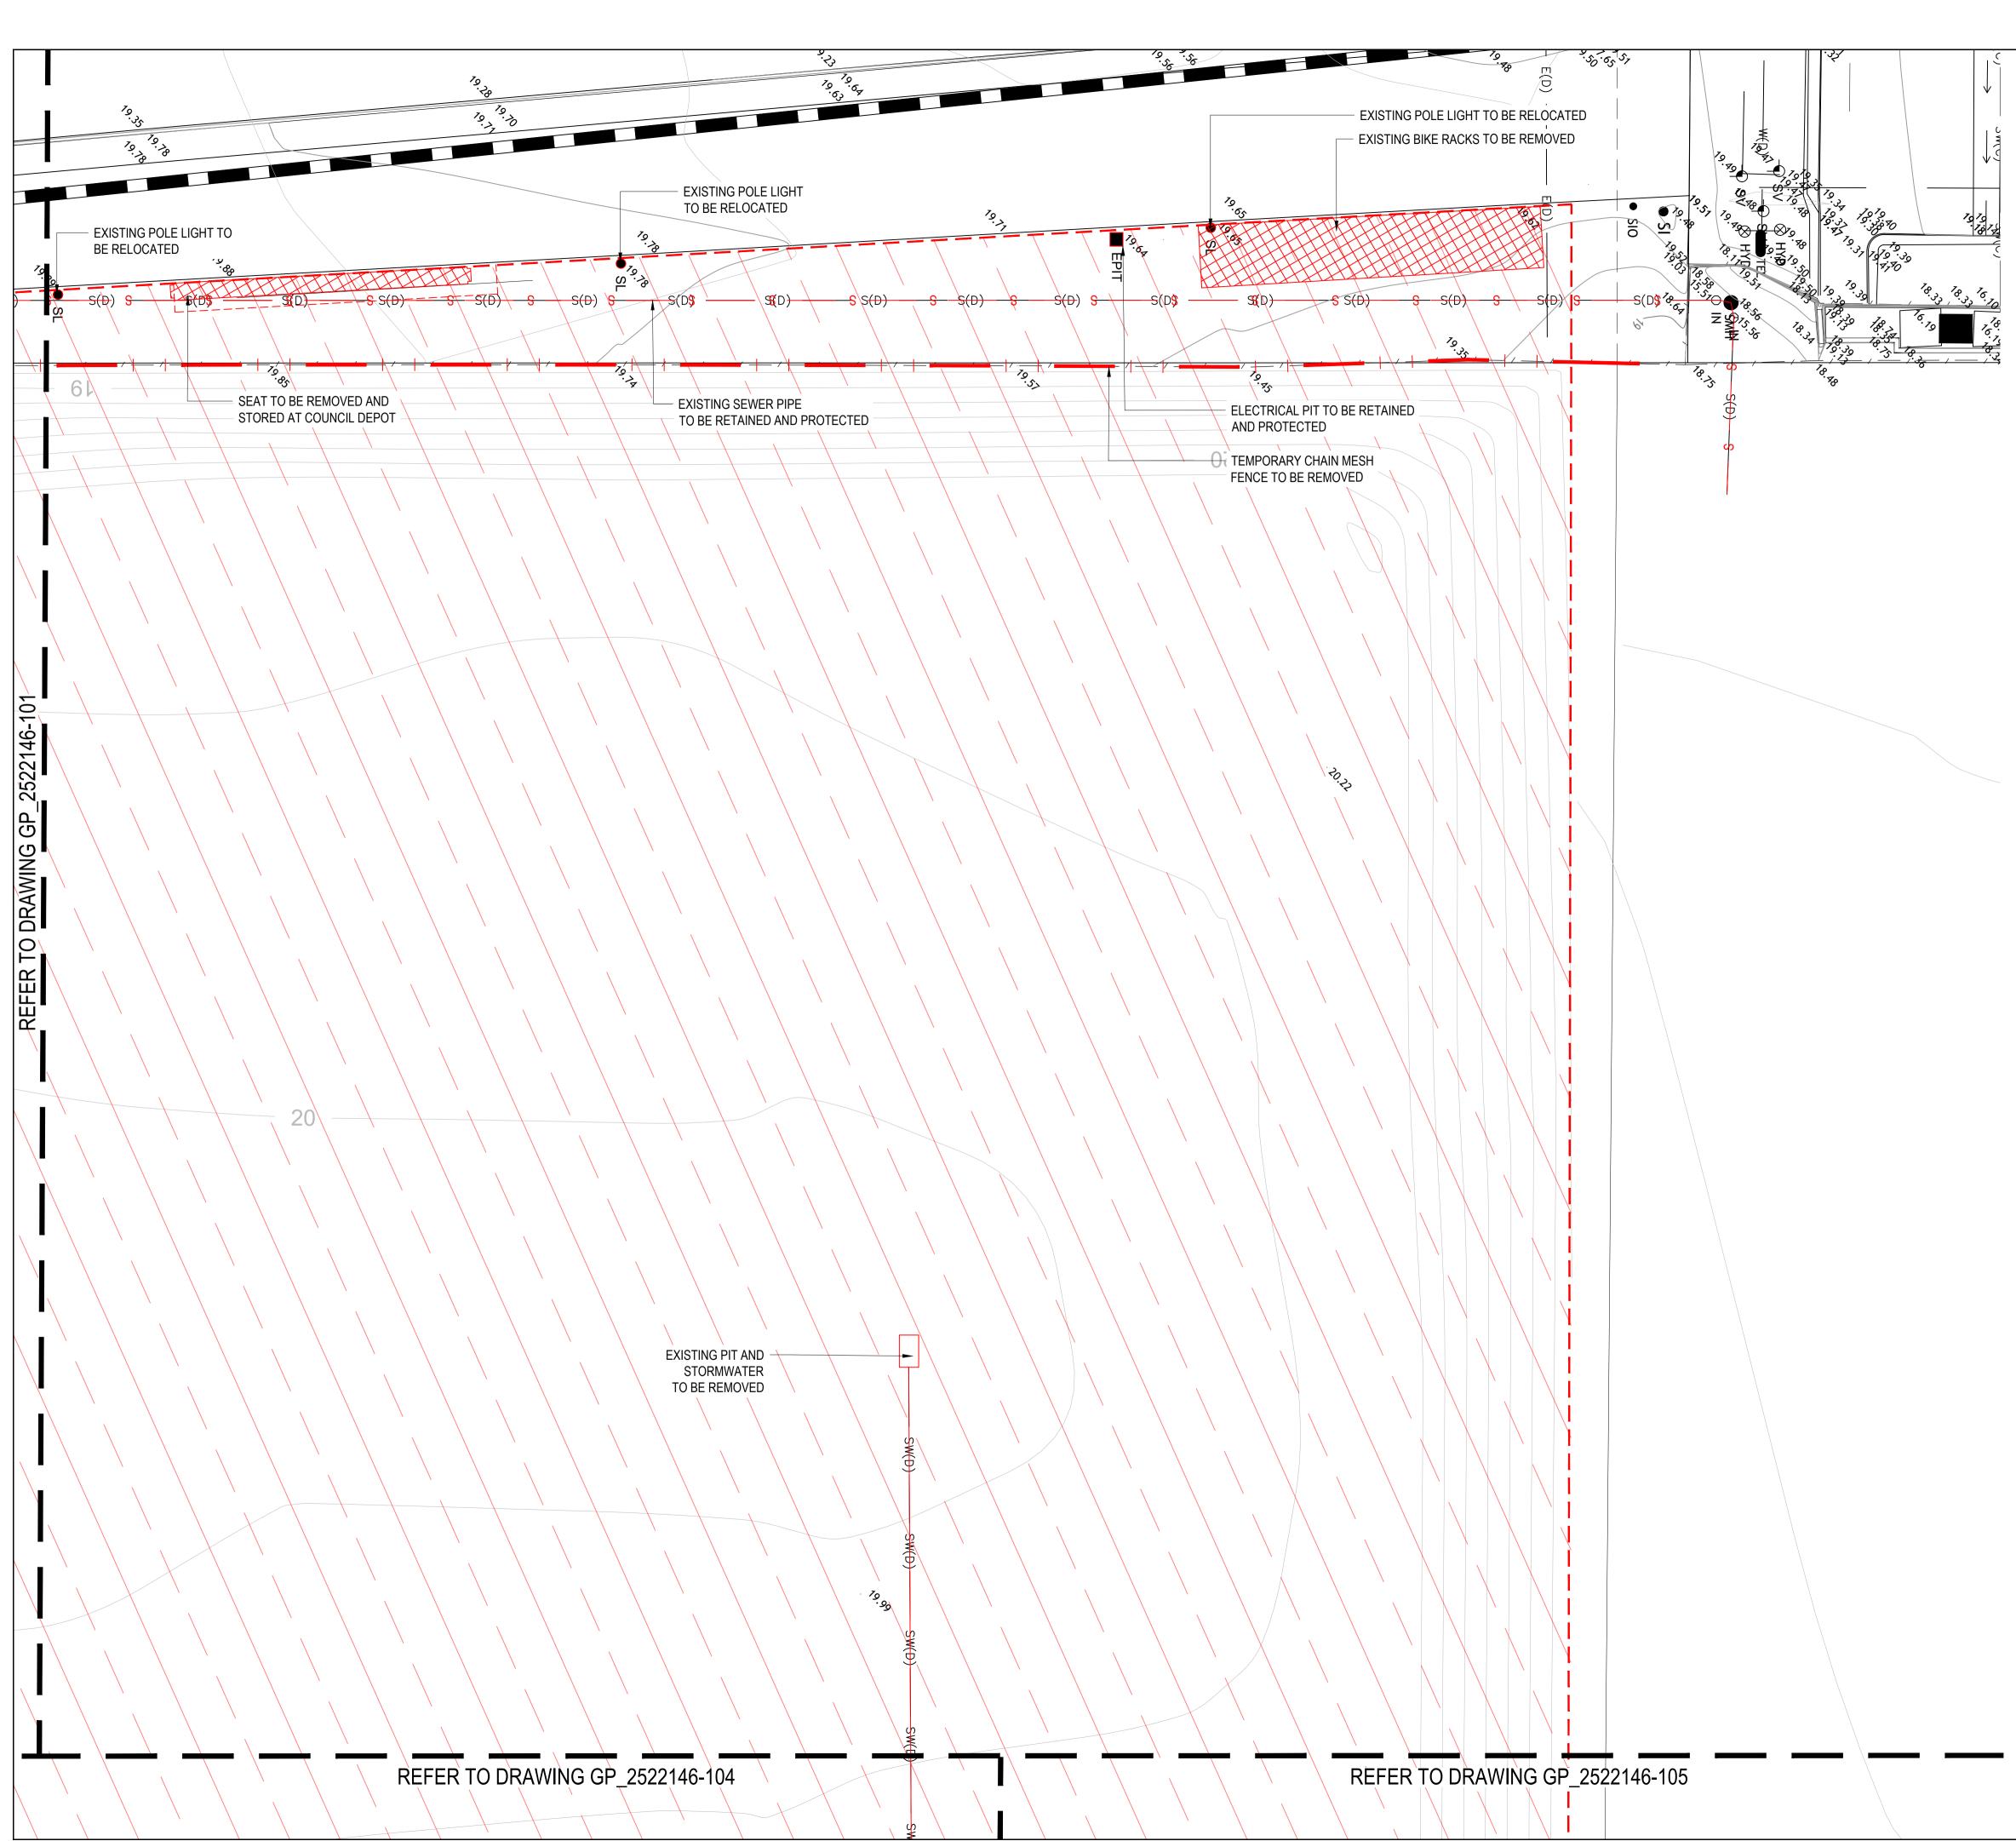
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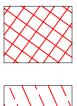












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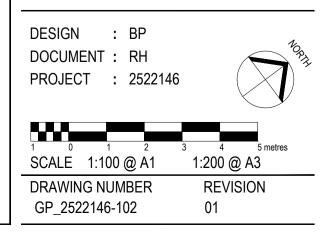
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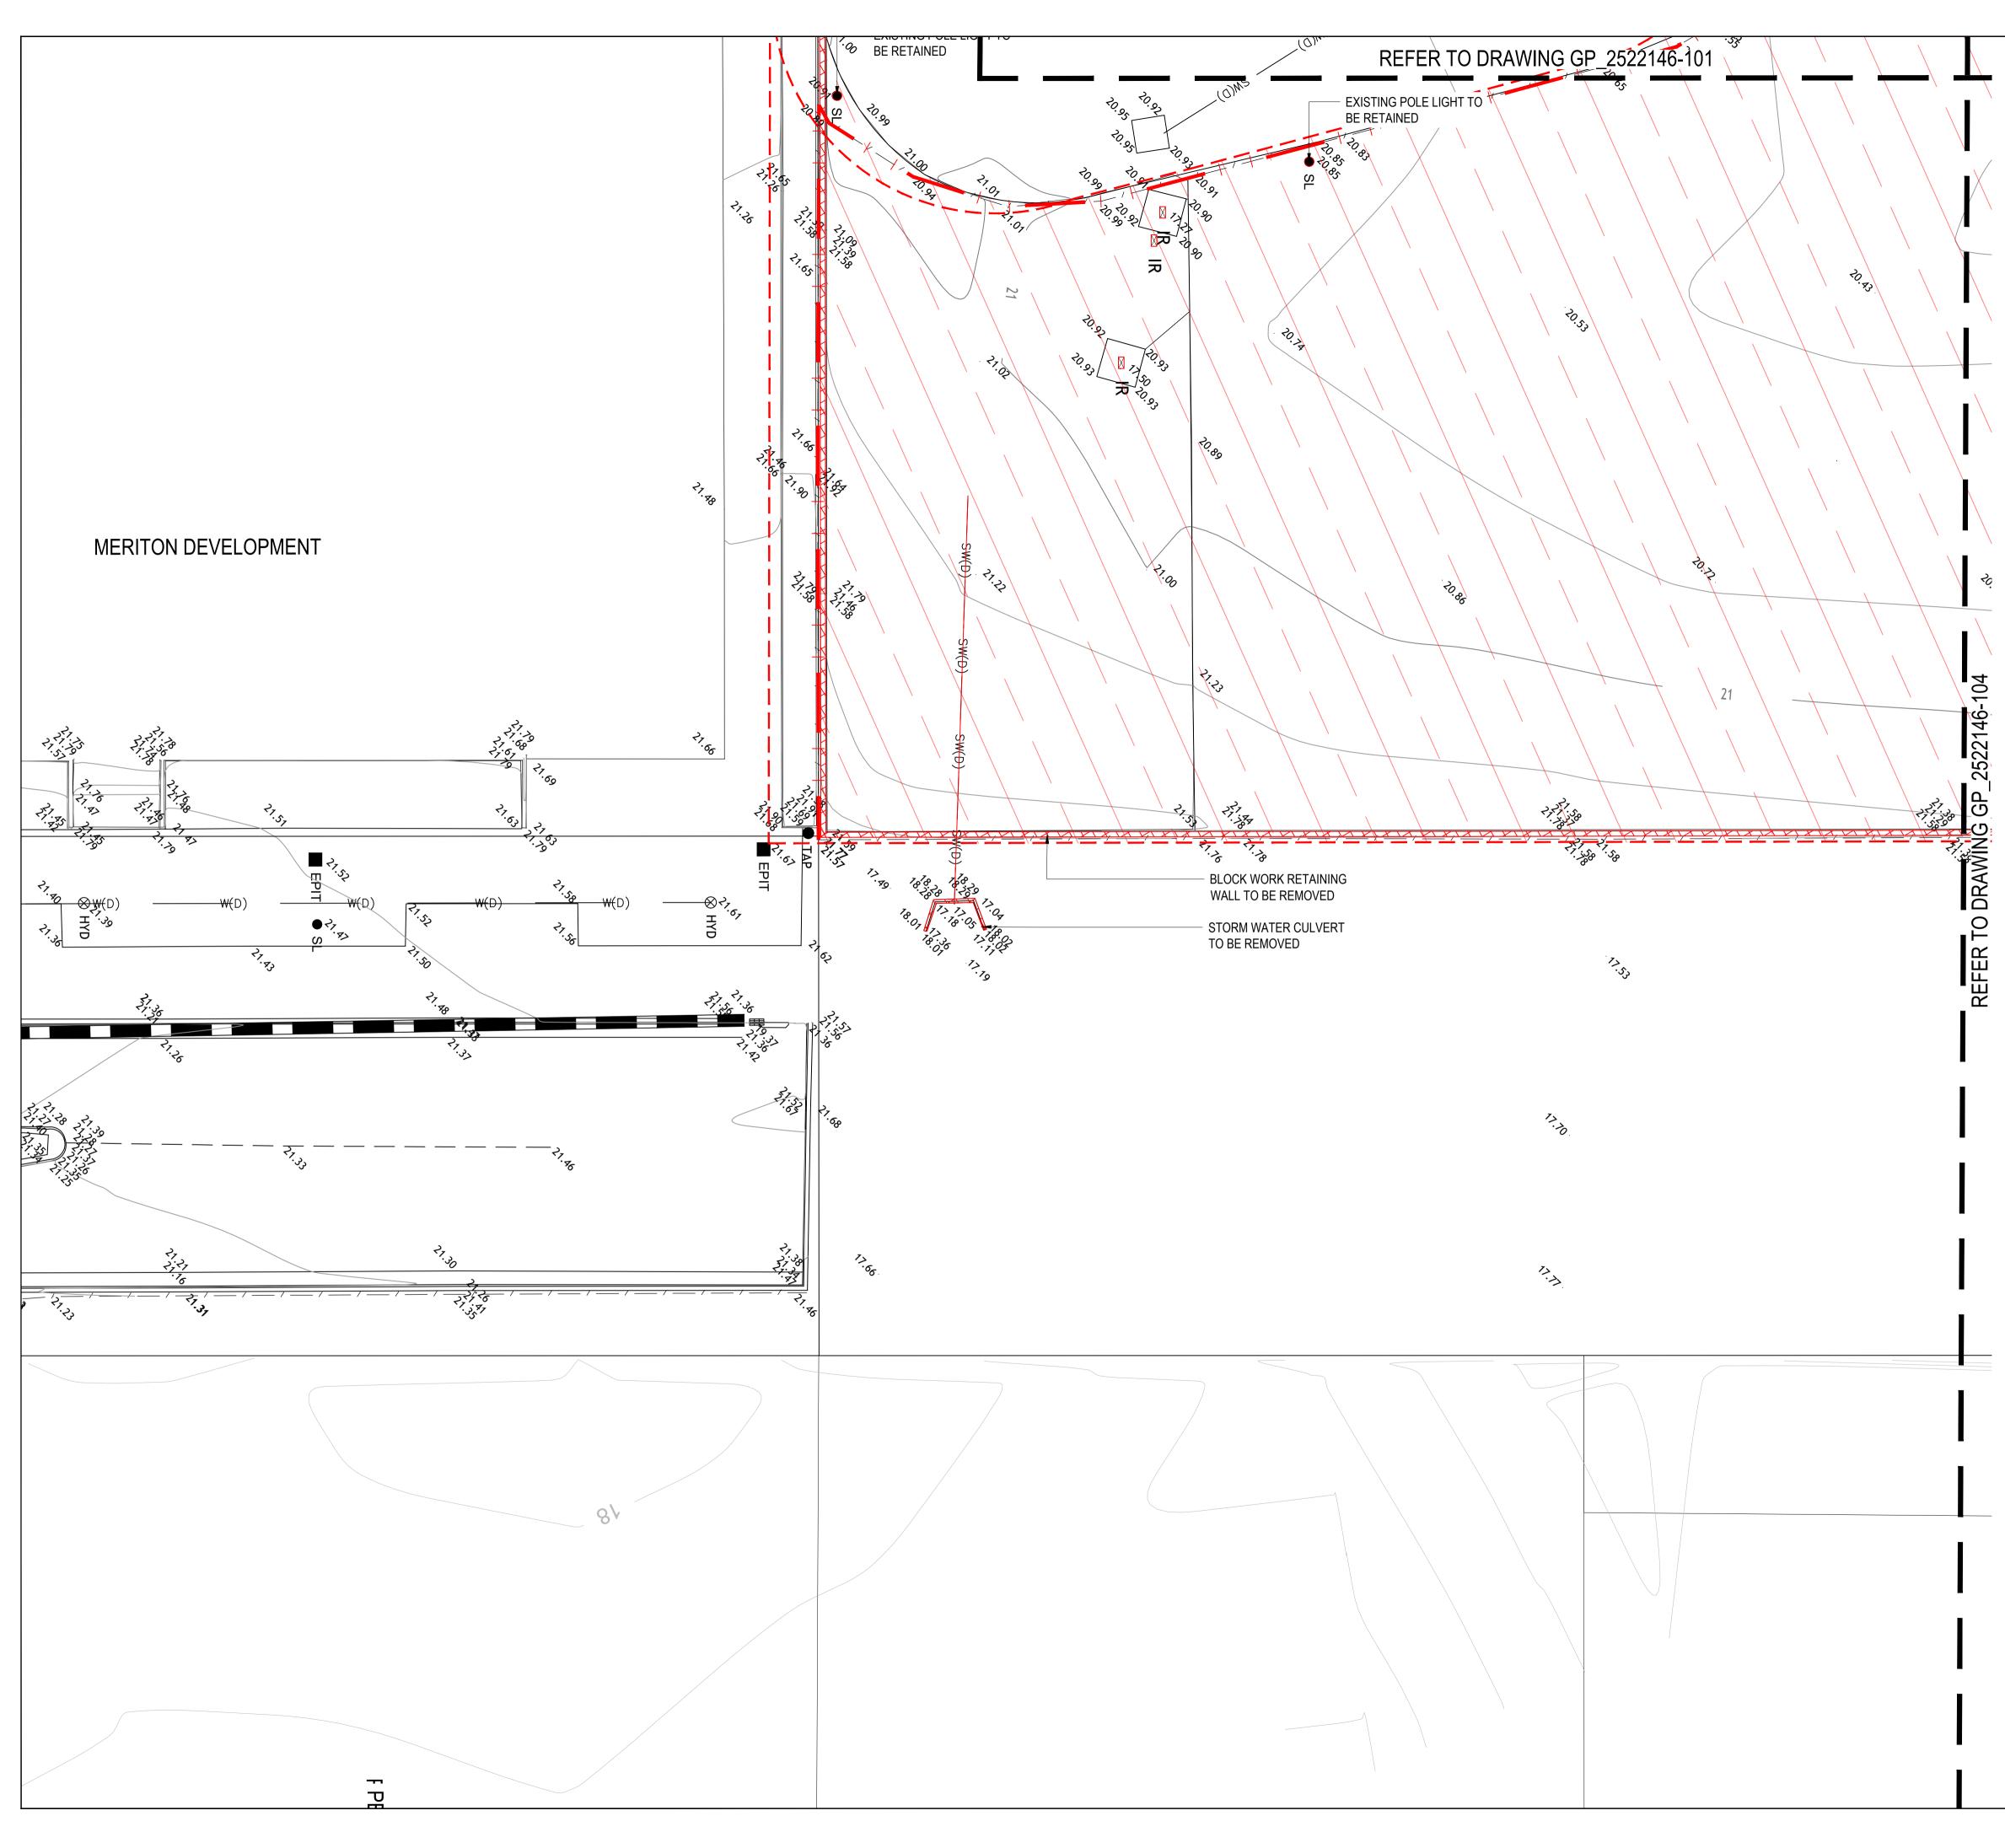
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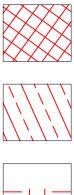
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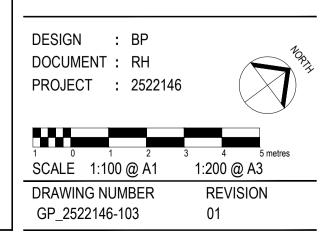
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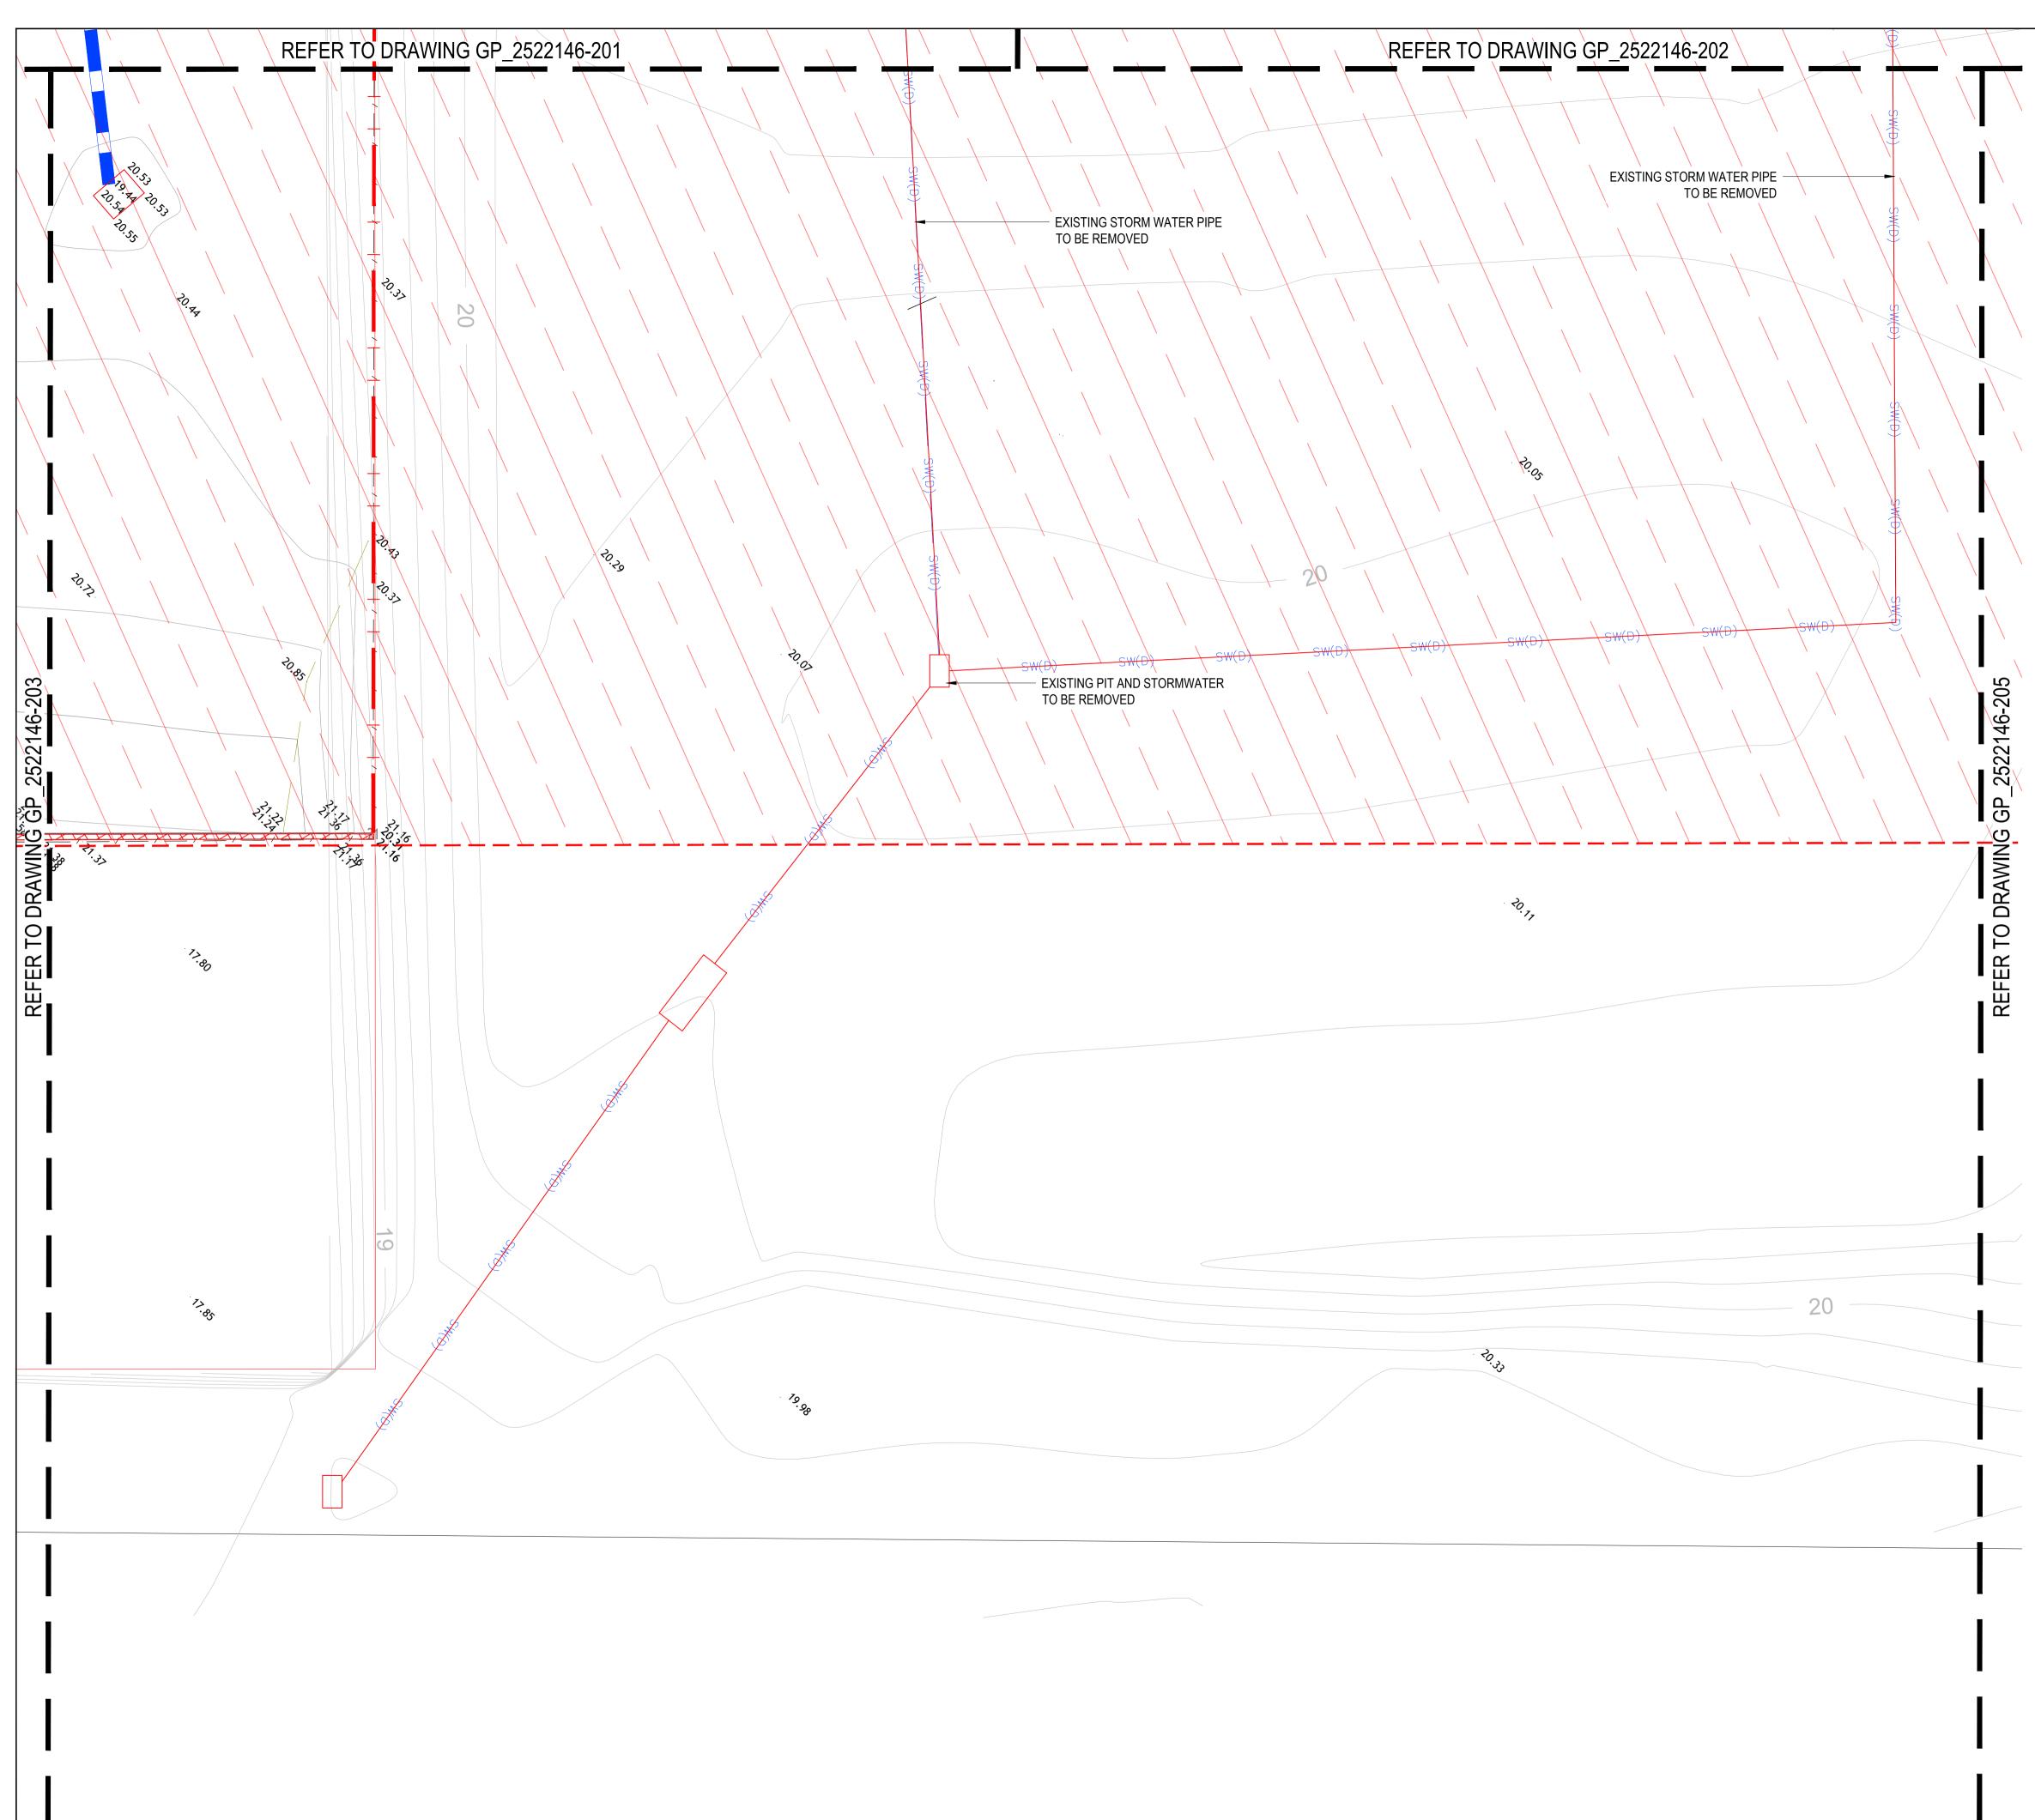
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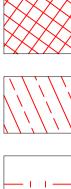
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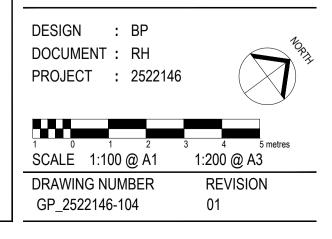
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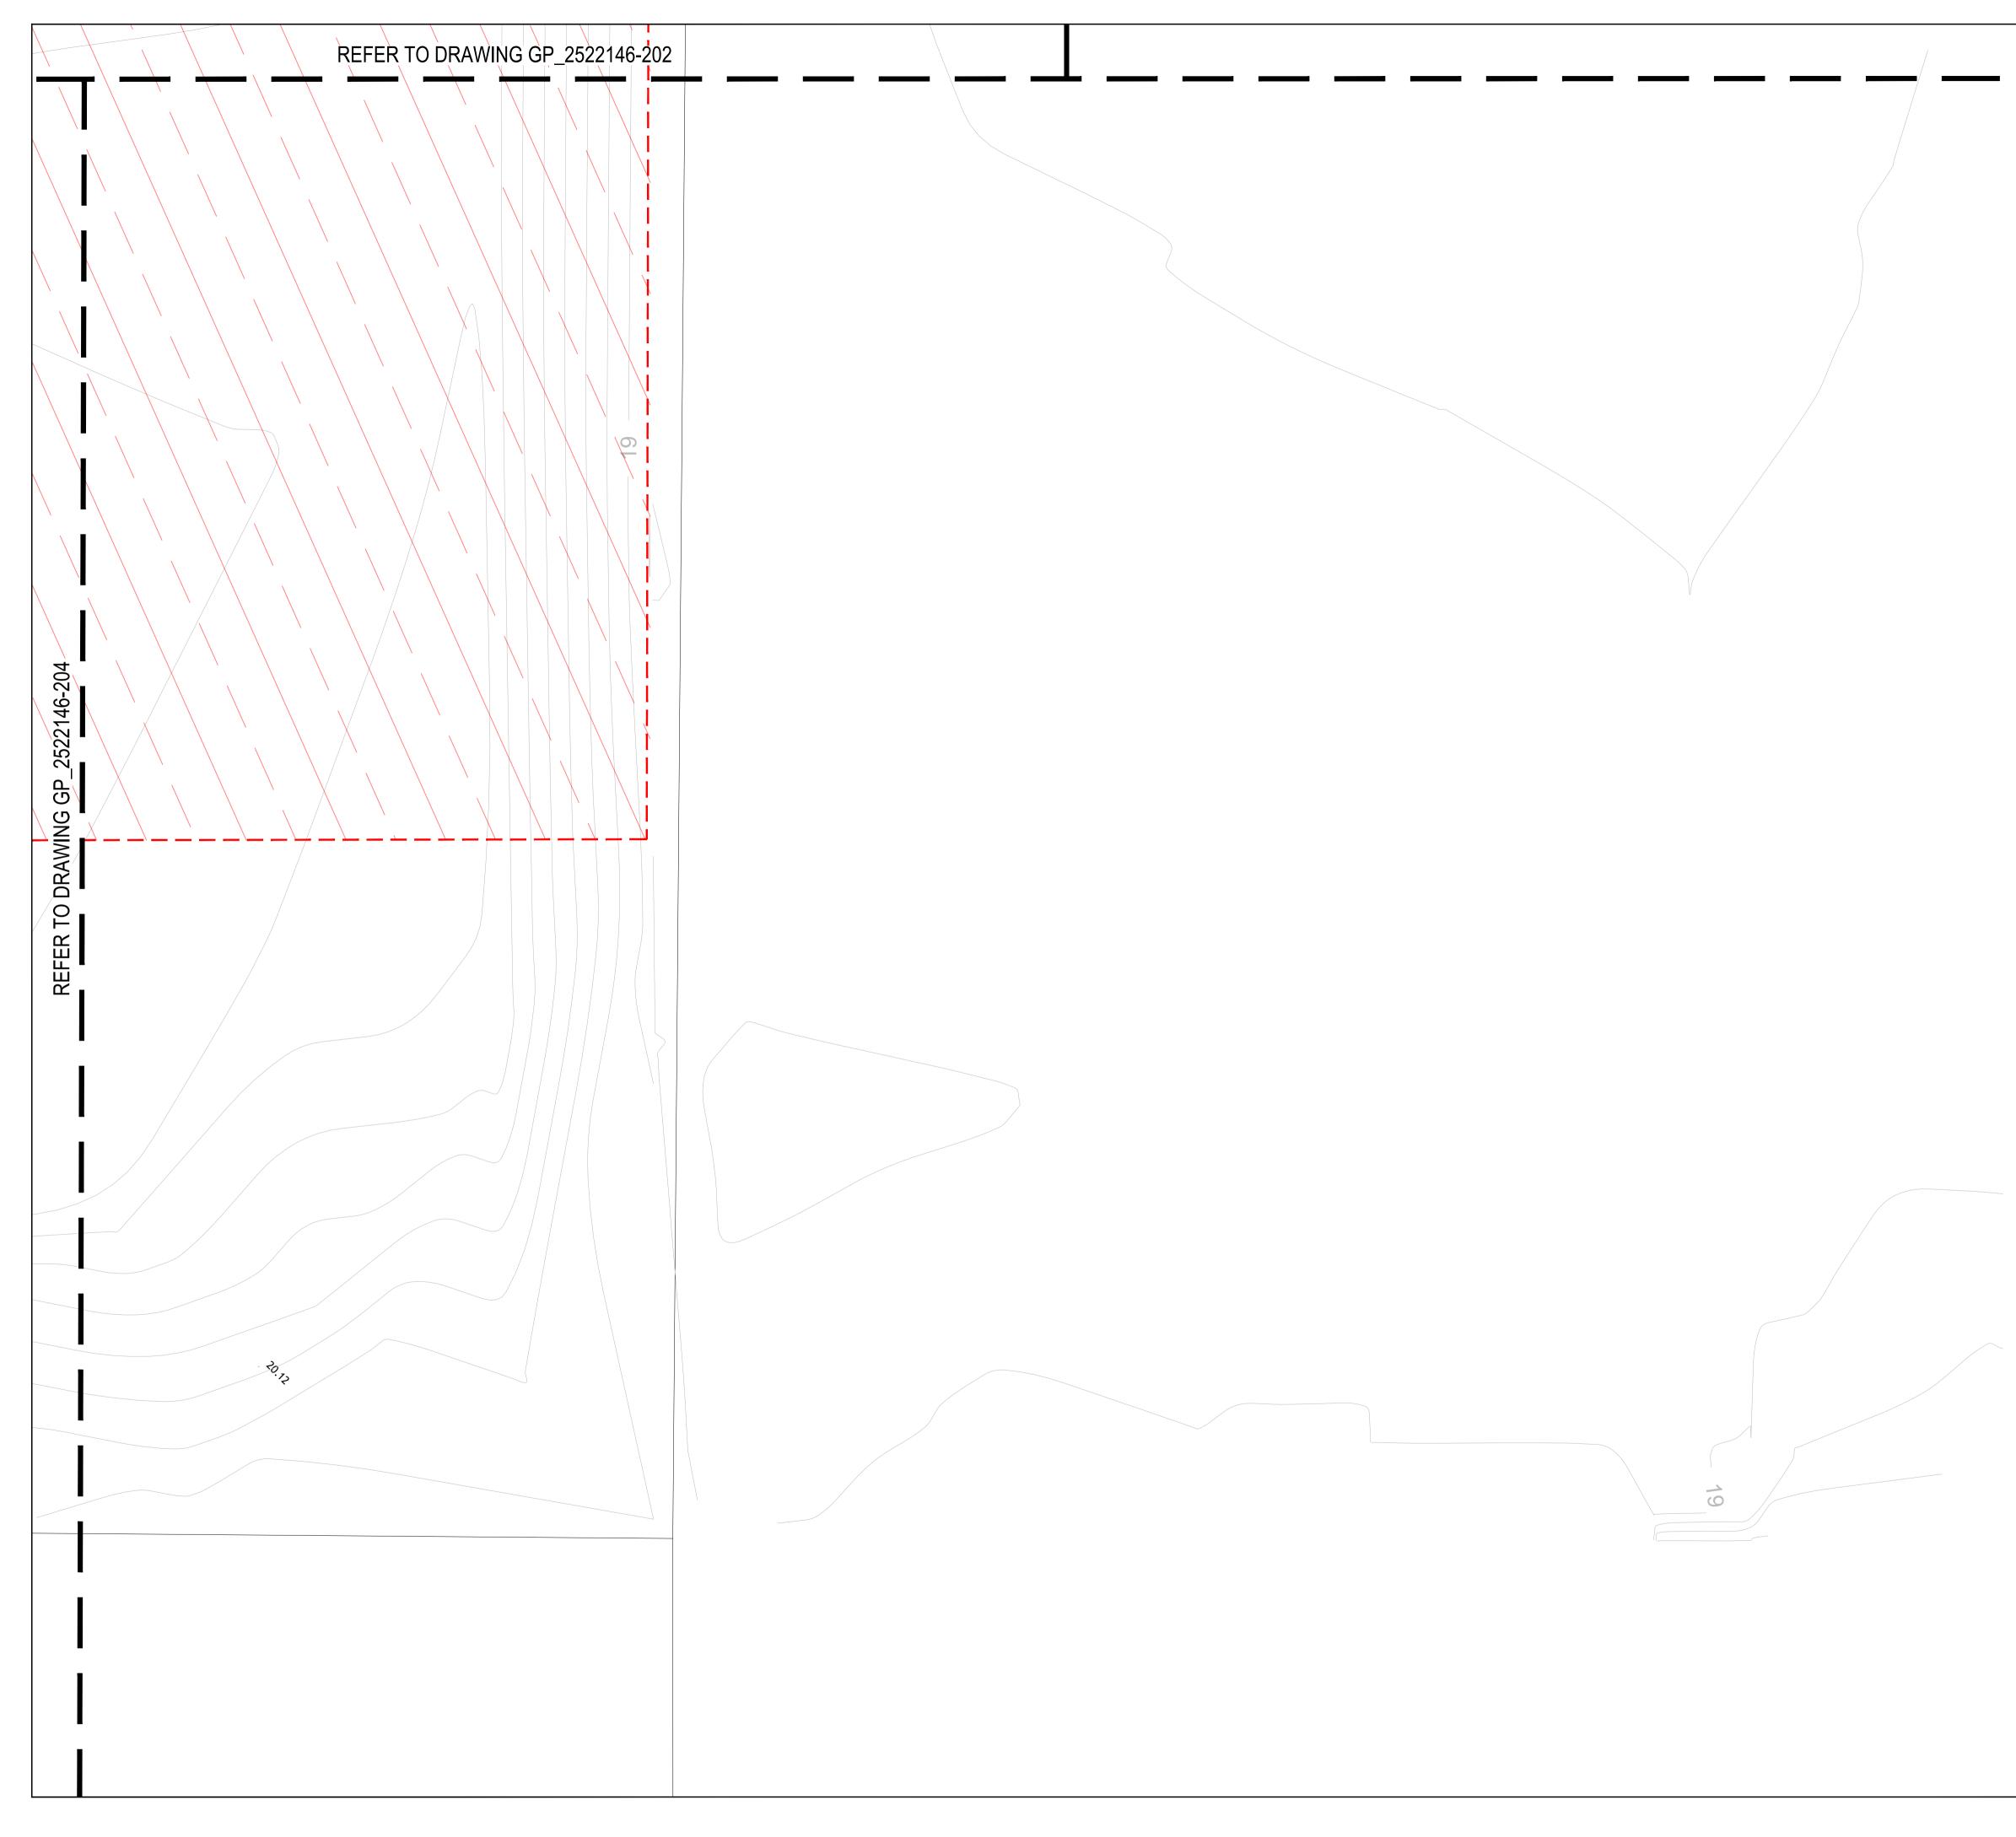
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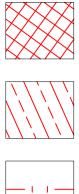
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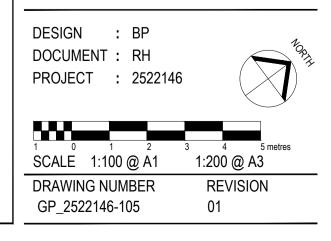
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PROJECT

GUNYAMA PARK STAGE 2

CLIENT

CITY OF SYDNEY

NOTES









SITE PLAN

GP_2522146-001

REVISION

01

DRAFT

19.07.2023

LEGEND SOFTWORKS - PLANTING HARDWORKS - FUTNITURE PROPOSED TREES REFER TO DETAIL #/###-# + F1 - DRINKING FOUNTAIN AND PLANTING PLAN REFER TO MATERIAL SCHEDULE **F** L_{F1} T1 - PROPOSED TURF REFER TO DETAIL #/###-# F2- BICYCLE RACK T1 AND MATERIALS SCHEDULE REFER TO MATERIAL SCHEDULE **----**^LF2 SL01 - GARDEN BED SANDSTONE MULCH $\left[+ \right]$ REFER TO DETAIL #/###-# F3- RECYCLE & REFUSE BIN × I SL01 AND MATERIALS SCHEDULE REFER TO MATERIAL SCHEDULE _(F3) SL02 - GARDEN BED ORGANIC MULCH REFER TO DETAIL #/###-# F4 - SHADE UMBRELLAS AND MATERIALS SCHEDULE REFER TO MATERIAL SCHEDULE F4 SL03 - RAIN GARDEN REFER TO DETAIL #/###-# CS1 - TIMBER SEAT WITH BACKREST SL03 AND MATERIALS SCHEDULE REFER TO DETAIL #/###-# AND MATERIAL SCHEDULE HARDWORKS - PAVING CS2 - CIRCULAR SEAT P1 - PAVING TYPE 1 - CONCRETE PAVING (TRAFFICABLE) REFER TO DETAIL #/###-# G CS2 AND MATERIAL SCHEDULE • (P1) REFER TO DETAIL #/###-# AND MATERIAL SCHEDULE · _____ CS3 - CONCRETE PRECAST MODULAR SEAT P2 - PAVING TYPE 2 - CONCRETE PAVING (TRAFFICABLE) (WITH TIMBER IN SELECTED LOCATIONS) **P2** REFER TO DETAIL #/###-# CS3 REFER TO DETAIL #/###-# AND MATERIAL SCHEDULE AND MATERIAL SCHEDULE CS4 - PICNIC BENCH SEAT WITH ROUND TABLE \bigcirc HHHH P3 - PAVING TYPE 3 - CONCRETE PAVERS REFER TO DETAIL #/###-# - P3 REFER TO DETAIL #/###-# CS4 AND MATERIAL SCHEDULE AND MATERIAL SCHEDULE CS5 - BLEACHER STYLE SEAT SIMILAR TO SWIM CENTRE P4 - PAVING TYPE 4 - SOFTFALL SAND REFER TO DETAIL #/###-# (P4) REFER TO DETAIL #/###-# CS5 AND MATERIAL SCHEDULE AND MATERIAL SCHEDULE P5 - PAVING TYPE 5 - SOFTFALL RUBBER COLOUR 01 _ _ _ HARDWORKS - FIXTURE ____P5___ REFER TO DETAIL #/###-# AND MATERIAL SCHEDULE _ _ _ FX01 - SIGN REFER TO ARCHITECTURAL DOCUMENTATION P6 - PAVING TYPE 6 - DECOMPOSED GRANITE **FX01** P6REFER TO DETAIL #/###-#AND MATERIAL SCHEDULE AND MATERIAL SCHEDULE FX02 - BBQ REFER TO MANUFACTURE'S DRWAINGS P7 - PAVING TYPE 7 - ROCK BALLAST AND MATERIAL SCHEDULE REFER TO DETAIL #/###-# AND MATERIAL SCHEDULE 11. 11. 11. 11. FX03 - TREE GRATE P8 - PAVING TYPE 8 - DECOMPOSED SANDSTONE REFER TO MANUFACTURE'S DRWAINGS • REFER TO DETAIL #/#### AND MATERIAL SCHEDULE FX03 AND MATERIAL SCHEDULE FX04 FX04- STANDARD PIT LID TIMBER DECK REFER TO CIVIL DOCUMENTATION TD REFER TO DETAIL #/###-# AND MATERIAL SCHEDULE FX05 FX05- HEELGUARD GRATED PIT HARDWORKS - EDGE AND FENCE REFER TO CIVIL DOCUMENTATION ED1 - EDGE TYPE 1 - STEEL EDGE ____ REFER TO DETAIL #/###-# FX06- STANDARD PIT LID ED1 AND MATERIAL SCHEDULE FX06 REFER TO CIVIL AND ELECTRICAL DOCUMENTATION Ċ INSITU RETAINING WALL REFER TO DETAIL W01 AND MATERIAL SCHEDULE FX07- INFILL PIT LID REFER TO CIVIL DOCUMENTATION **FX07** SANDSTONE PAVED EDGING REFER TO MATERIAL SCHEDULE HARDWORKS - LIGHTING STEPPING STONES/ BOULDERS REFER TO MATERIAL SCHEDULE LP - PATH LIGHTING **REFER TO LIGHTING & ELECTRICAL DOCUMENTATION** LP



FN01 - LOW GARDEN FENCE REFER TO MATERIAL SCHEDULE

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PROJECT

GUNYAMA PARK STAGE 2

CLIENT

CITY OF SYDNEY

NOTES

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ISSUE	CODE	ISSUE DESCRIPTION	BY	СНК	DATE
01	PRE	50% DESIGN DEVELOPMENT	RH	LI	19.07.2023
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DRAWING TITLE

LEGEND



NOT TO SCALE	
DRAWING NUMBER	REVISION
GP_2522146-002	01



REFER TO LEGEND GP_2522146_002

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PROJECT


GUNYAMA PARK STAGE 2

CLIENT

CITY OF SYDNEY

NOTES



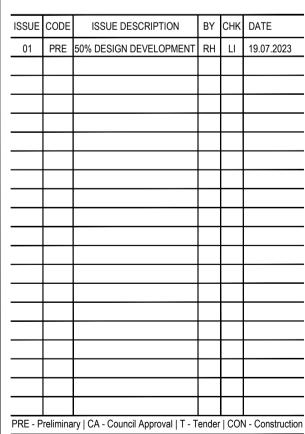

GENERAL ARRANGEMENT

PLAN

DRAWING TITLE

DESIGN : BP

DOCUMENT : RH

DRAWING NUMBER

GP_2522146-201

PROJECT : 2522146

SCALE 1:100 @ A1 1:200 @ A3


REVISION

01







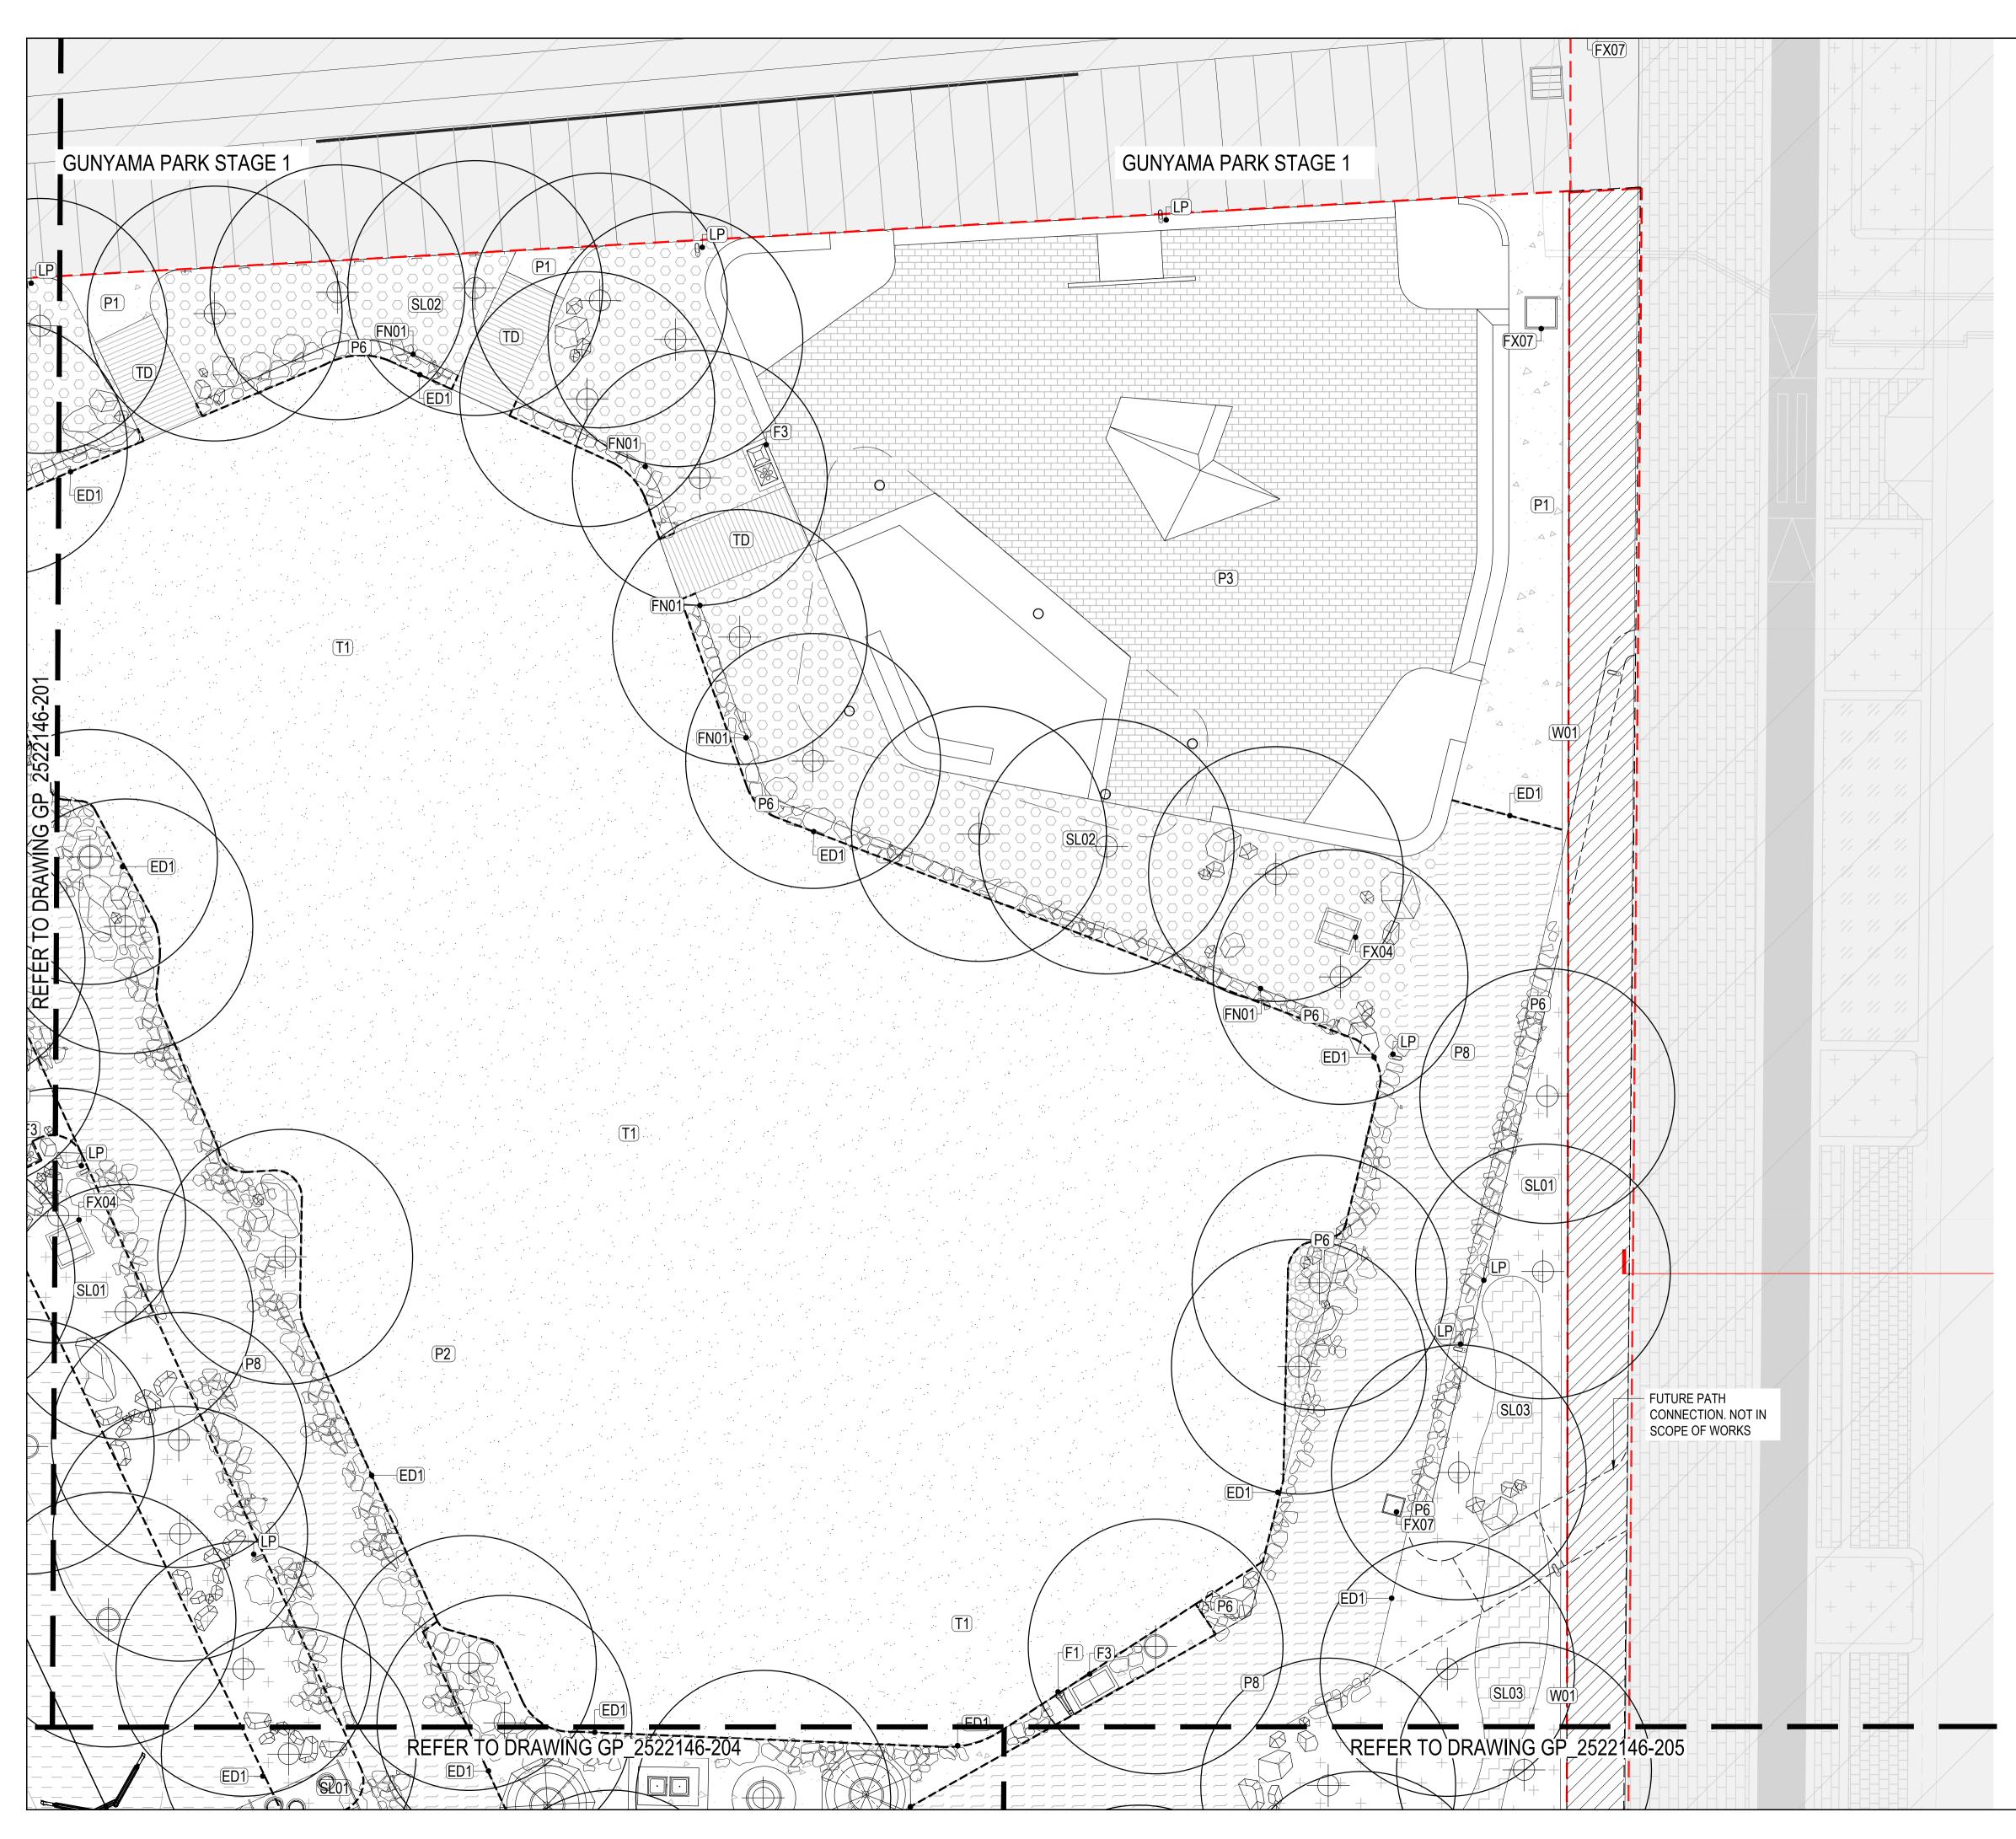

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PROJECT

GUNYAMA PARK STAGE 2


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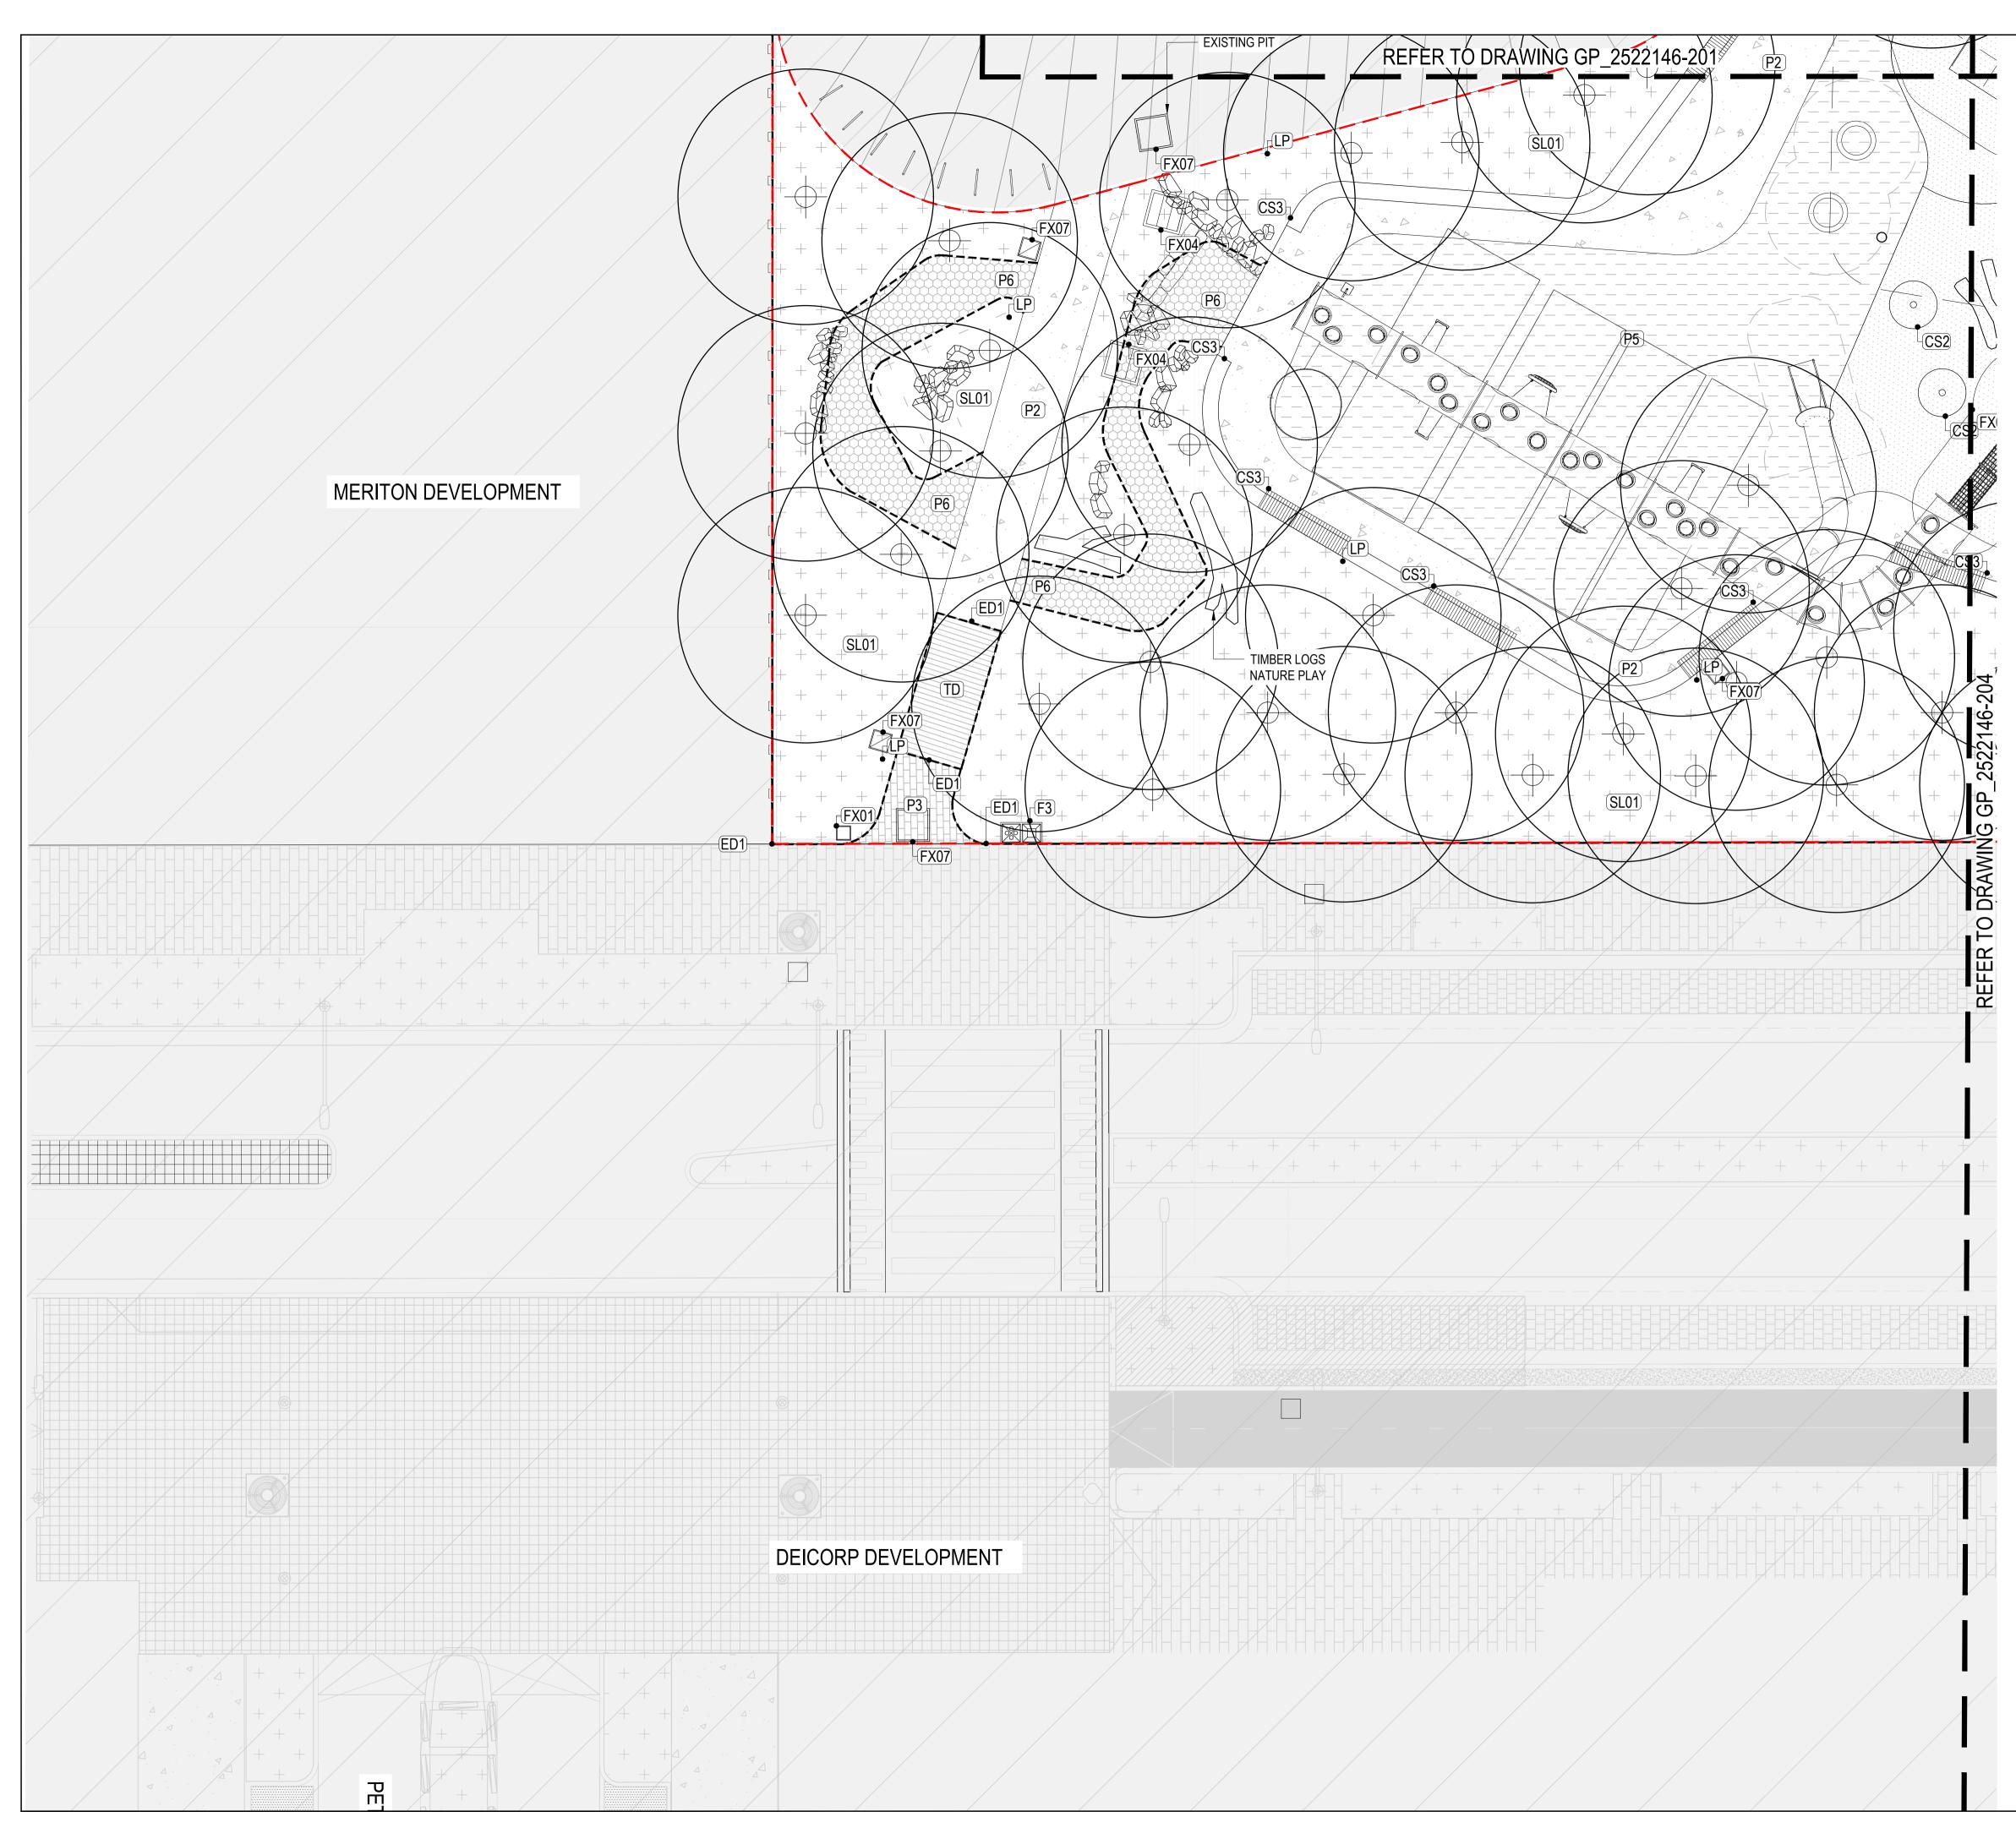
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ISSUE	CODE	ISSUE DESCRIPTION	BY	снк	DATE
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GUNYAMA PARK STAGE 2

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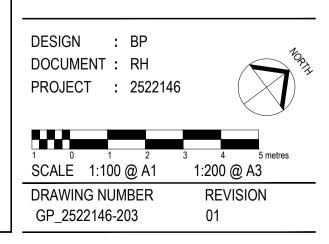
CITY OF SYDNEY


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ISSUE	CODE	ISSUE DESCRIPTION	BY	СНК	DATE
01	PRE	50% DESIGN DEVELOPMENT	RH	LI	19.07.2023
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DRAWING TITLE



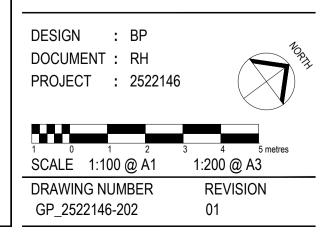

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PROJECT

GUNYAMA PARK STAGE 2
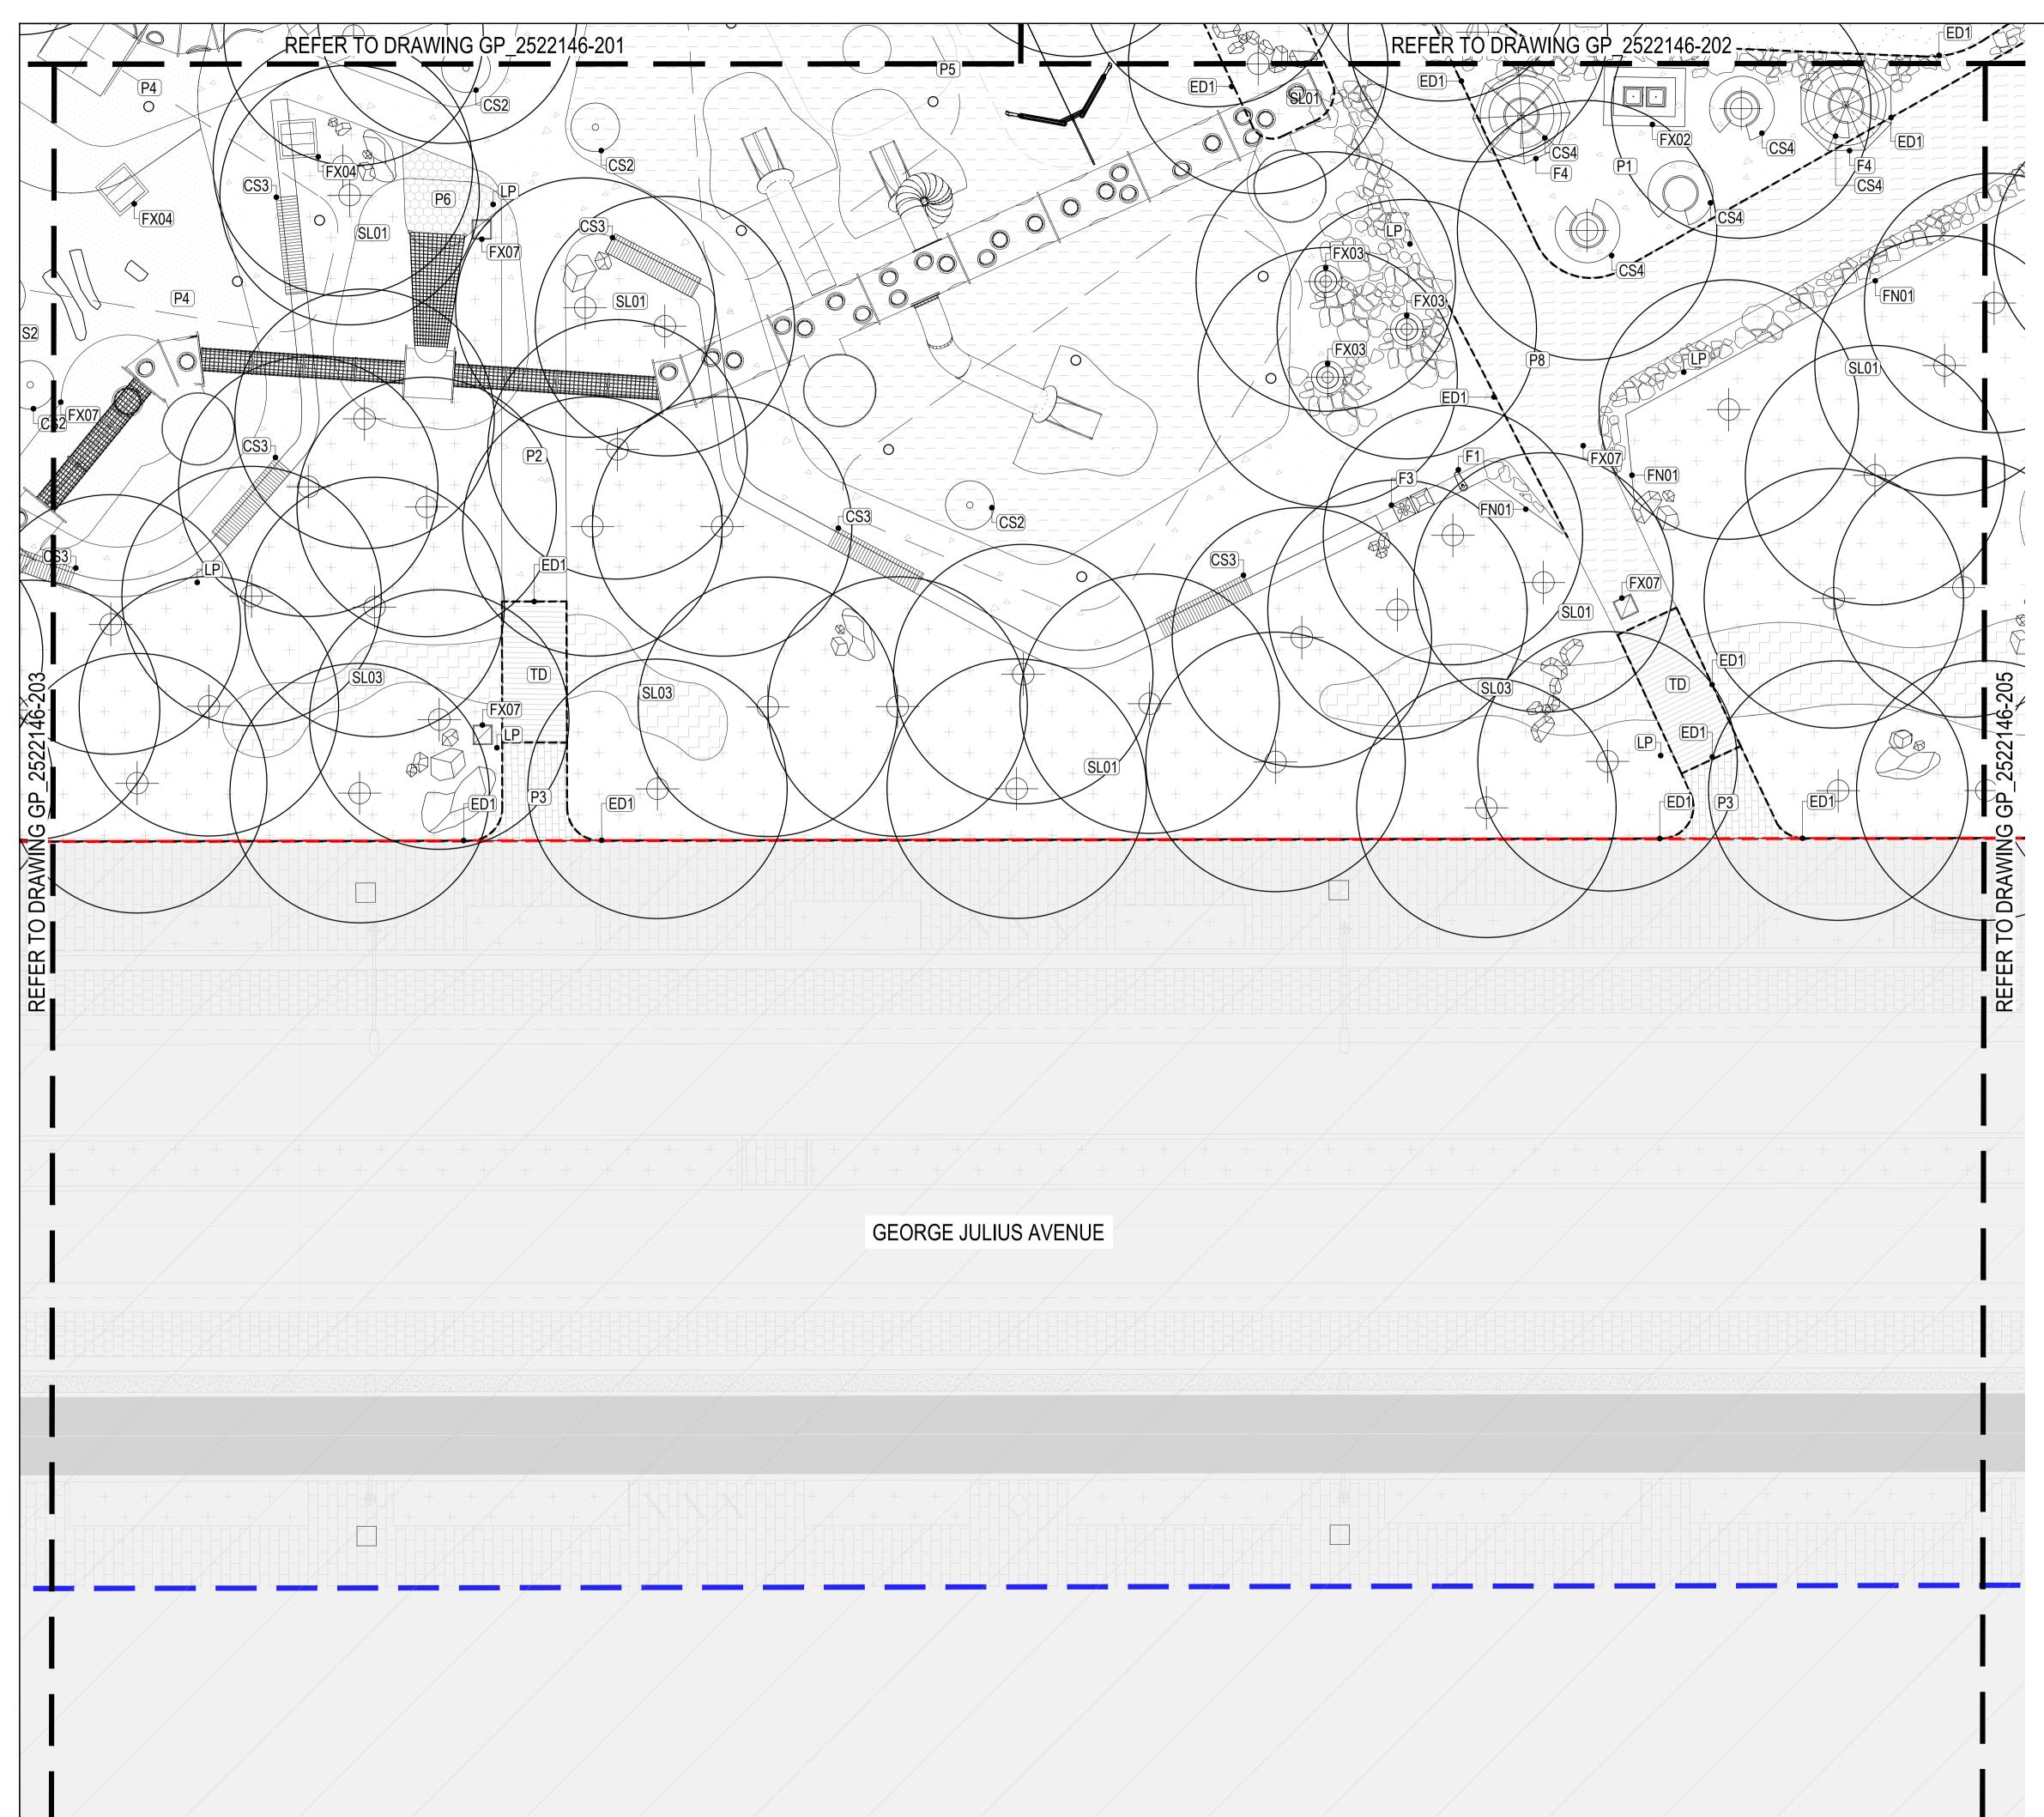
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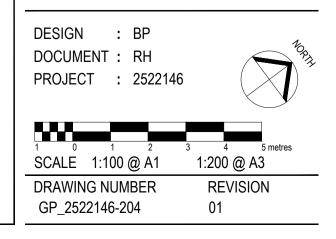
CITY OF SYDNEY

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ISSUE	CODE	ISSUE DESCRIPTION	BY	СНК	DATE
01	PRE	50% DESIGN DEVELOPMENT	RH	LI	19.07.2023
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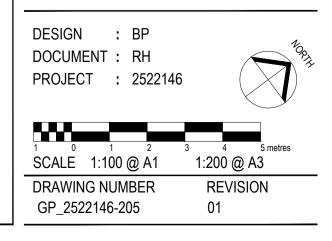
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ISSUE	CODE	ISSUE DESCRIPTION	BY	СНК	DATE
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+ _IL 00.000_	IL - INVERT LEVEL
+ <u>TB 00.000</u>	TB - TOP OF BATTER
+ <u>BB 00.000</u>	BB - BOTTOM OF BATTER
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⊕	SURFACE FLOOR DRAIN
	DRY CREEK/ DECKING/ SOFTFALL DRAIN
	VEHICLE ROAD DRAIN
\bigcirc	WATER BODY DRAIN
\boxtimes	WATER POINT
	STRIP DRAINS
	GRAVEL AG DRAINS
	PERFORATED UPVC AG DRAIN WITH FILTER FABRIC SLEEVE, CONNECT PIPE TO SW SYSTEM UPVC
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ô.ô	EXISTING CONTOUR LINES
	PROPOSED CONTOUR LINES
	RIDGE LINES
$- \leftarrow -$	SWALES
) SURFACE SLAB LEVEL AS PER THE RAL / ENGINEERS DRAWINGS.

FL WHERE SHOWN ON LANDSCAPE DRAWINGS REFERS TO FINISHED FLOOR LEVEL.

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GUNYAMA PARK STAGE 2


CLIENT

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NOTES



ISSUE	CODE	ISSUE DESCRIPTION	BY	СНК	DATE
01	PRE	50% DESIGN DEVELOPMENT	RH	LI	19.07.2023
PRE - P	relimina	rry CA - Council Approval T - T	ender		I - Construction
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+ FFL 00.000 + RL 00.000	FFL - FINISHED INTERNAL FLOOR LEVEL
+ EL 00.000	
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+ GL 00.000	SL - SLAB / PODIUM LEVEL GL - FINISHED GARDEN LEVEL
+ WL 00.000	WL - WATER LEVEL
+ BL 00.000	BL - BASE OF WATER FEATURE / POOL LEVEL
+ TW 00.000	TW - TOP OF WALL LEVEL
+ BK 00.000	BK - BACK OF KERB LEVEL
+ SD 00.000	SD - SURFACE DRAIN LEVEL
+∕_ <u>IL 00.000</u>	IL - INVERT LEVEL
+ <u>TB 00.000</u>	TB - TOP OF BATTER
* BB 00.000	BB - BOTTOM OF BATTER
+	SOFTSCAPE DRAIN
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	DRY CREEK/ DECKING/ SOFTFALL DRAIN
	VEHICLE ROAD DRAIN
\bigcirc	WATER BODY DRAIN
\boxtimes	WATER POINT
	STRIP DRAINS
	GRAVEL AG DRAINS
	PERFORATED UPVC AG DRAIN WITH FILTER FABRIC SLEEVE, CONNECT PIPE TO SW SYSTEM UPVC
← FALL	FALLS TO DRAIN
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	PROPOSED CONTOUR LINES
	RIDGE LINES
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	O SURFACE SLAB LEVEL AS PER THE RAL / ENGINEERS DRAWINGS.

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PROJECT

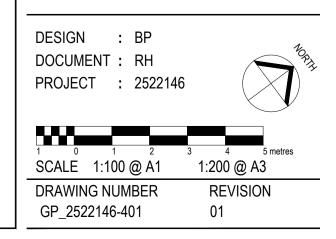GUNYAMA PARK STAGE 2


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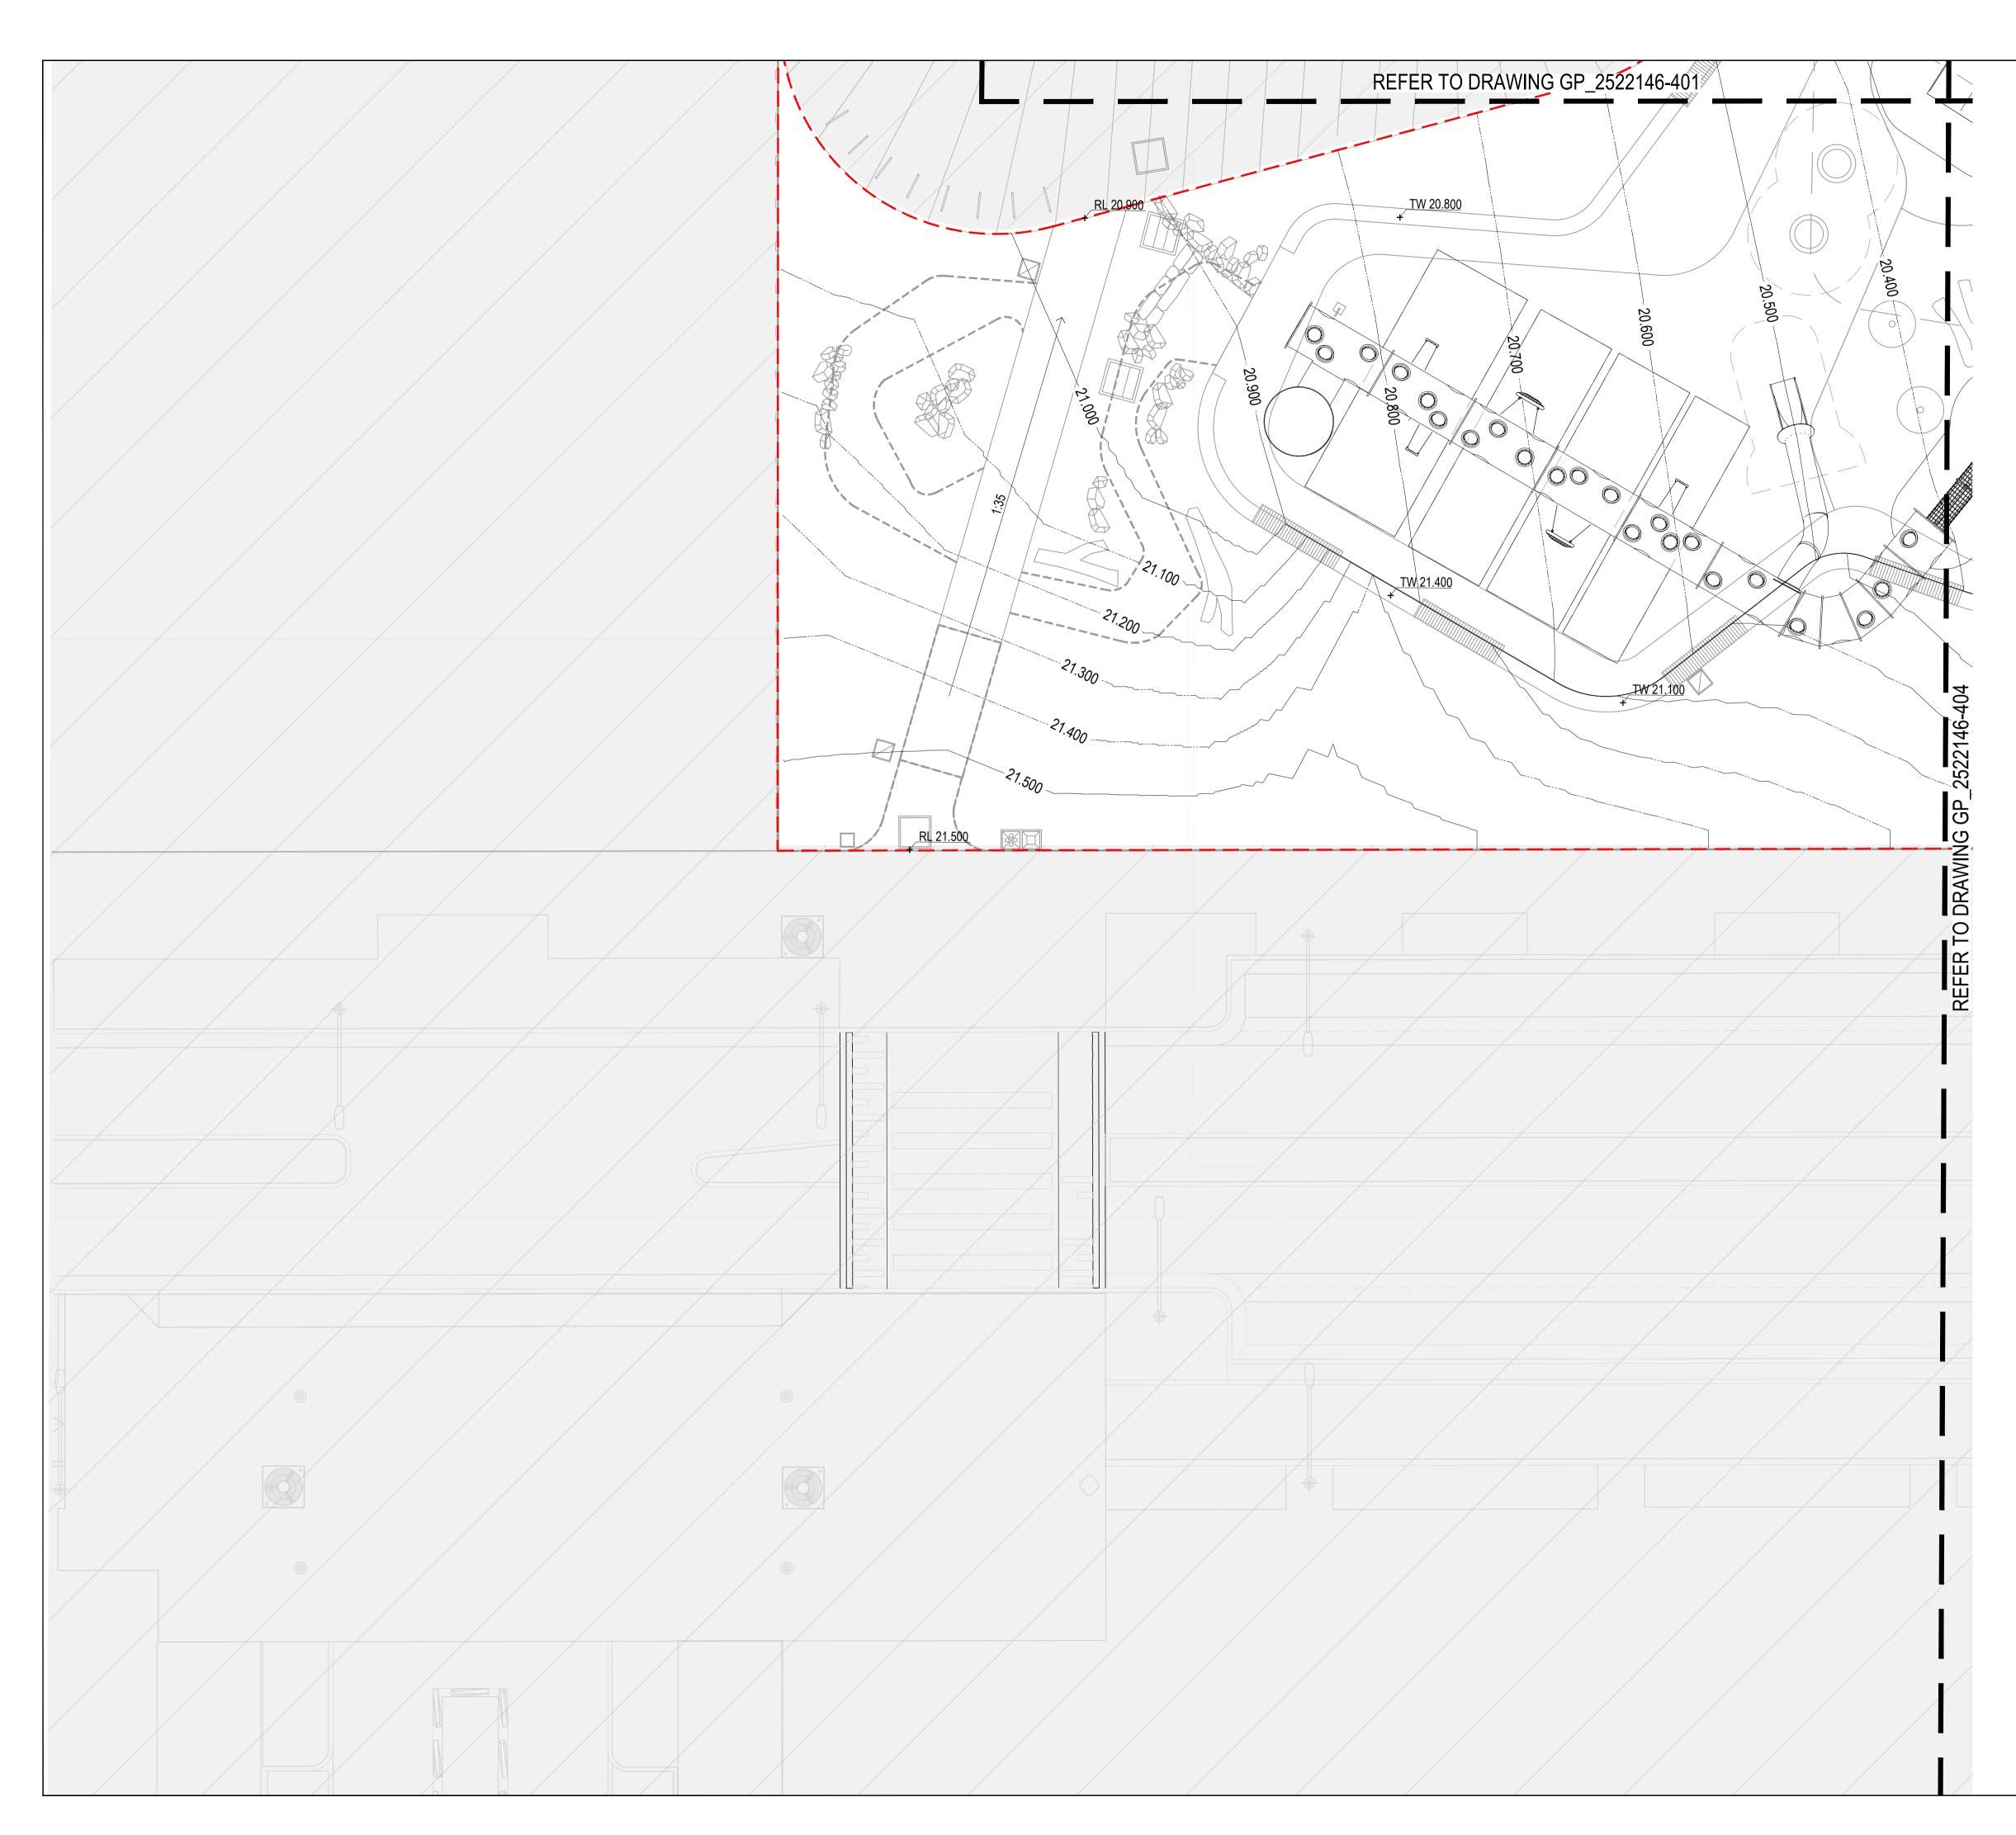
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NOTES



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ISSUE	CODE	ISSUE DESCRIPTION	BY	СНК	DATE		
01	PRE	50% DESIGN DEVELOPMENT	RH	LI	19.07.2023		
PRE - P	PRE - Preliminary CA - Council Approval T - Tender CON - Construction						
DRA	DRAWING TITLE						



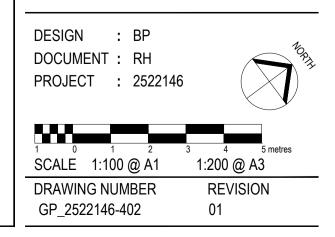

FFL 00.000 + RL 00.000 + TH 00.000	FFL - FINISHED INTERNAL FLOOR LEVEL RL - REDUCED LEVEL
<pre>+ EL 00.000 + SL 00.000 + GL 00.000 + GL 00.000 + WL 00.000 + BL 00.000 + TW 00.000 + BK 00.000 + SD 00.000 + IL 00.000 + TB 00.000 + BB 00.000</pre>	EL - EXISTING LEVEL SL - SLAB / PODIUM LEVEL GL - FINISHED GARDEN LEVEL WL - WATER LEVEL BL - BASE OF WATER FEATURE / POOL LEV TW - TOP OF WALL LEVEL BK - BACK OF KERB LEVEL SD - SURFACE DRAIN LEVEL IL - INVERT LEVEL TB - TOP OF BATTER BB - BOTTOM OF BATTER
*	SOFTSCAPE DRAIN
⊕	SURFACE FLOOR DRAIN
	DRY CREEK/ DECKING/ SOFTFALL DRAIN
	VEHICLE ROAD DRAIN
\bigcirc	WATER BODY DRAIN
\boxtimes	WATER POINT
	STRIP DRAINS
12020202020	GRAVEL AG DRAINS
	PERFORATED UPVC AG DRAIN WITH FILTE FABRIC SLEEVE, CONNECT PIPE TO SW SYSTEM UPVC
← FALL	FALLS TO DRAIN
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	PROPOSED CONTOUR LINES
	RIDGE LINES
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NOTE: SL REFERS TO) SURFACE SLAB LEVEL AS PER THE

SL REFERS TO SURFACE SLAB LEVEL AS PER THE ARCHITECTURAL / ENGINEERS DRAWINGS.

FL WHERE SHOWN ON LANDSCAPE DRAWINGS REFERS TO FINISHED FLOOR LEVEL.

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PROJECT

GUNYAMA PARK STAGE 2

CLIENT


CITY OF SYDNEY


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ISSUE	CODE	ISSUE DESCRIPTION	BY	СНК	DATE
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DRAWING TITLE





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•	SURFACE FLOOR DRAIN
	DRY CREEK/ DECKING/ SOFTFALL DRAIN
	VEHICLE ROAD DRAIN
\bigcirc	WATER BODY DRAIN
\boxtimes	WATER POINT
	STRIP DRAINS
20020020	GRAVEL AG DRAINS
	PERFORATED UPVC AG DRAIN WITH FILTER FABRIC SLEEVE, CONNECT PIPE TO SW SYSTEM UPVC
← FALL	FALLS TO DRAIN
0.0	EXISTING CONTOUR LINES
	PROPOSED CONTOUR LINES
	RIDGE LINES
$- \leftarrow -$	SWALES
) SURFACE SLAB LEVEL AS PER THE RAL / ENGINEERS DRAWINGS.

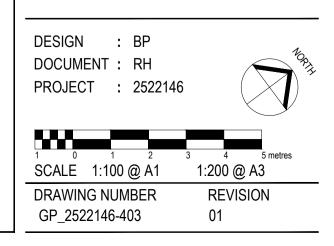FL WHERE SHOWN ON LANDSCAPE DRAWINGS REFERS TO FINISHED FLOOR LEVEL.

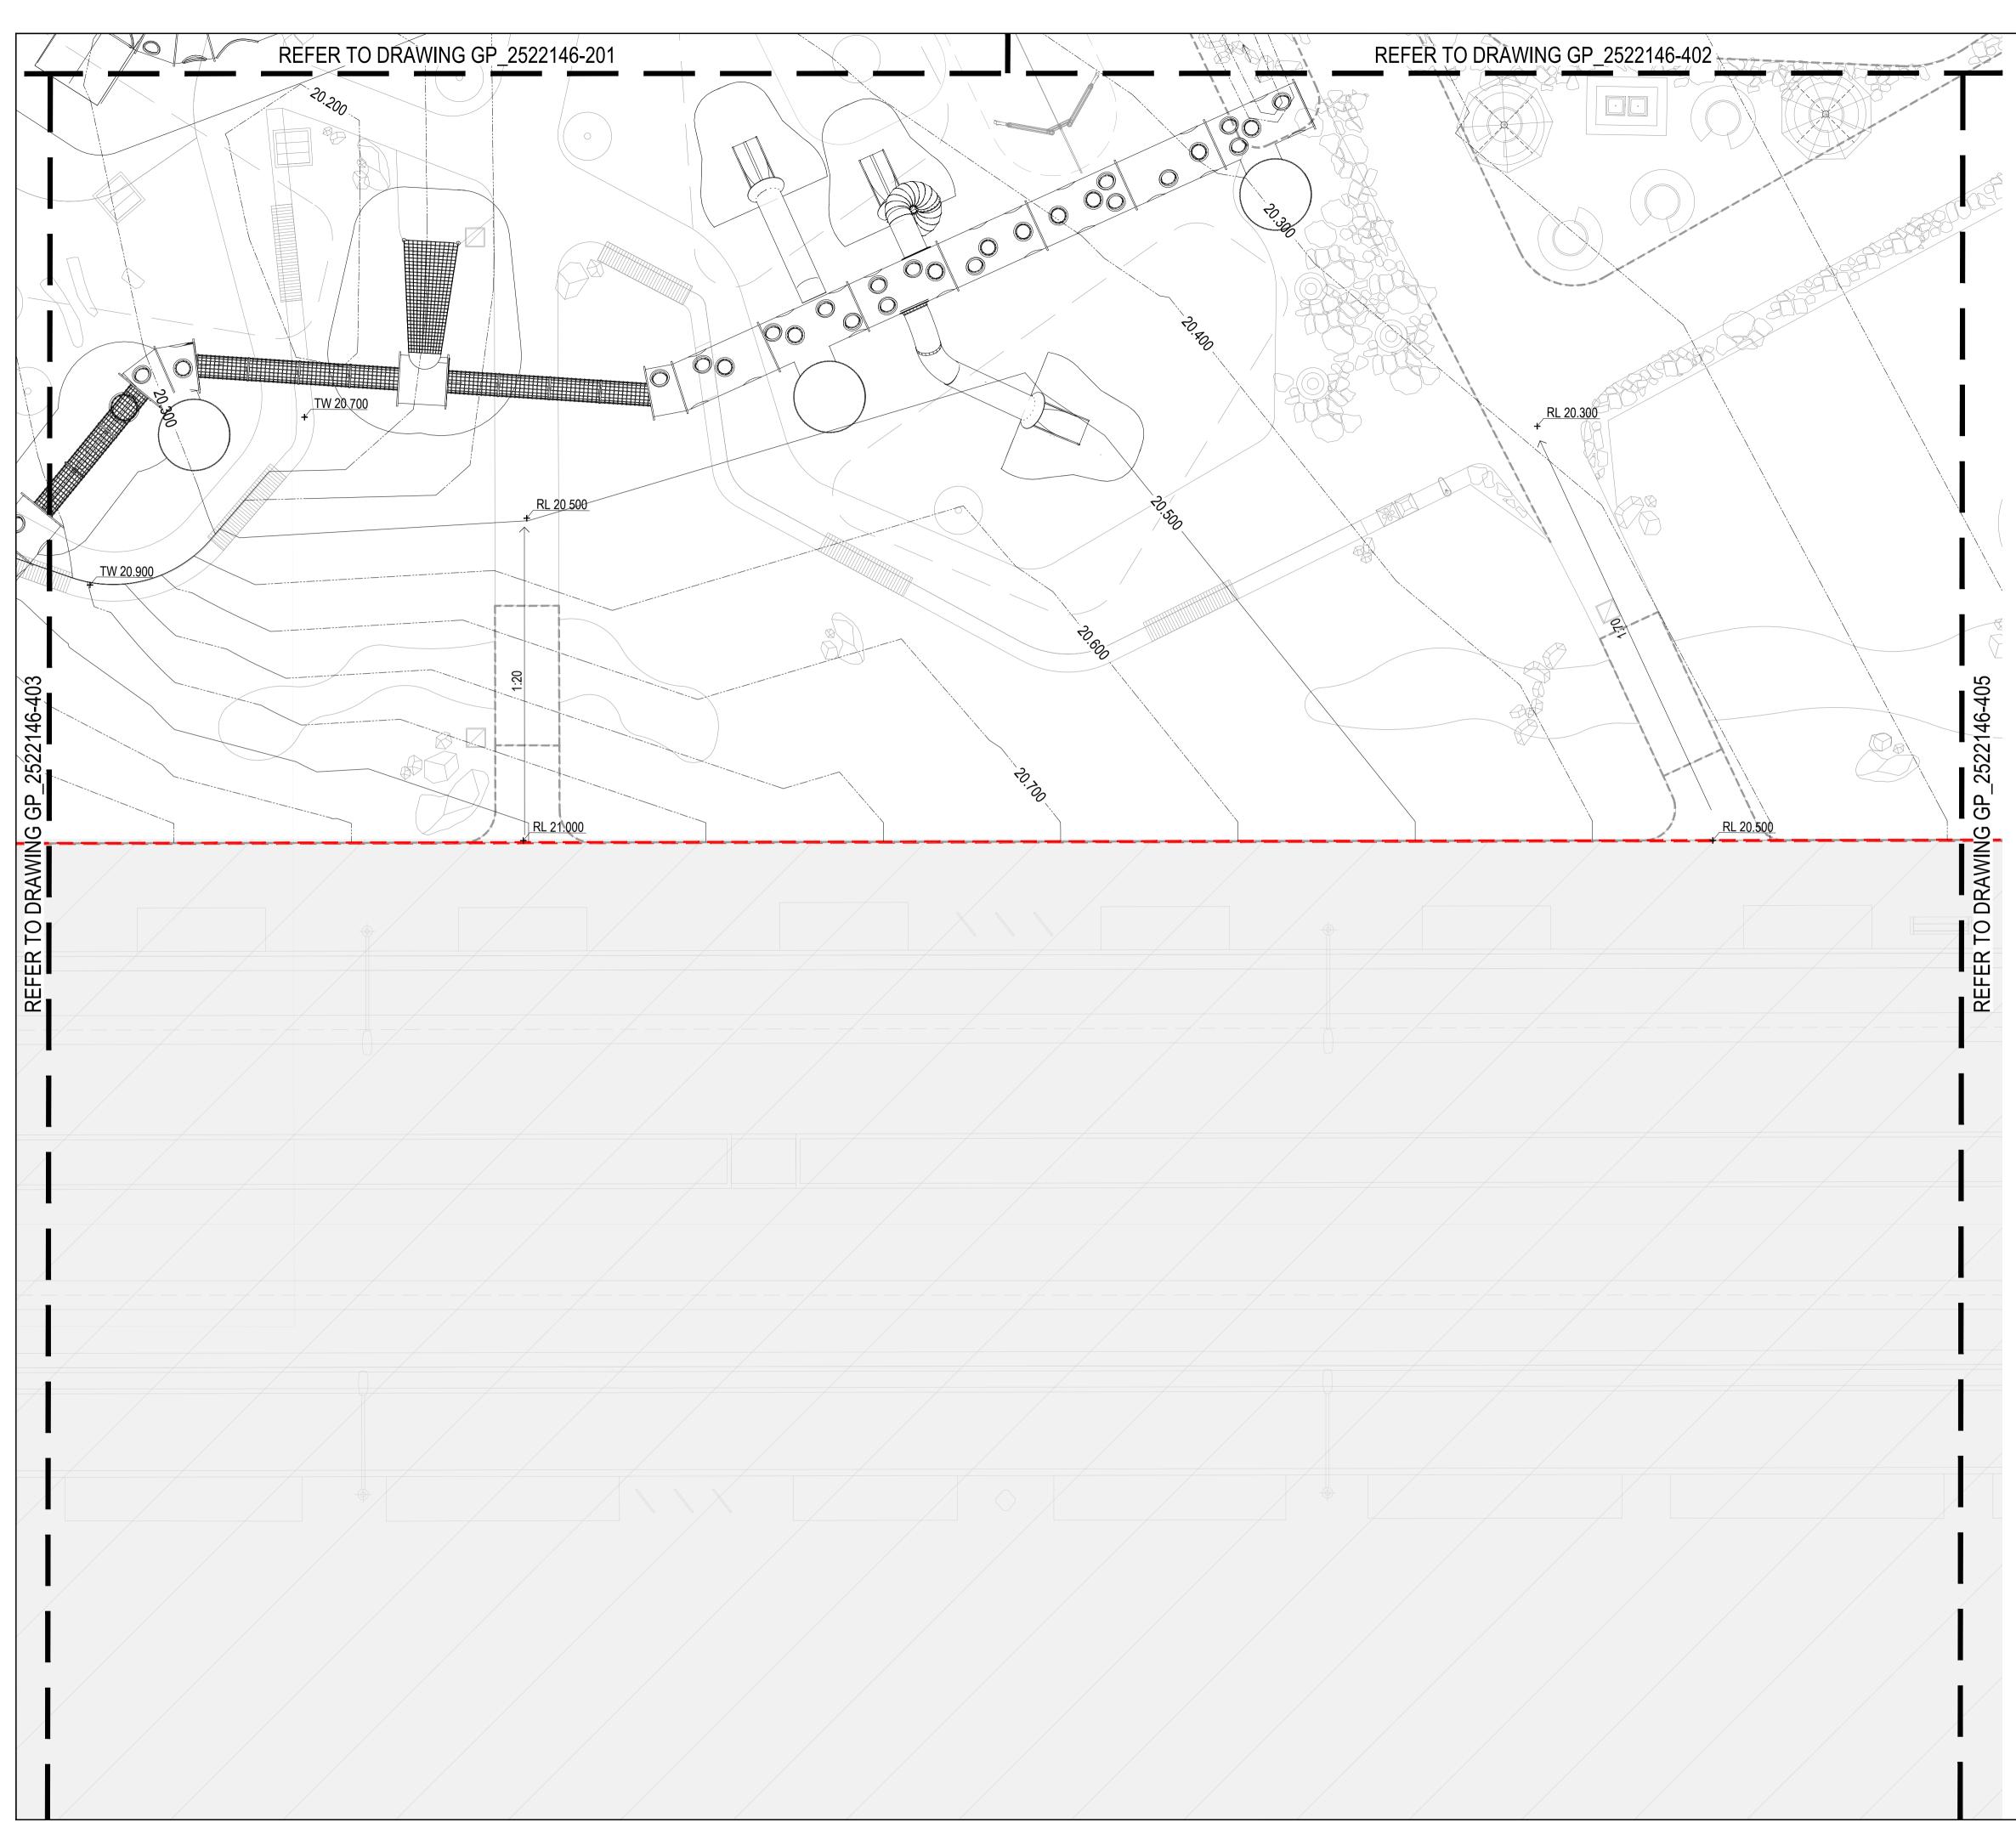ALL TOP OF SOIL LEVELS SHALL BE 50MM BELOW ADJACENT FLOOR LEVELS, KERBS, SEATS AND WALLS, UNLESS SHOWN OTHERWISE.

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GUNYAMA PARK STAGE 2

CLIENT


CITY OF SYDNEY


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TB 00.000	TB - TOP OF BATTER
BB 00.000 +	BB - BOTTOM OF BATTER
۲	SOFTSCAPE DRAIN
D	SURFACE FLOOR DRAIN
	DRY CREEK/ DECKING/ SOFTFALL DRAIN
	VEHICLE ROAD DRAIN
\bigcirc	WATER BODY DRAIN
\boxtimes	WATER POINT
	STRIP DRAINS
1202202020	GRAVEL AG DRAINS
	PERFORATED UPVC AG DRAIN WITH FILTER FABRIC SLEEVE, CONNECT PIPE TO SW SYSTEM UPVC
← FALL	FALLS TO DRAIN
0.0	EXISTING CONTOUR LINES
	PROPOSED CONTOUR LINES
	RIDGE LINES
$- \leftarrow -$	SWALES
) SURFACE SLAB LEVEL AS PER THE RAL / ENGINEERS DRAWINGS.

ARCHITECTURAL / ENGINEERS DRAWINGS.

FL WHERE SHOWN ON LANDSCAPE DRAWINGS REFERS TO FINISHED FLOOR LEVEL.

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PROJECT

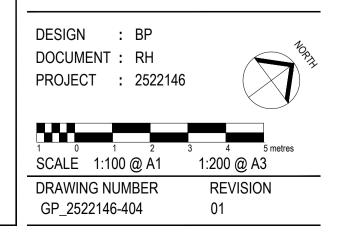GUNYAMA PARK STAGE 2
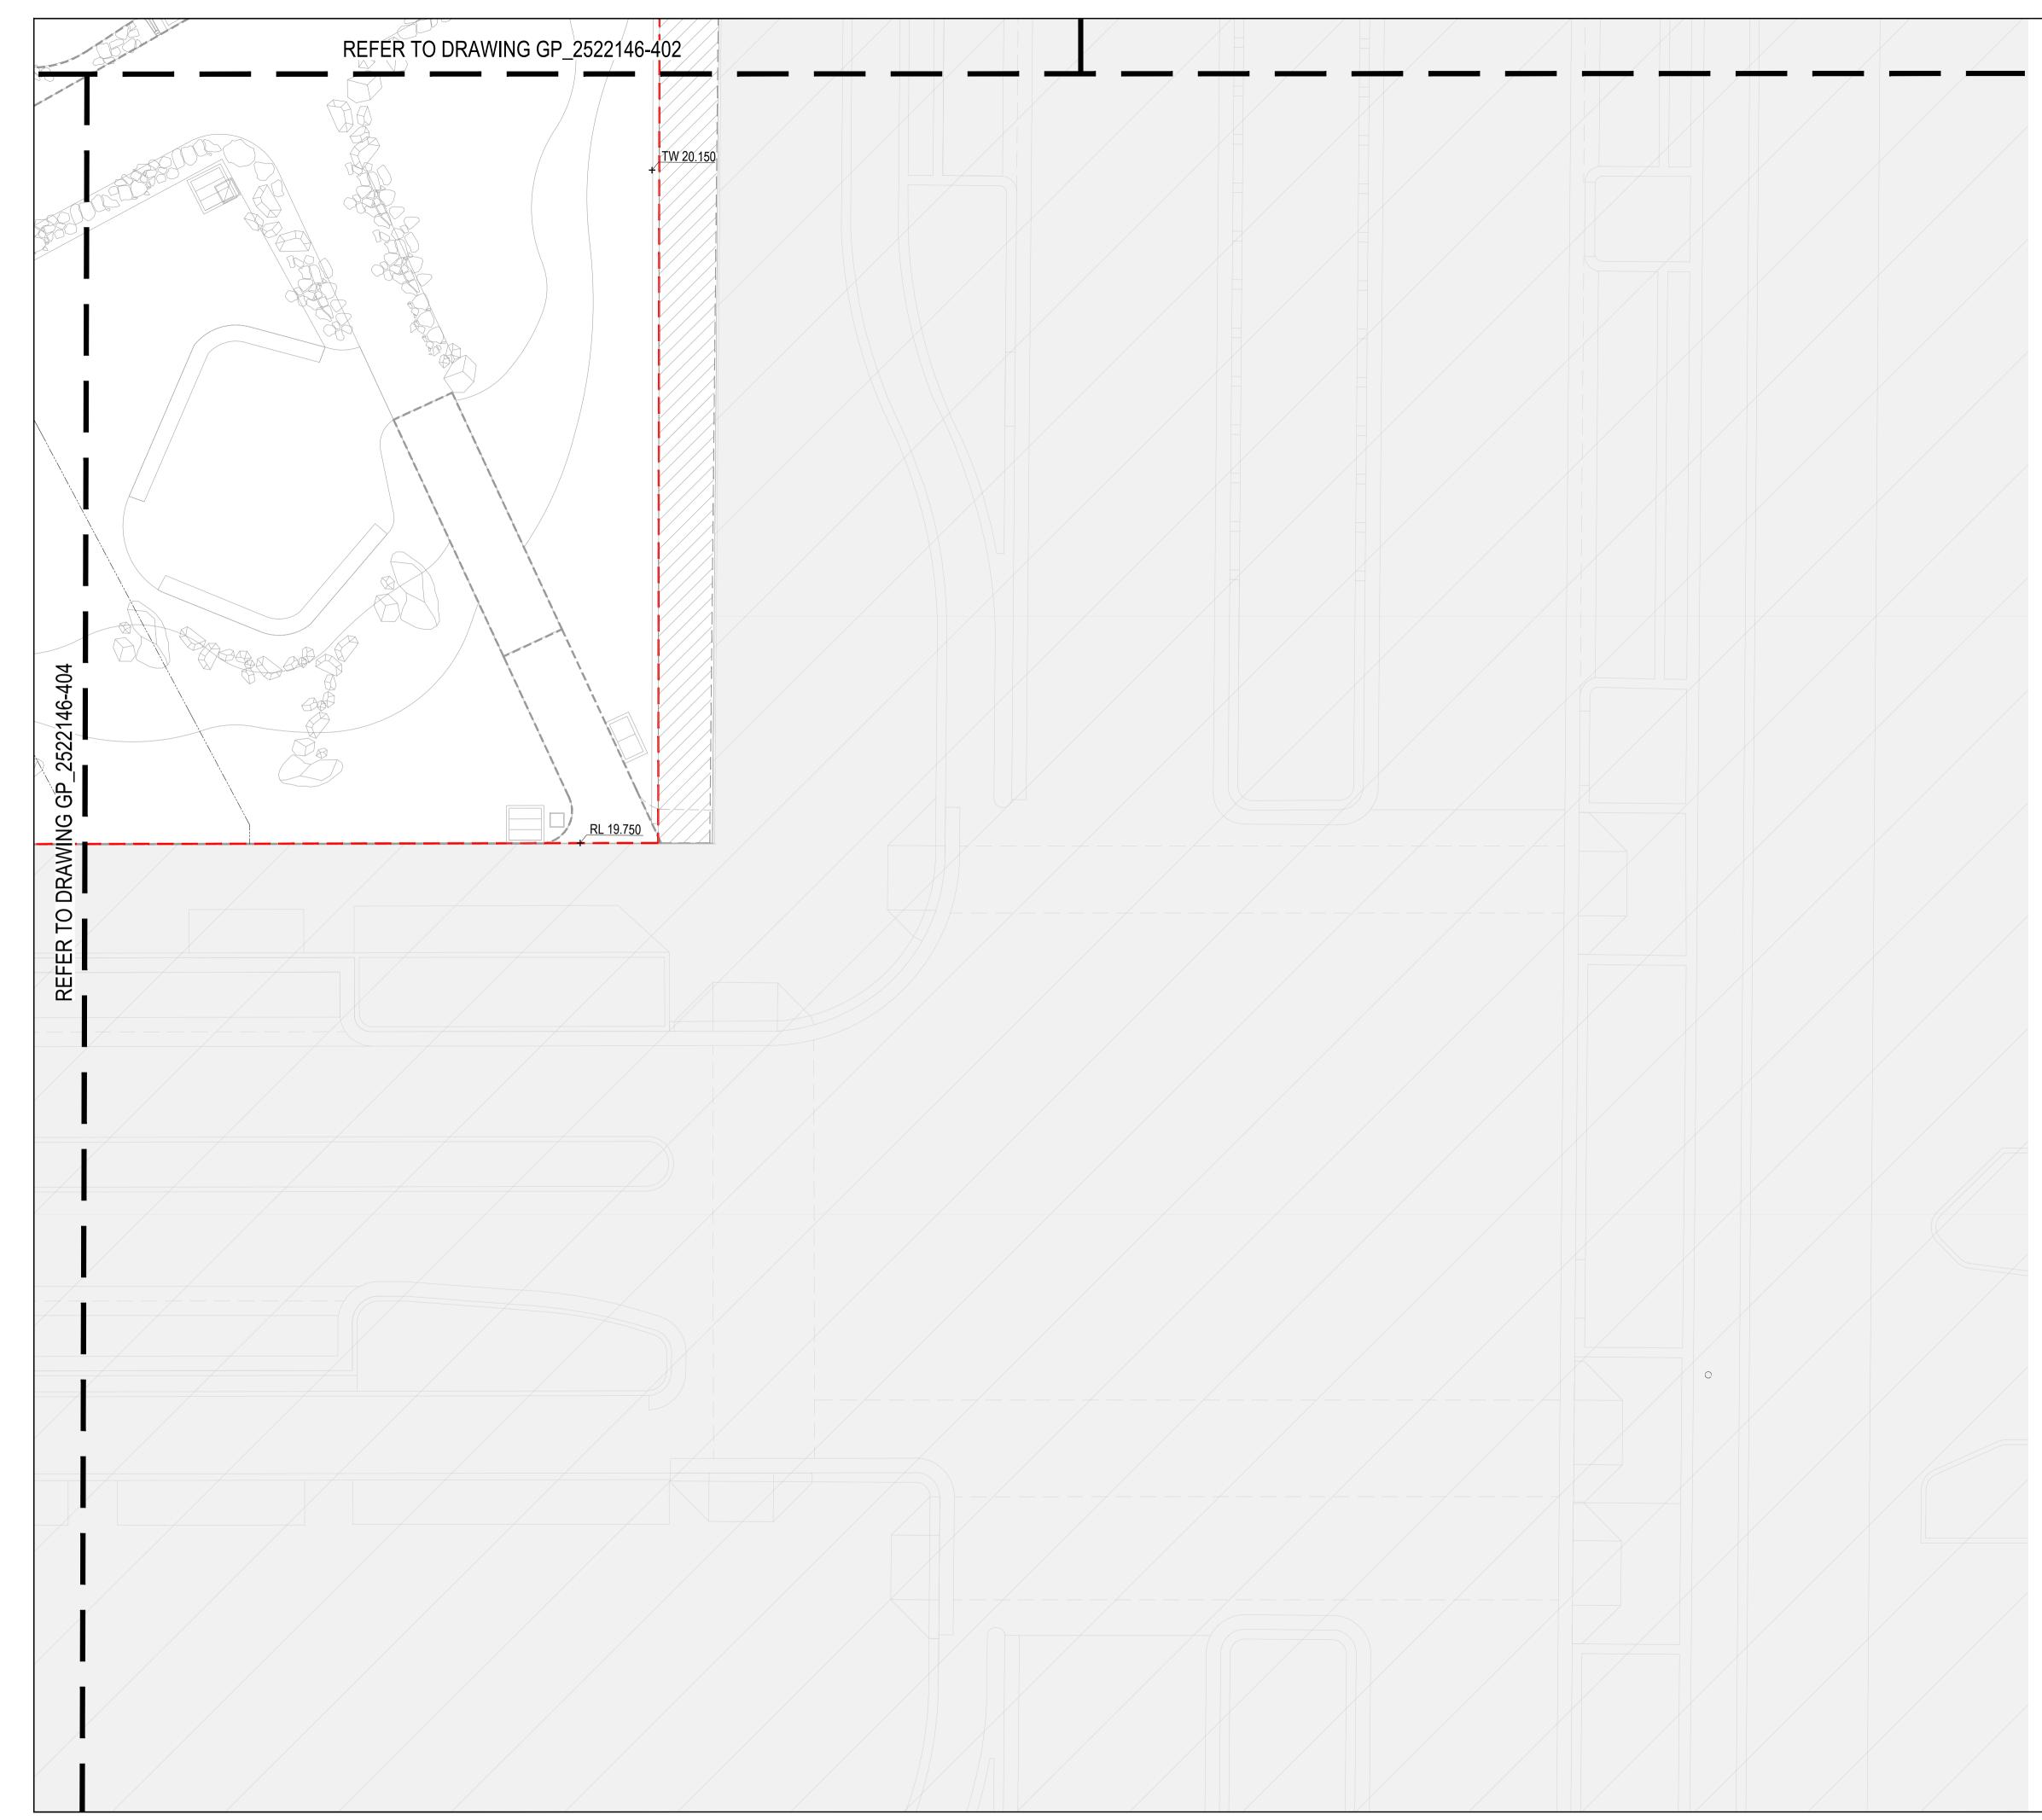
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CITY OF SYDNEY


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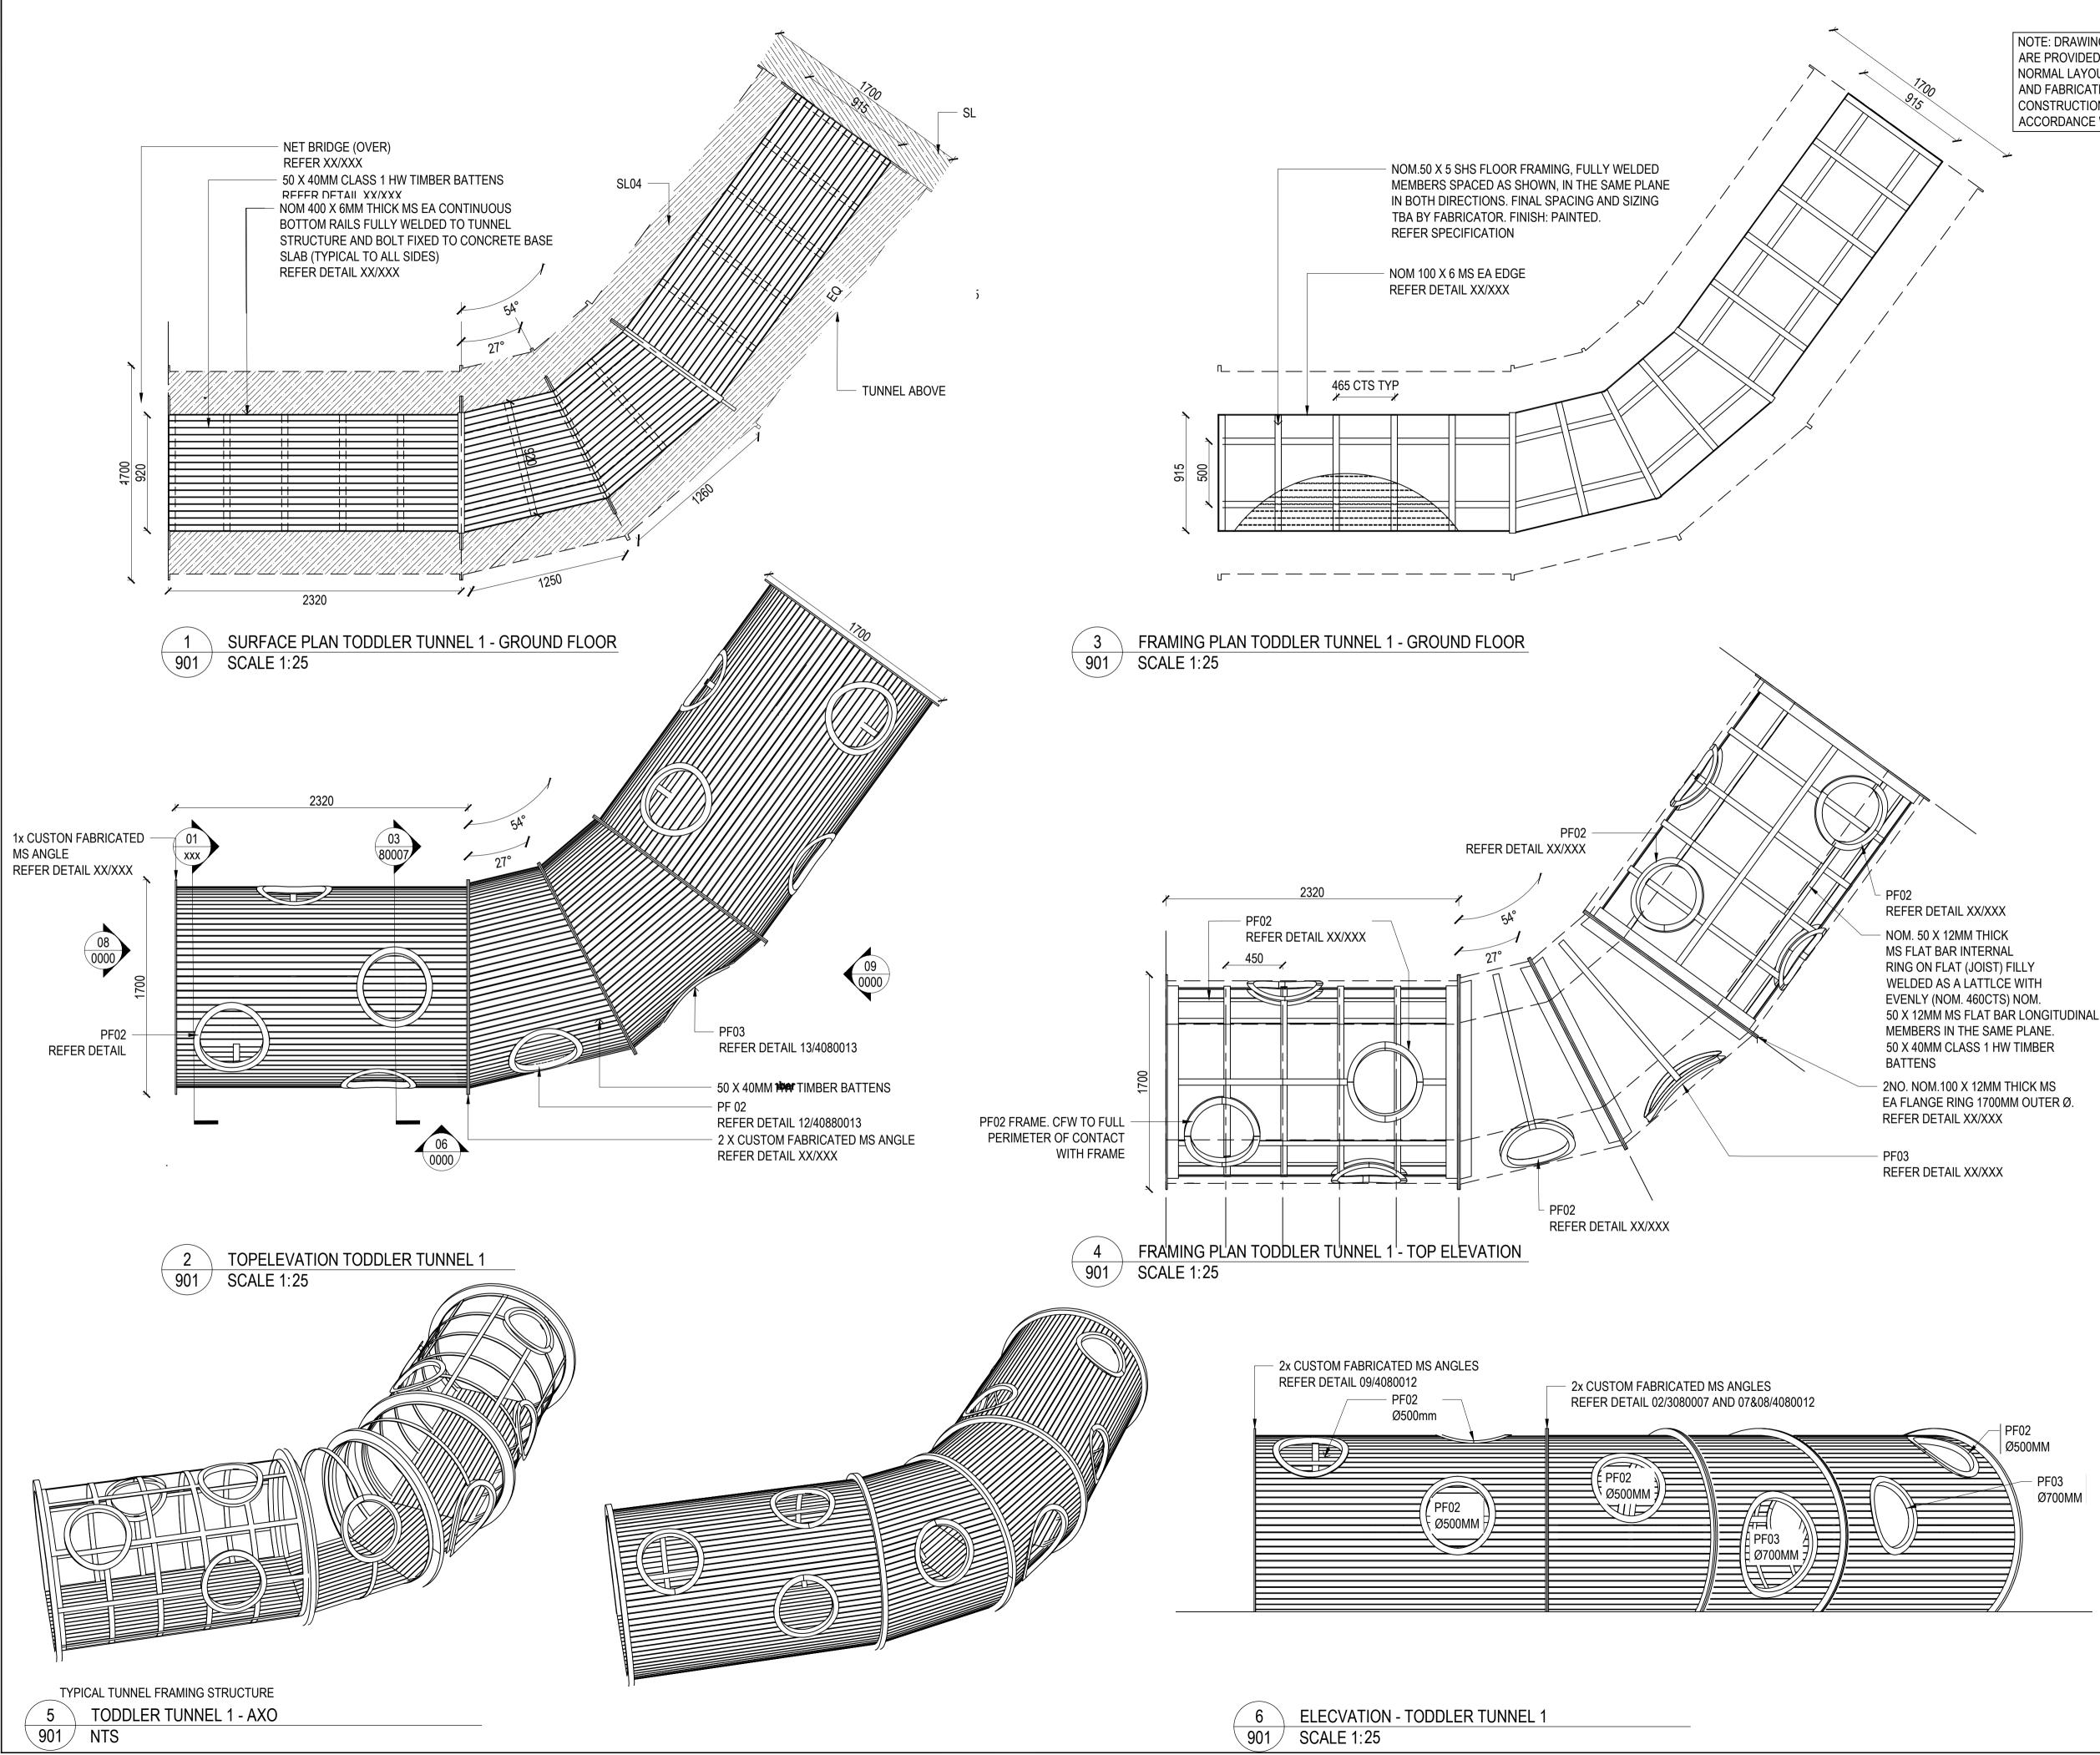


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LEVELS AND GRADING

PLAN



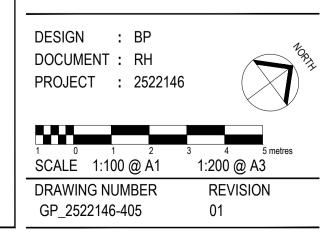

NOTE: DRAWINGS OF TUNNEL PLAY STRUCTURES ARE PROVIDED TO SHOW DESIGN INTENT AND A NORMAL LAYOUT OF STRUCTURAL COMPONENTS AND FABRICATION DETAILING. FINAL CONSTRUCTION OF PLAY STRUCTURES TO BE ACCORDANCE WITH APPROVED SHOP DRAWINGS.

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DRAWING TITLE


HARDSCAPE DETAILS

DESIGN : BP DOCUMENT : RH PROJECT : 2522146



SCALE AS SHOWN @ A1 DRAWING NUMBER GP_2522146_901

REVISION 01

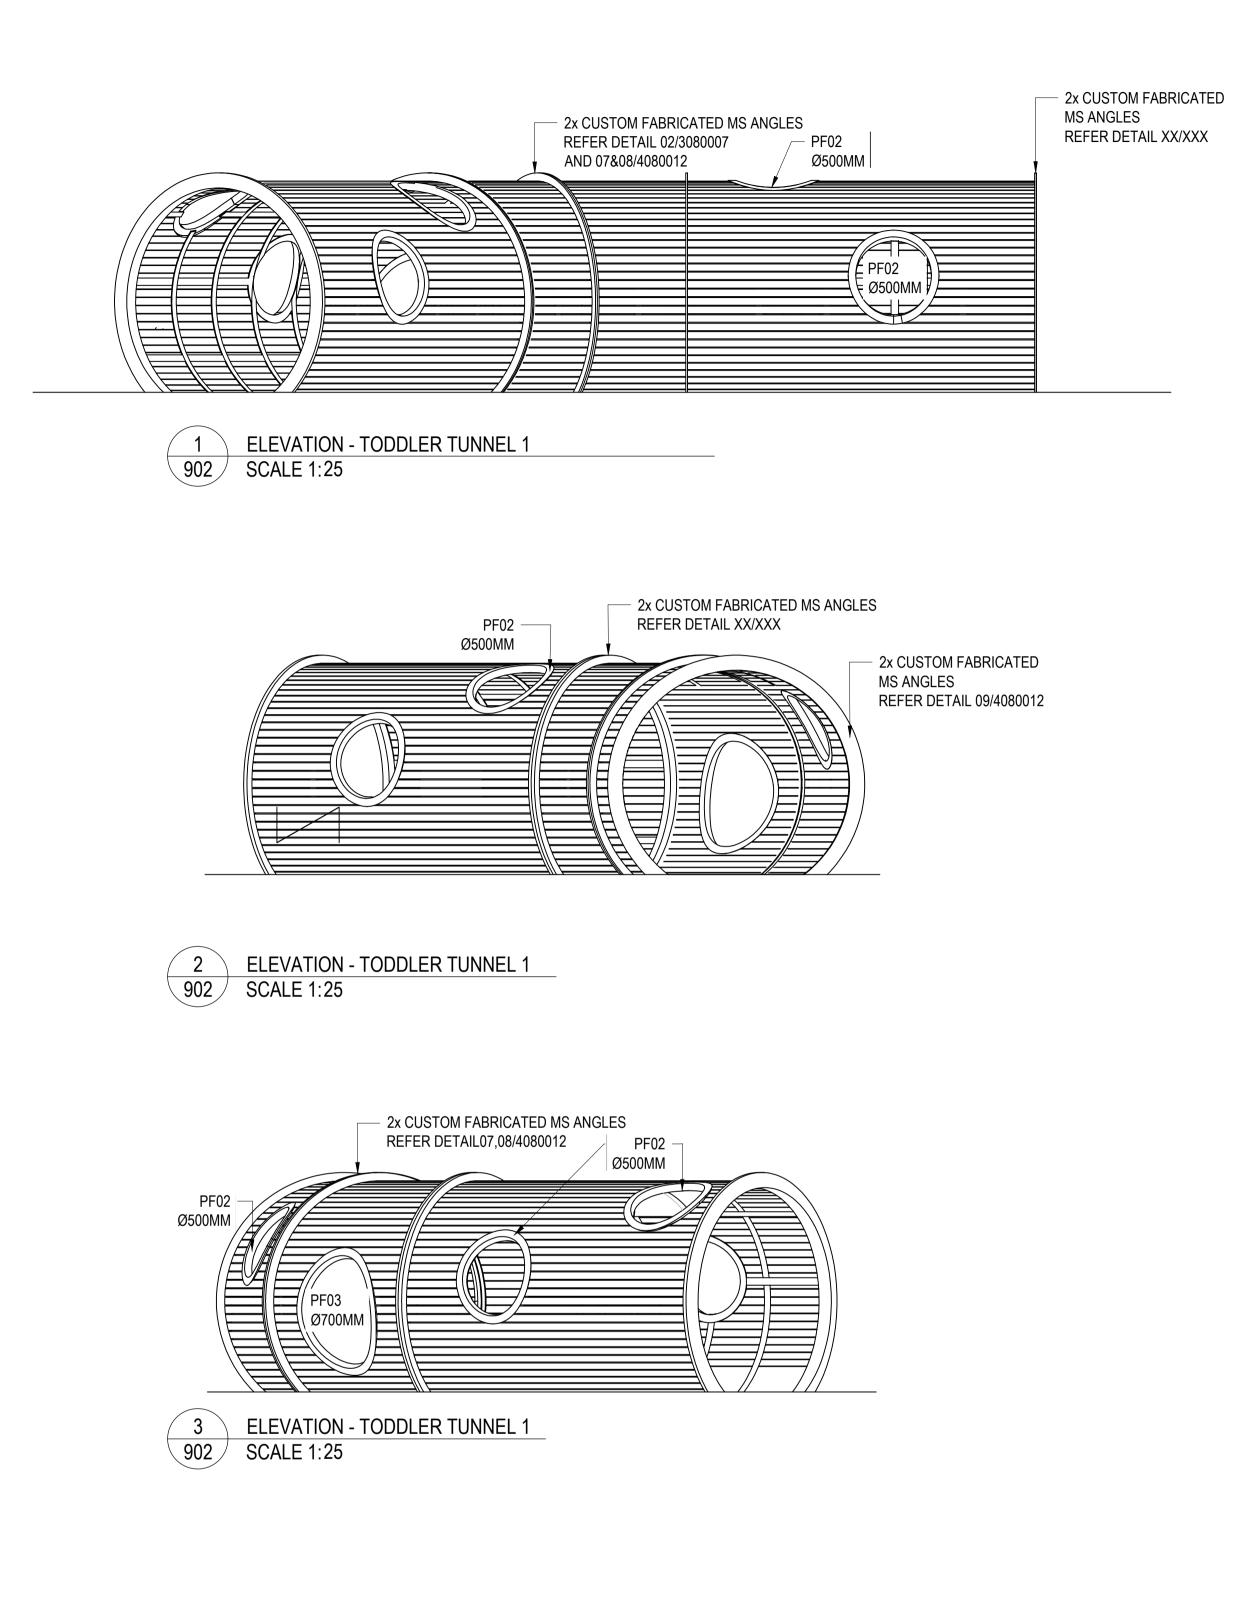

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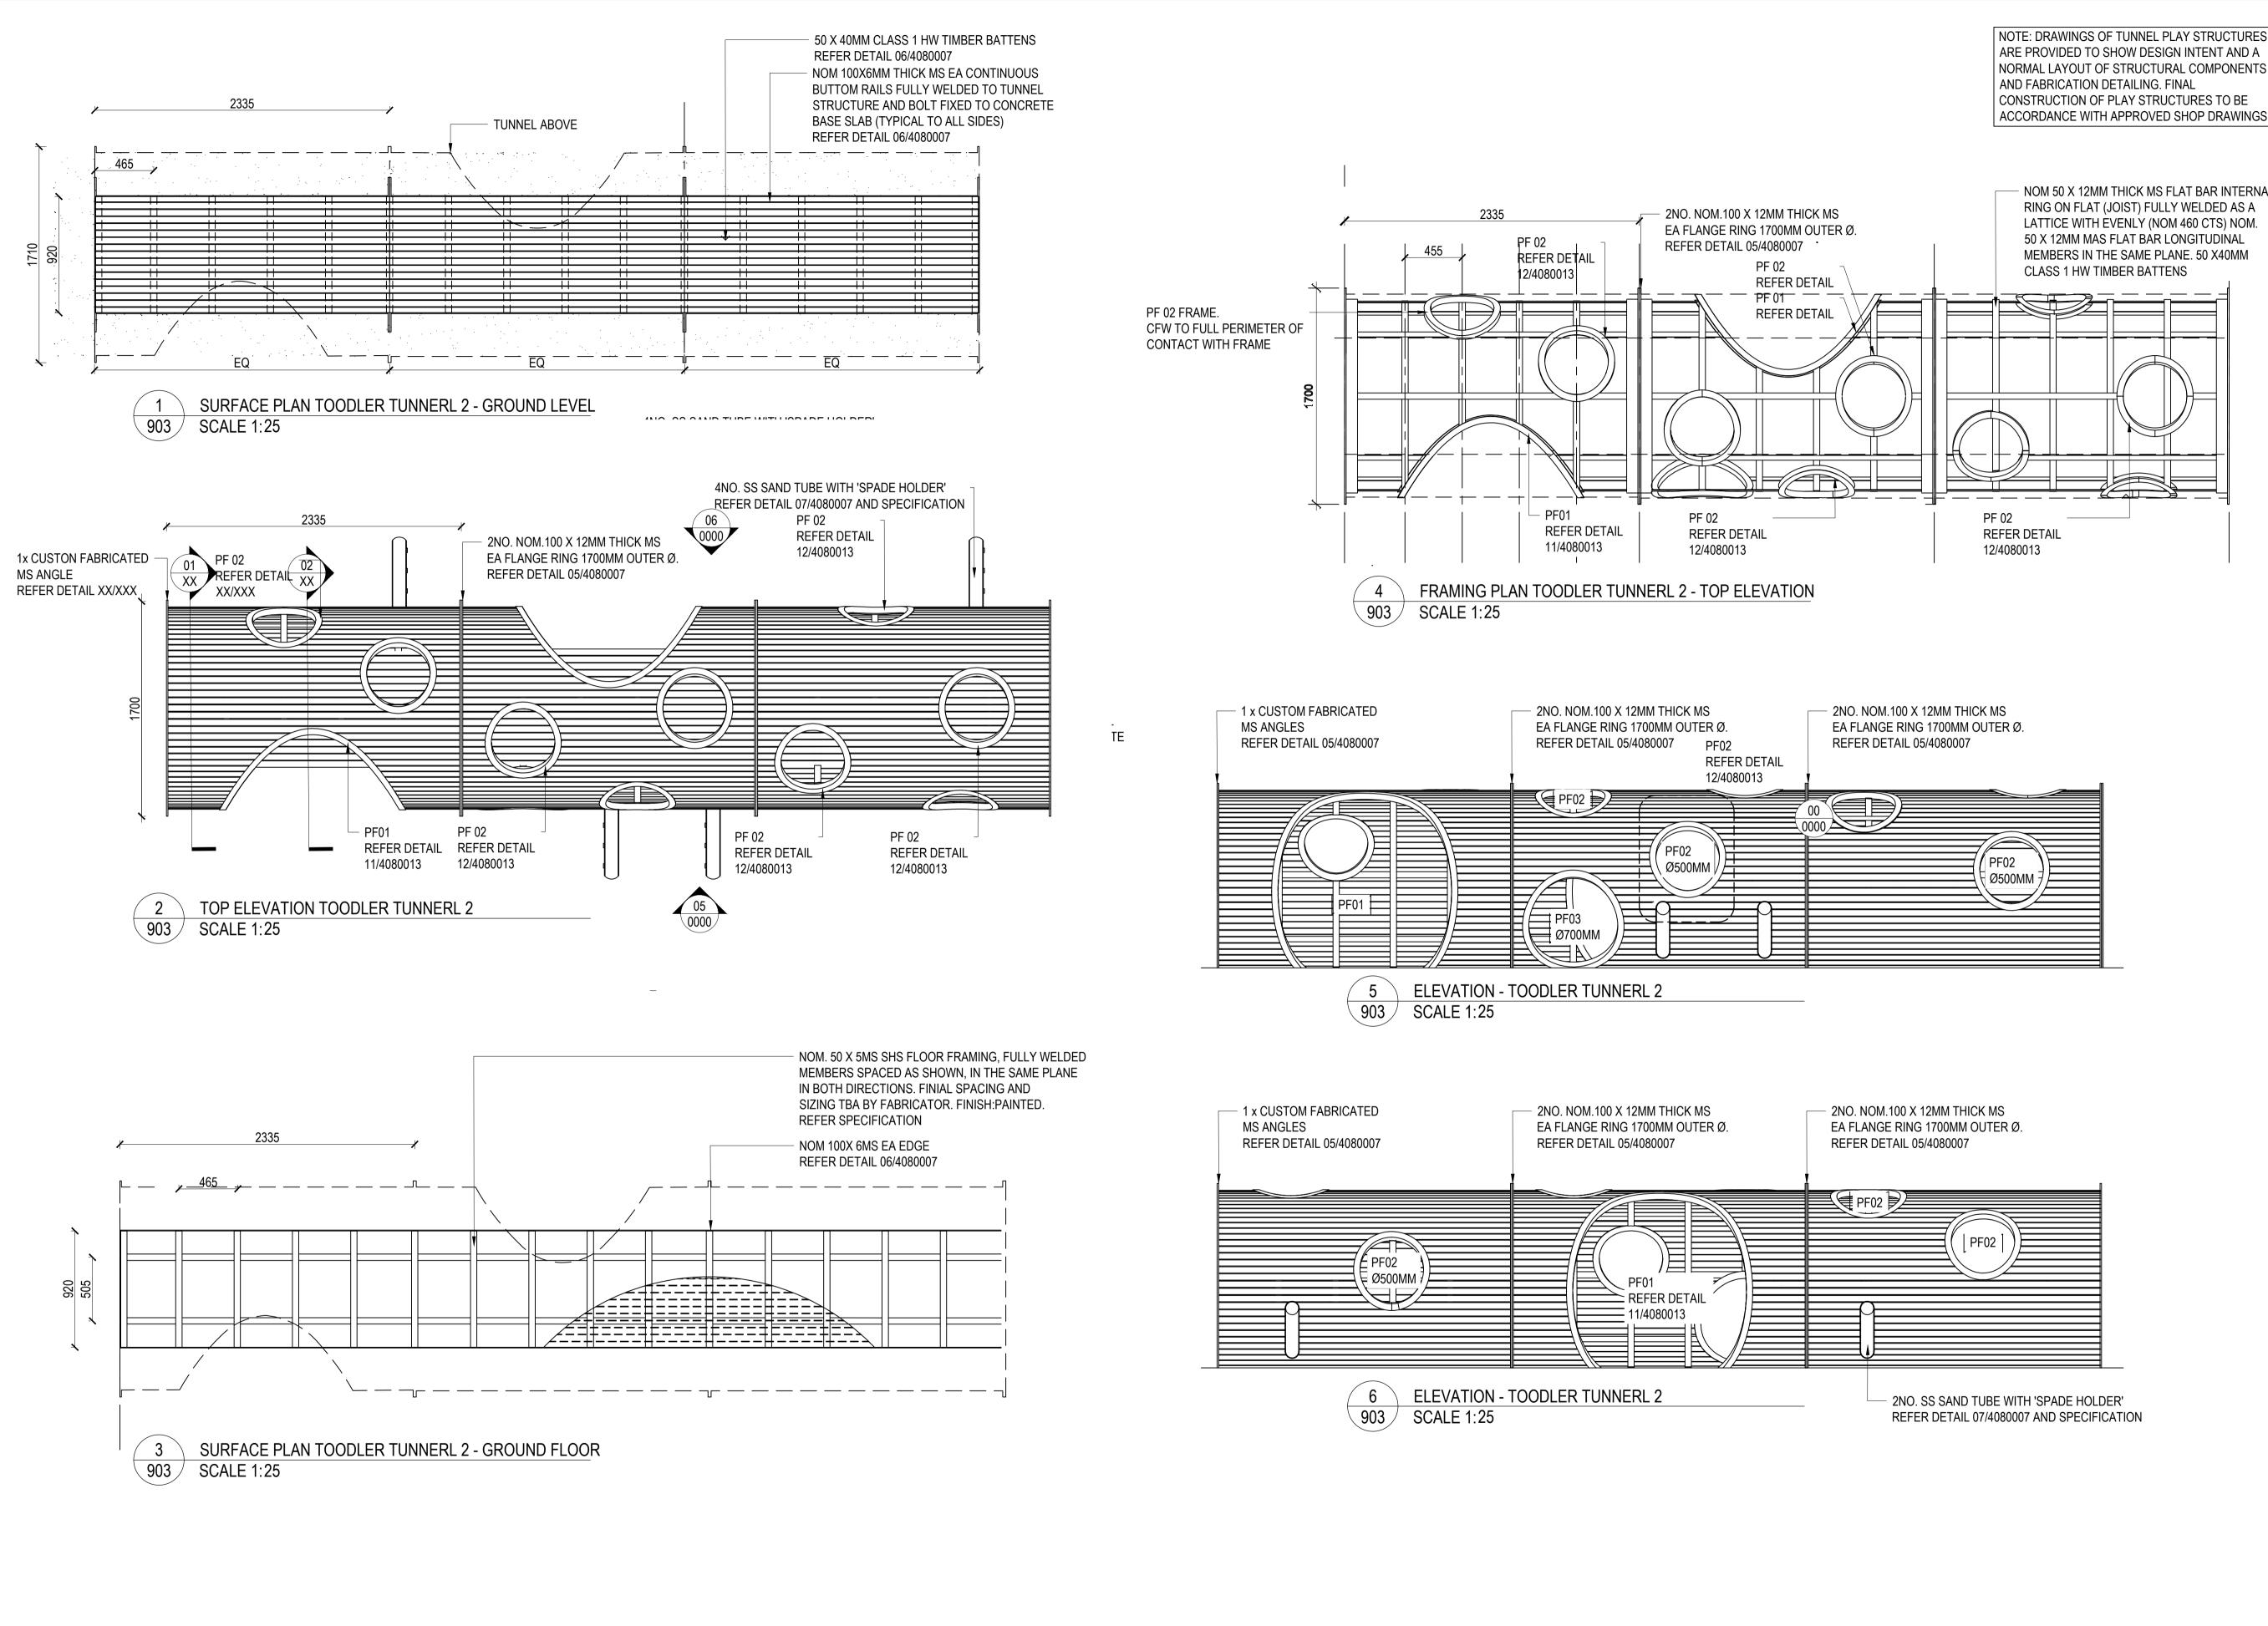
HARDSCAPE DETAILS

DESIGN : BP DOCUMENT : RH PROJECT : 2522146



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NOTE: DRAWINGS OF TUNNEL PLAY STRUCTURES ARE PROVIDED TO SHOW DESIGN INTENT AND A NORMAL LAYOUT OF STRUCTURAL COMPONENTS CONSTRUCTION OF PLAY STRUCTURES TO BE

NOM 50 X 12MM THICK MS FLAT BAR INTERNAL RING ON FLAT (JOIST) FULLY WELDED AS A LATTICE WITH EVENLY (NOM 460 CTS) NOM. 50 X 12MM MAS FLAT BAR LONGITUDINAL MEMBERS IN THE SAME PLANE. 50 X40MM

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PROJECT

GUNYAMA PARK STAGE 2

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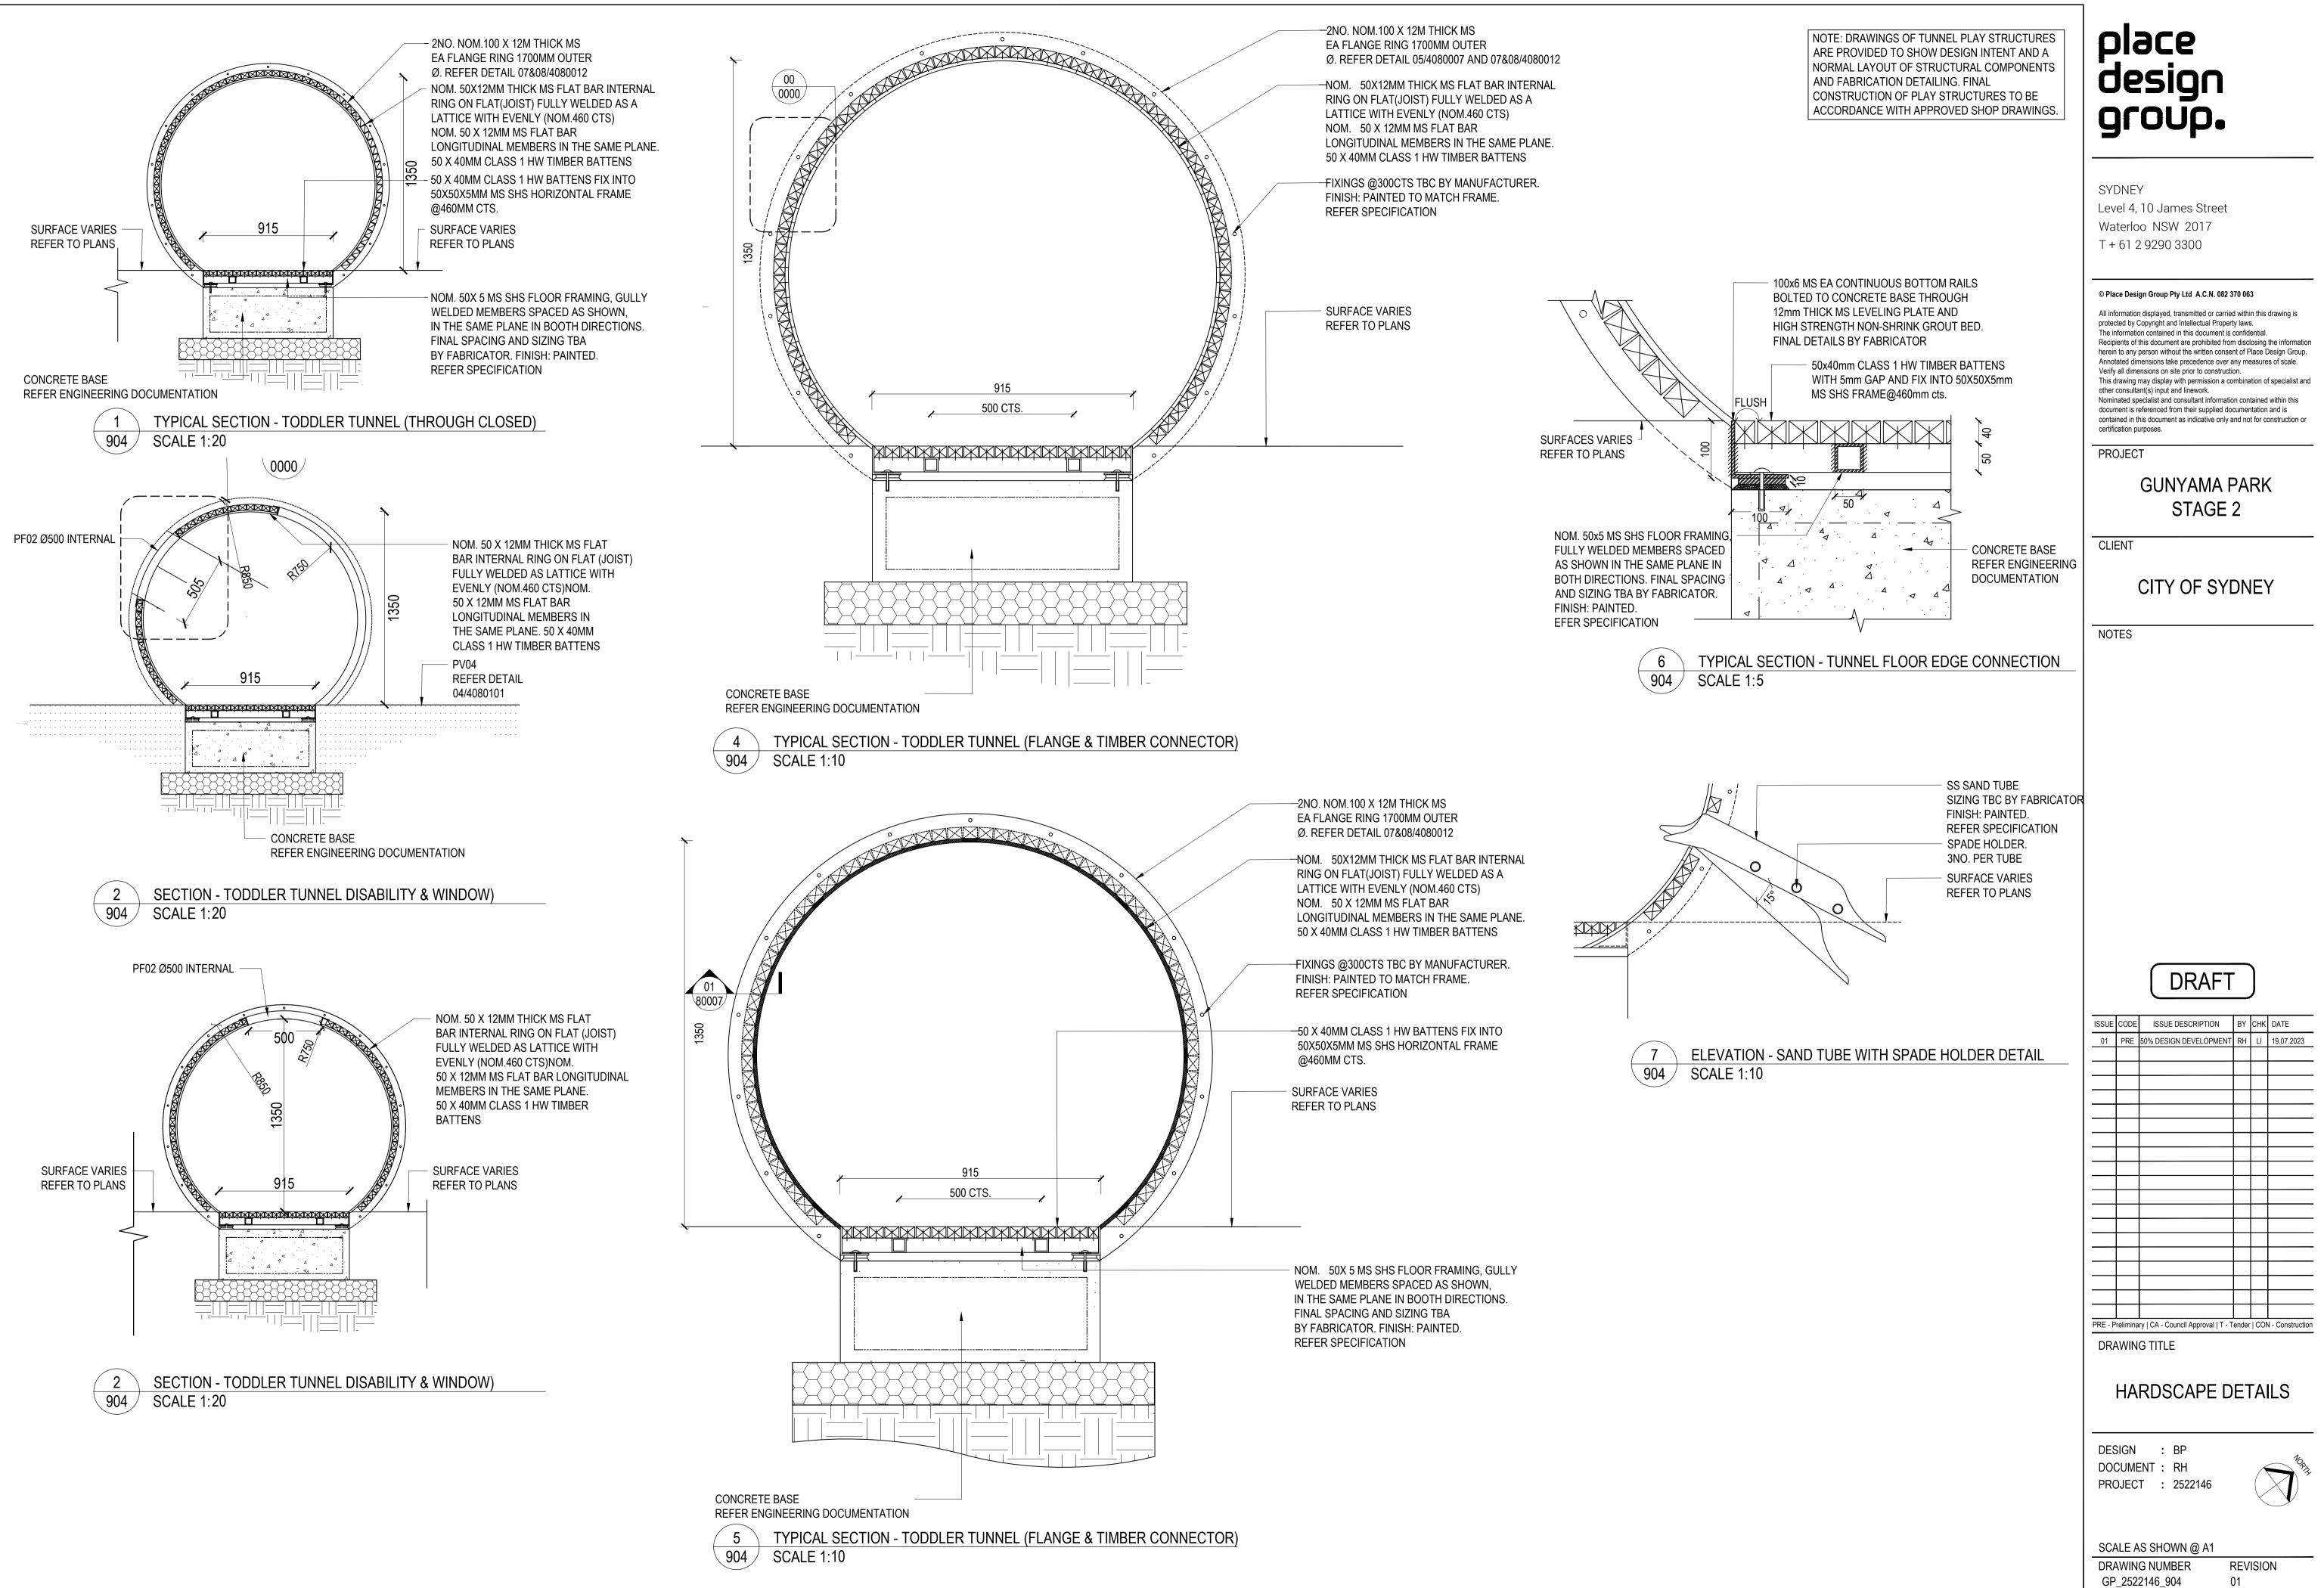
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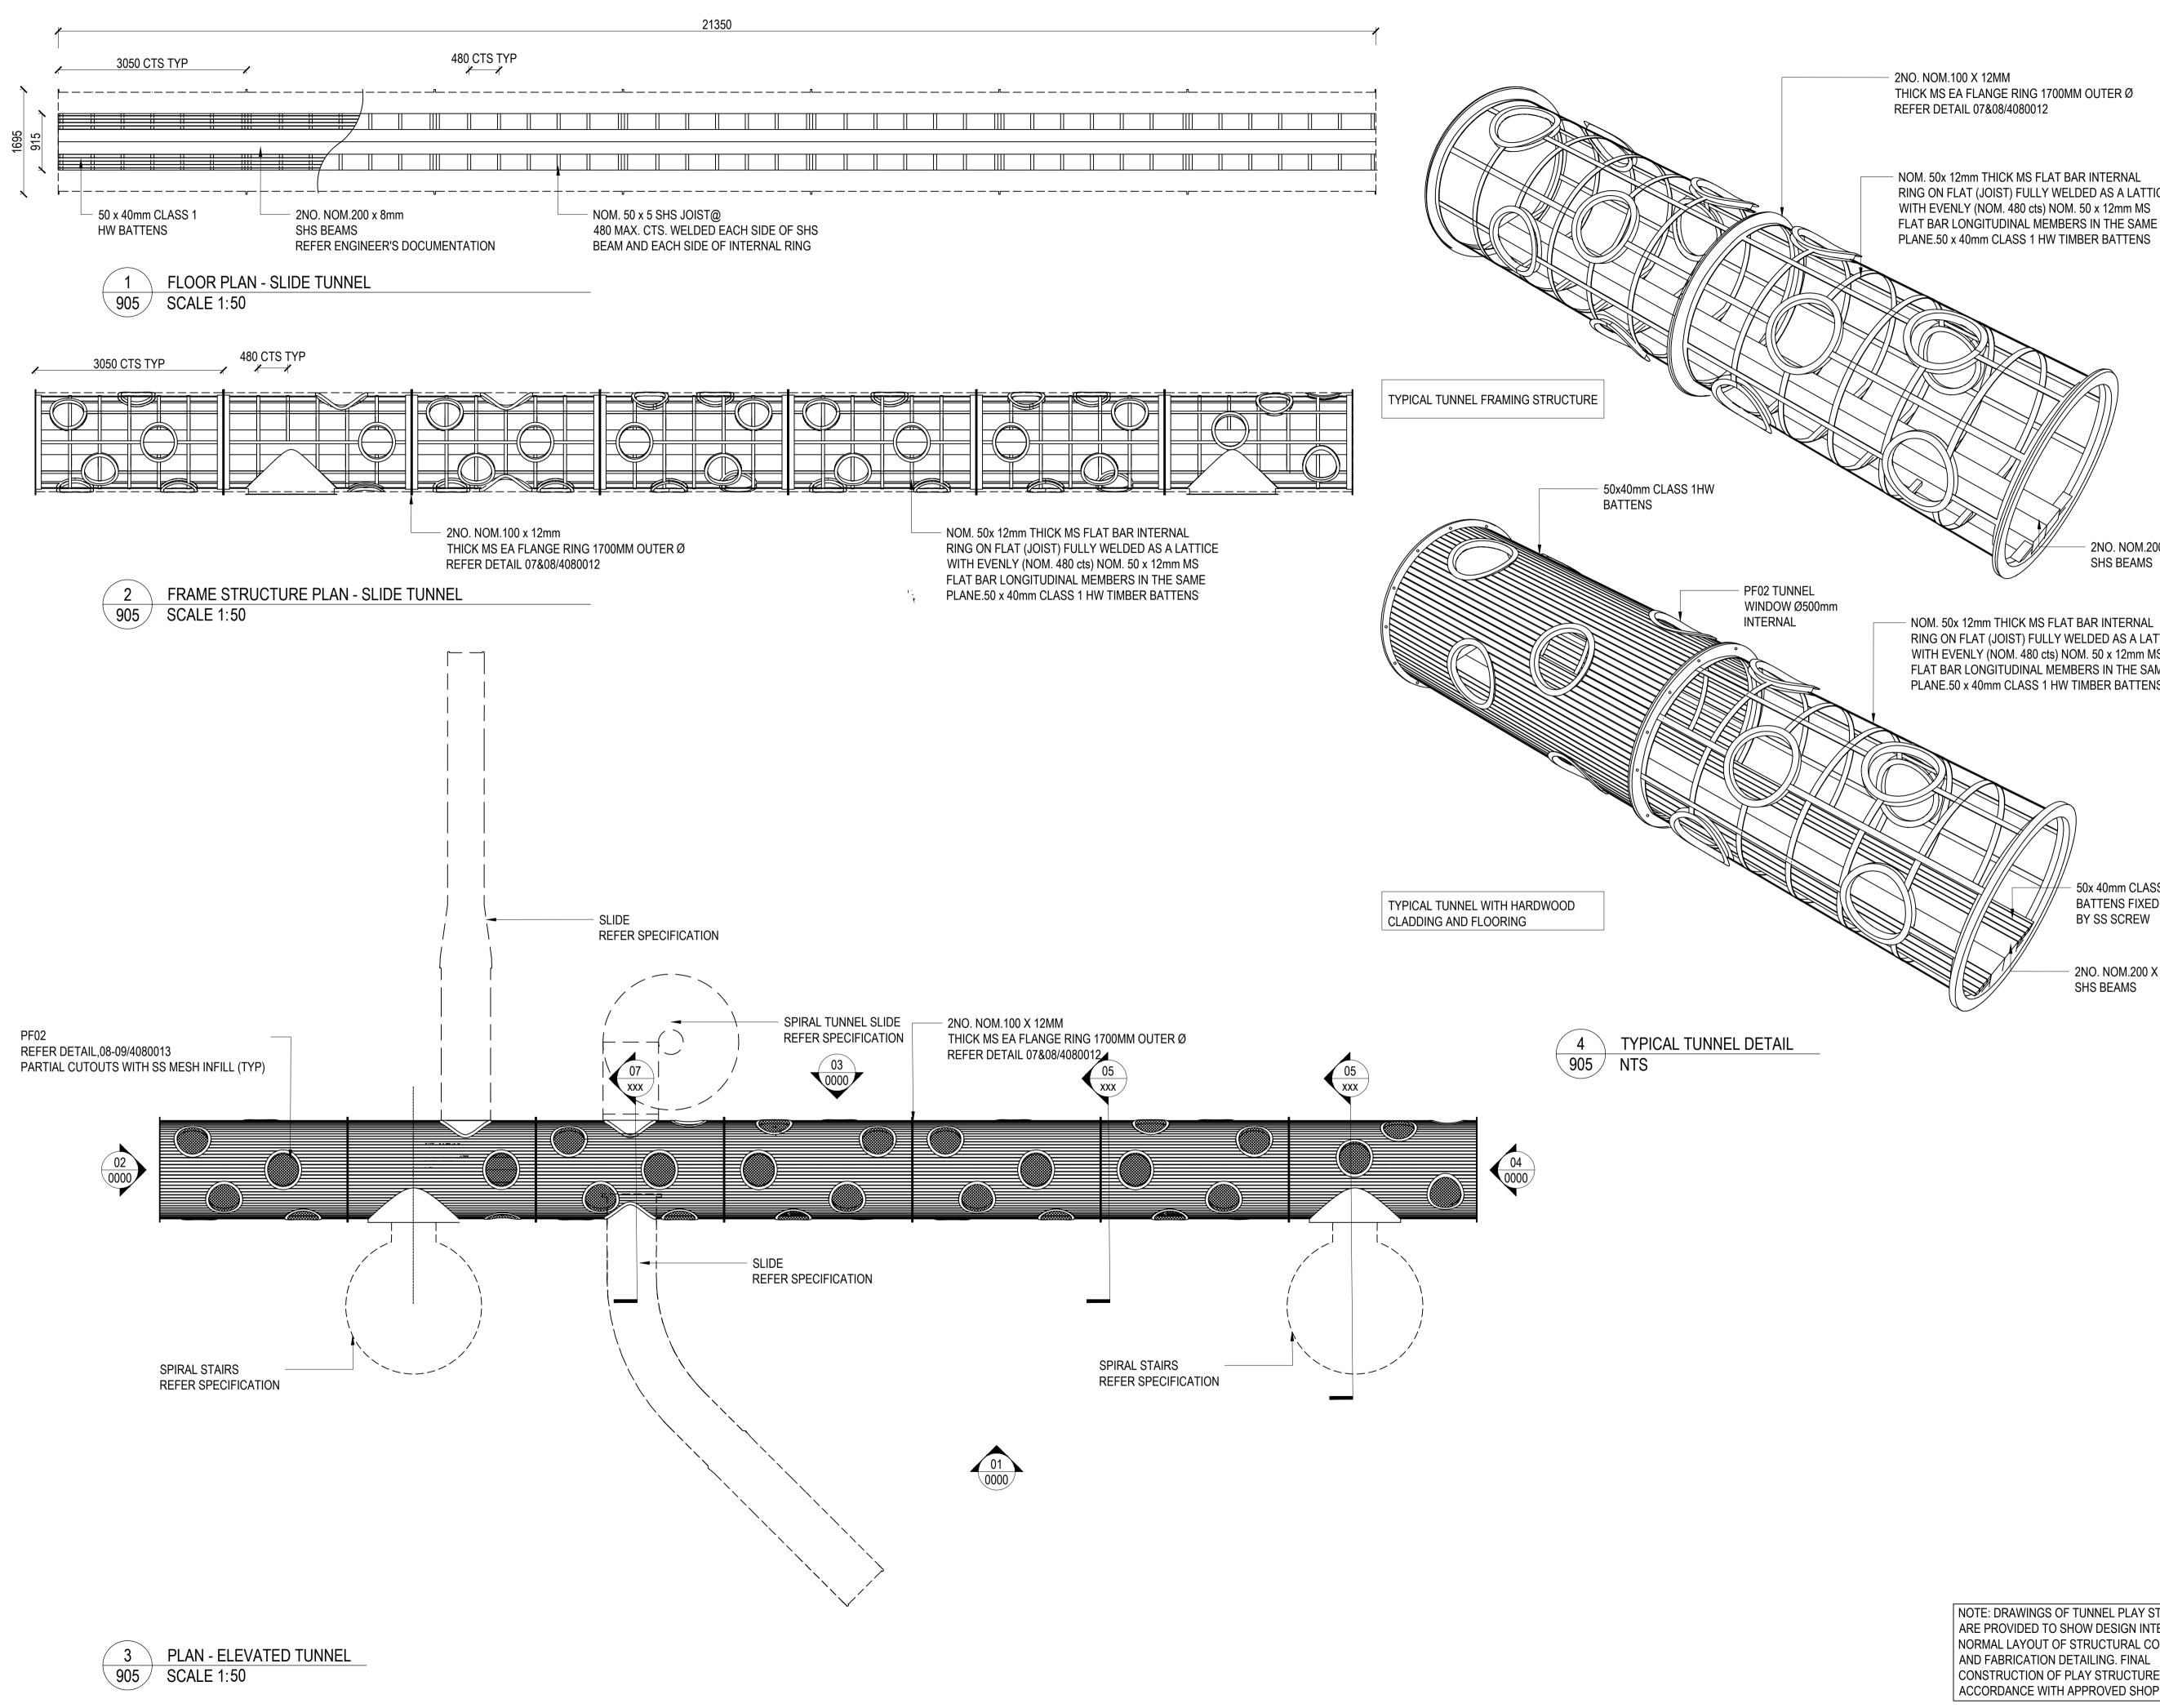
DESIGN : BP DOCUMENT : RH PROJECT : 2522146



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REVISION





RING ON FLAT (JOIST) FULLY WELDED AS A LATTICE

2NO. NOM.200 X 8MM SHS BEAMS

RING ON FLAT (JOIST) FULLY WELDED AS A LATTICE WITH EVENLY (NOM. 480 cts) NOM. 50 x 12mm MS FLAT BAR LONGITUDINAL MEMBERS IN THE SAME PLANE.50 x 40mm CLASS 1 HW TIMBER BATTENS

> 50x 40mm CLASS 1 HW BATTENS FIXED TO SHS JOISTS

2NO. NOM.200 X 8MM

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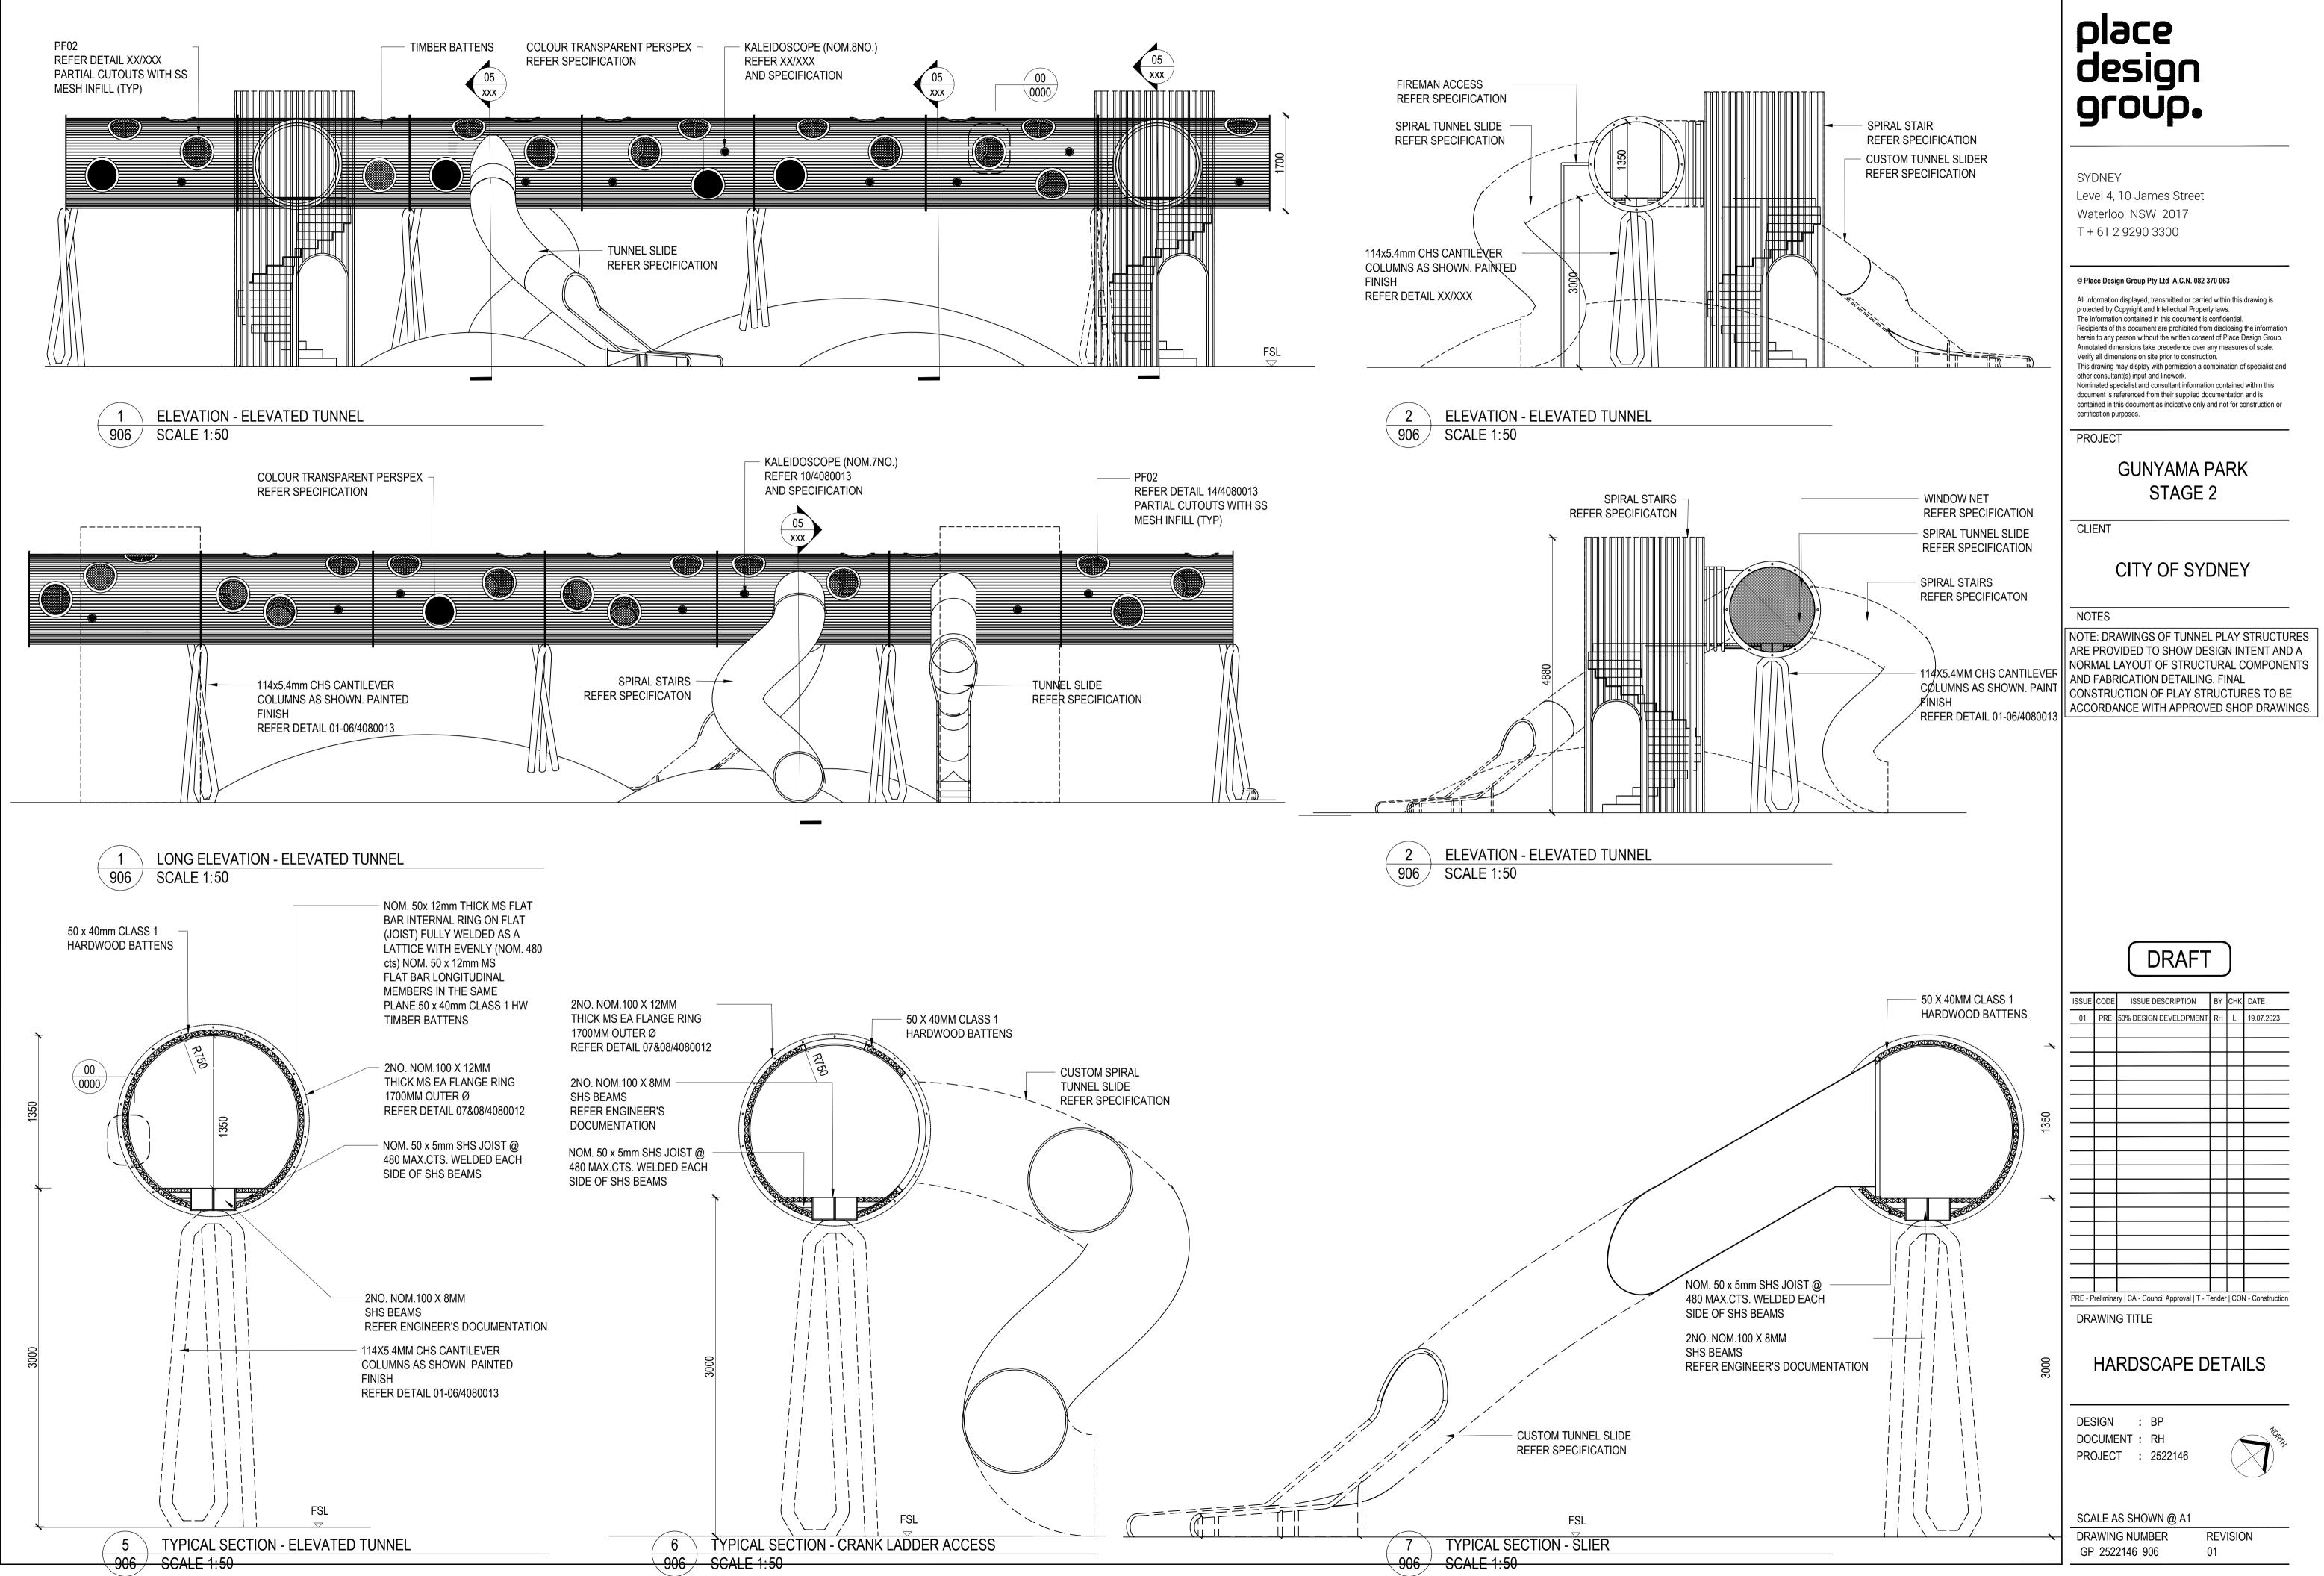
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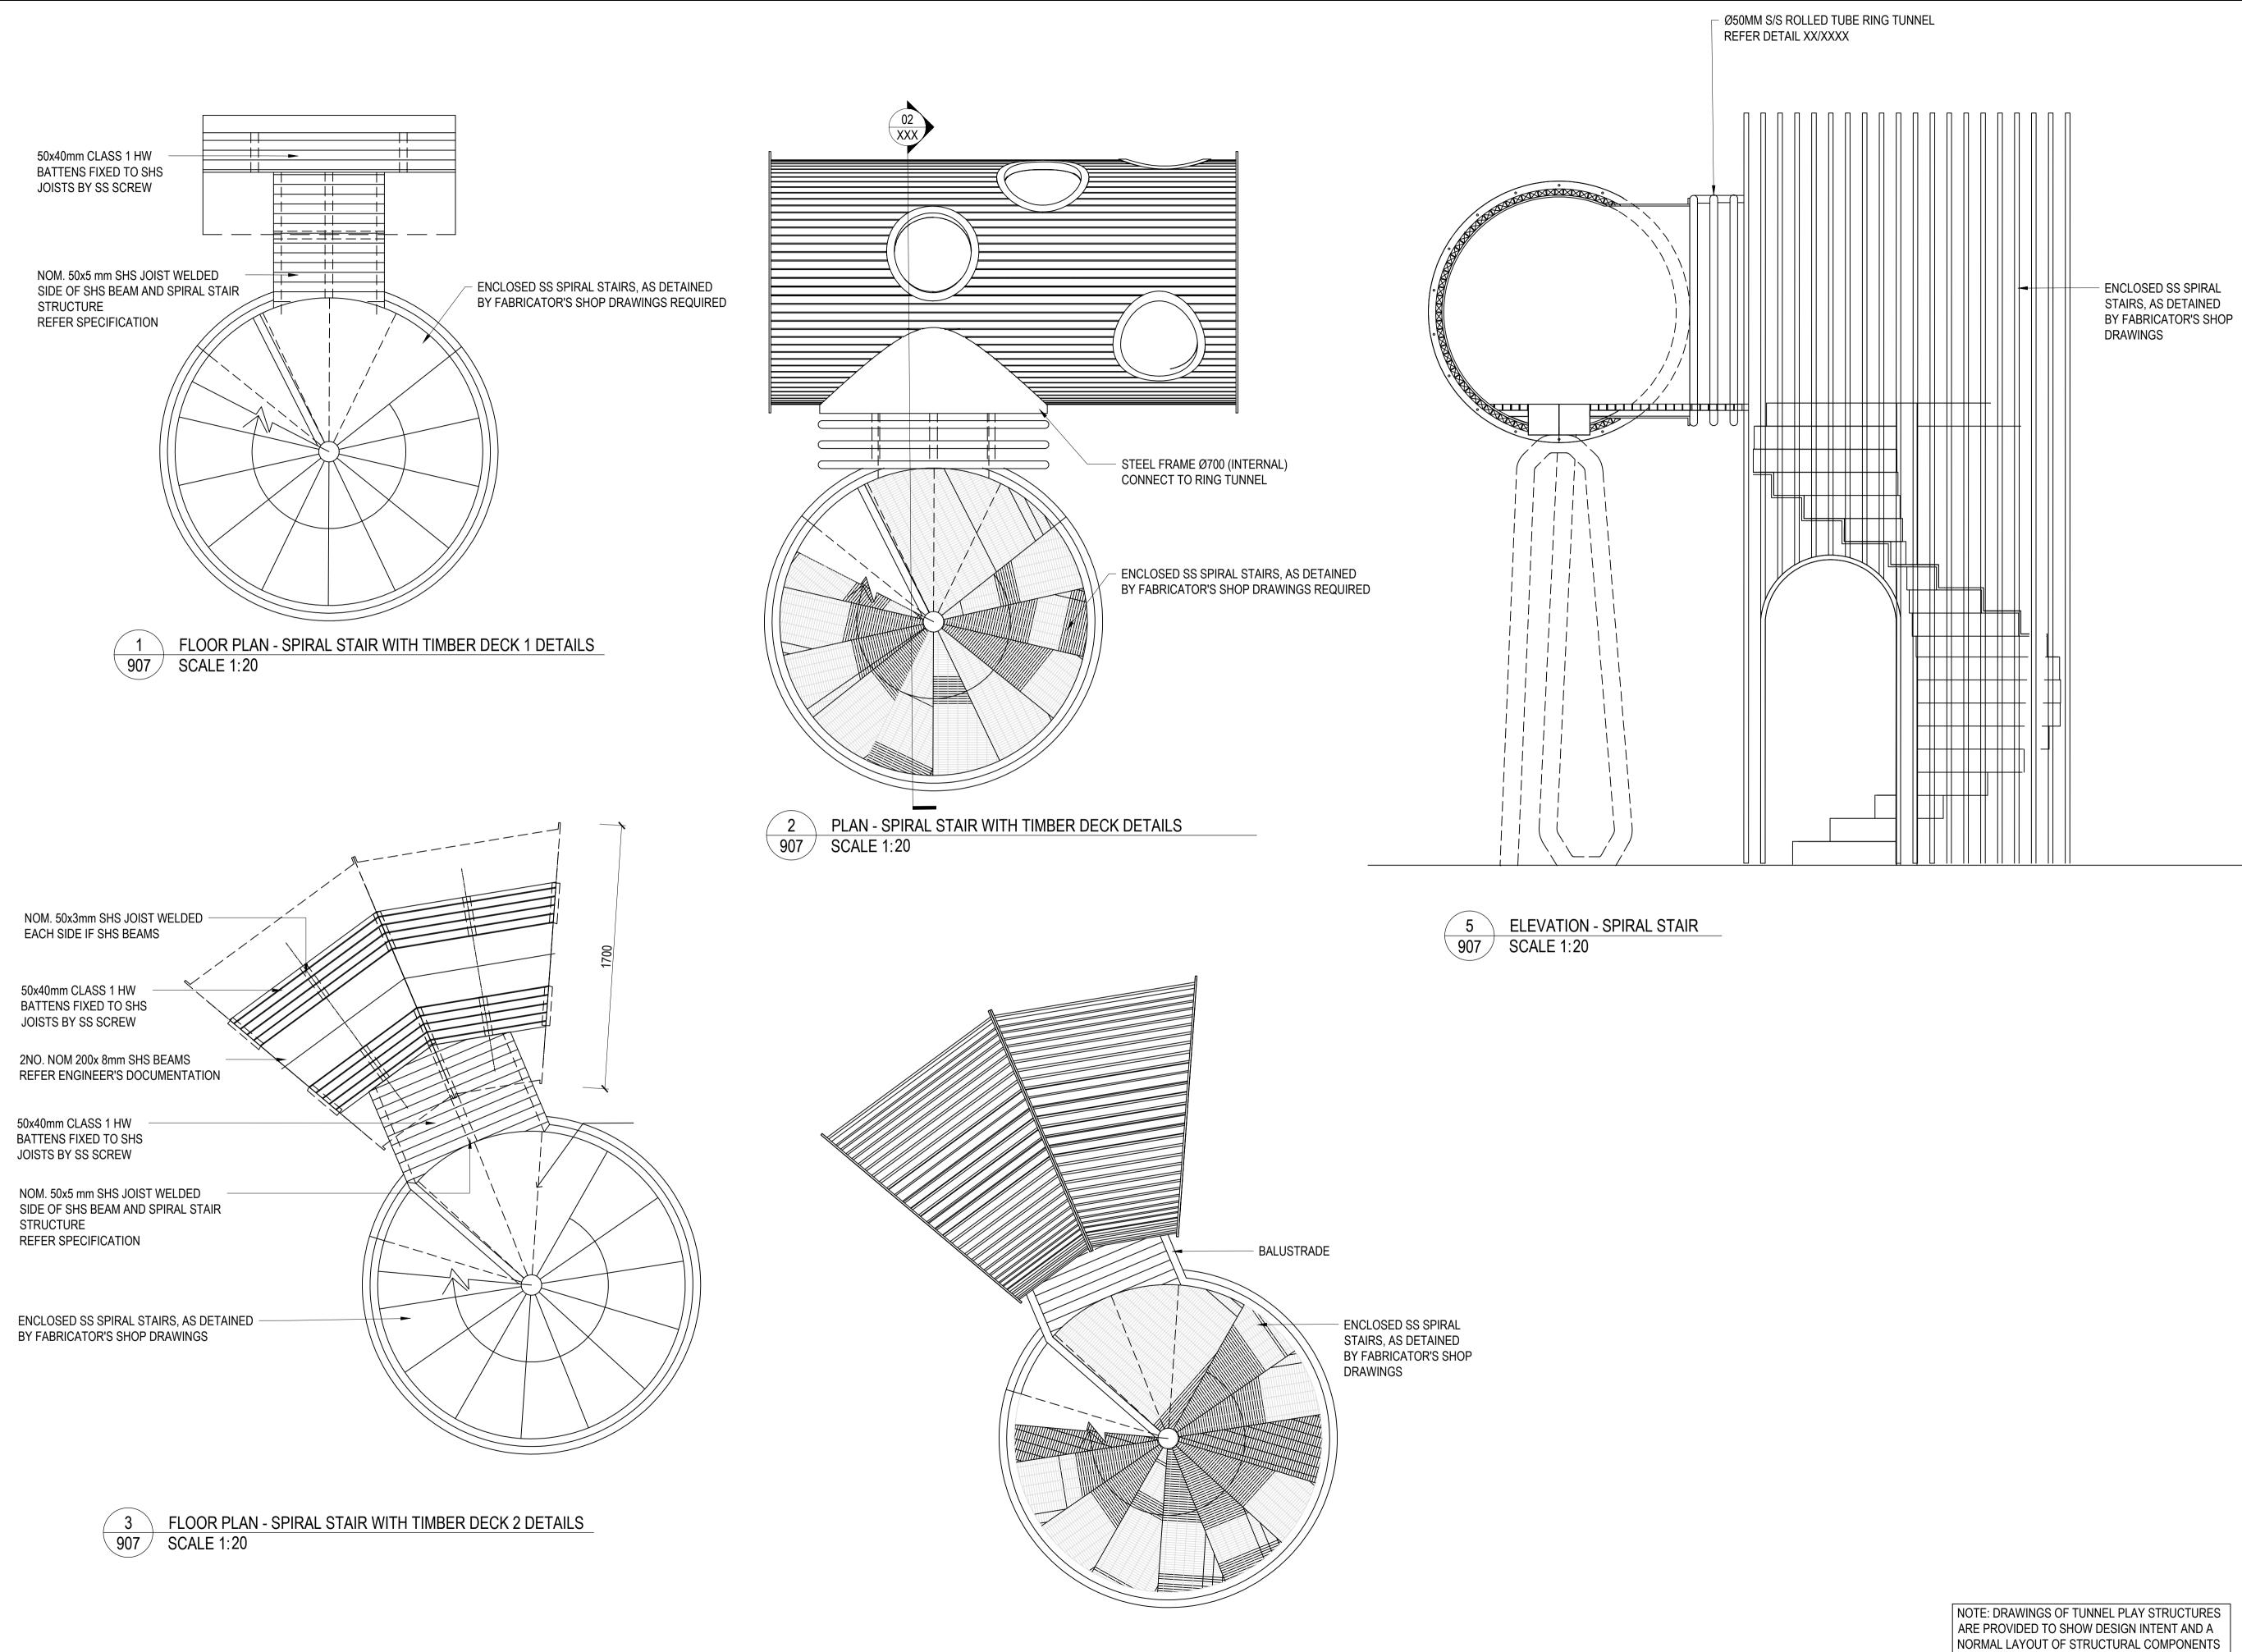


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REVISION 01

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PLAN - SPIRAL STAIR WITH TIMBER DECK 2 DETAILS

′ <u>4</u> `

907 SCALE 1:20



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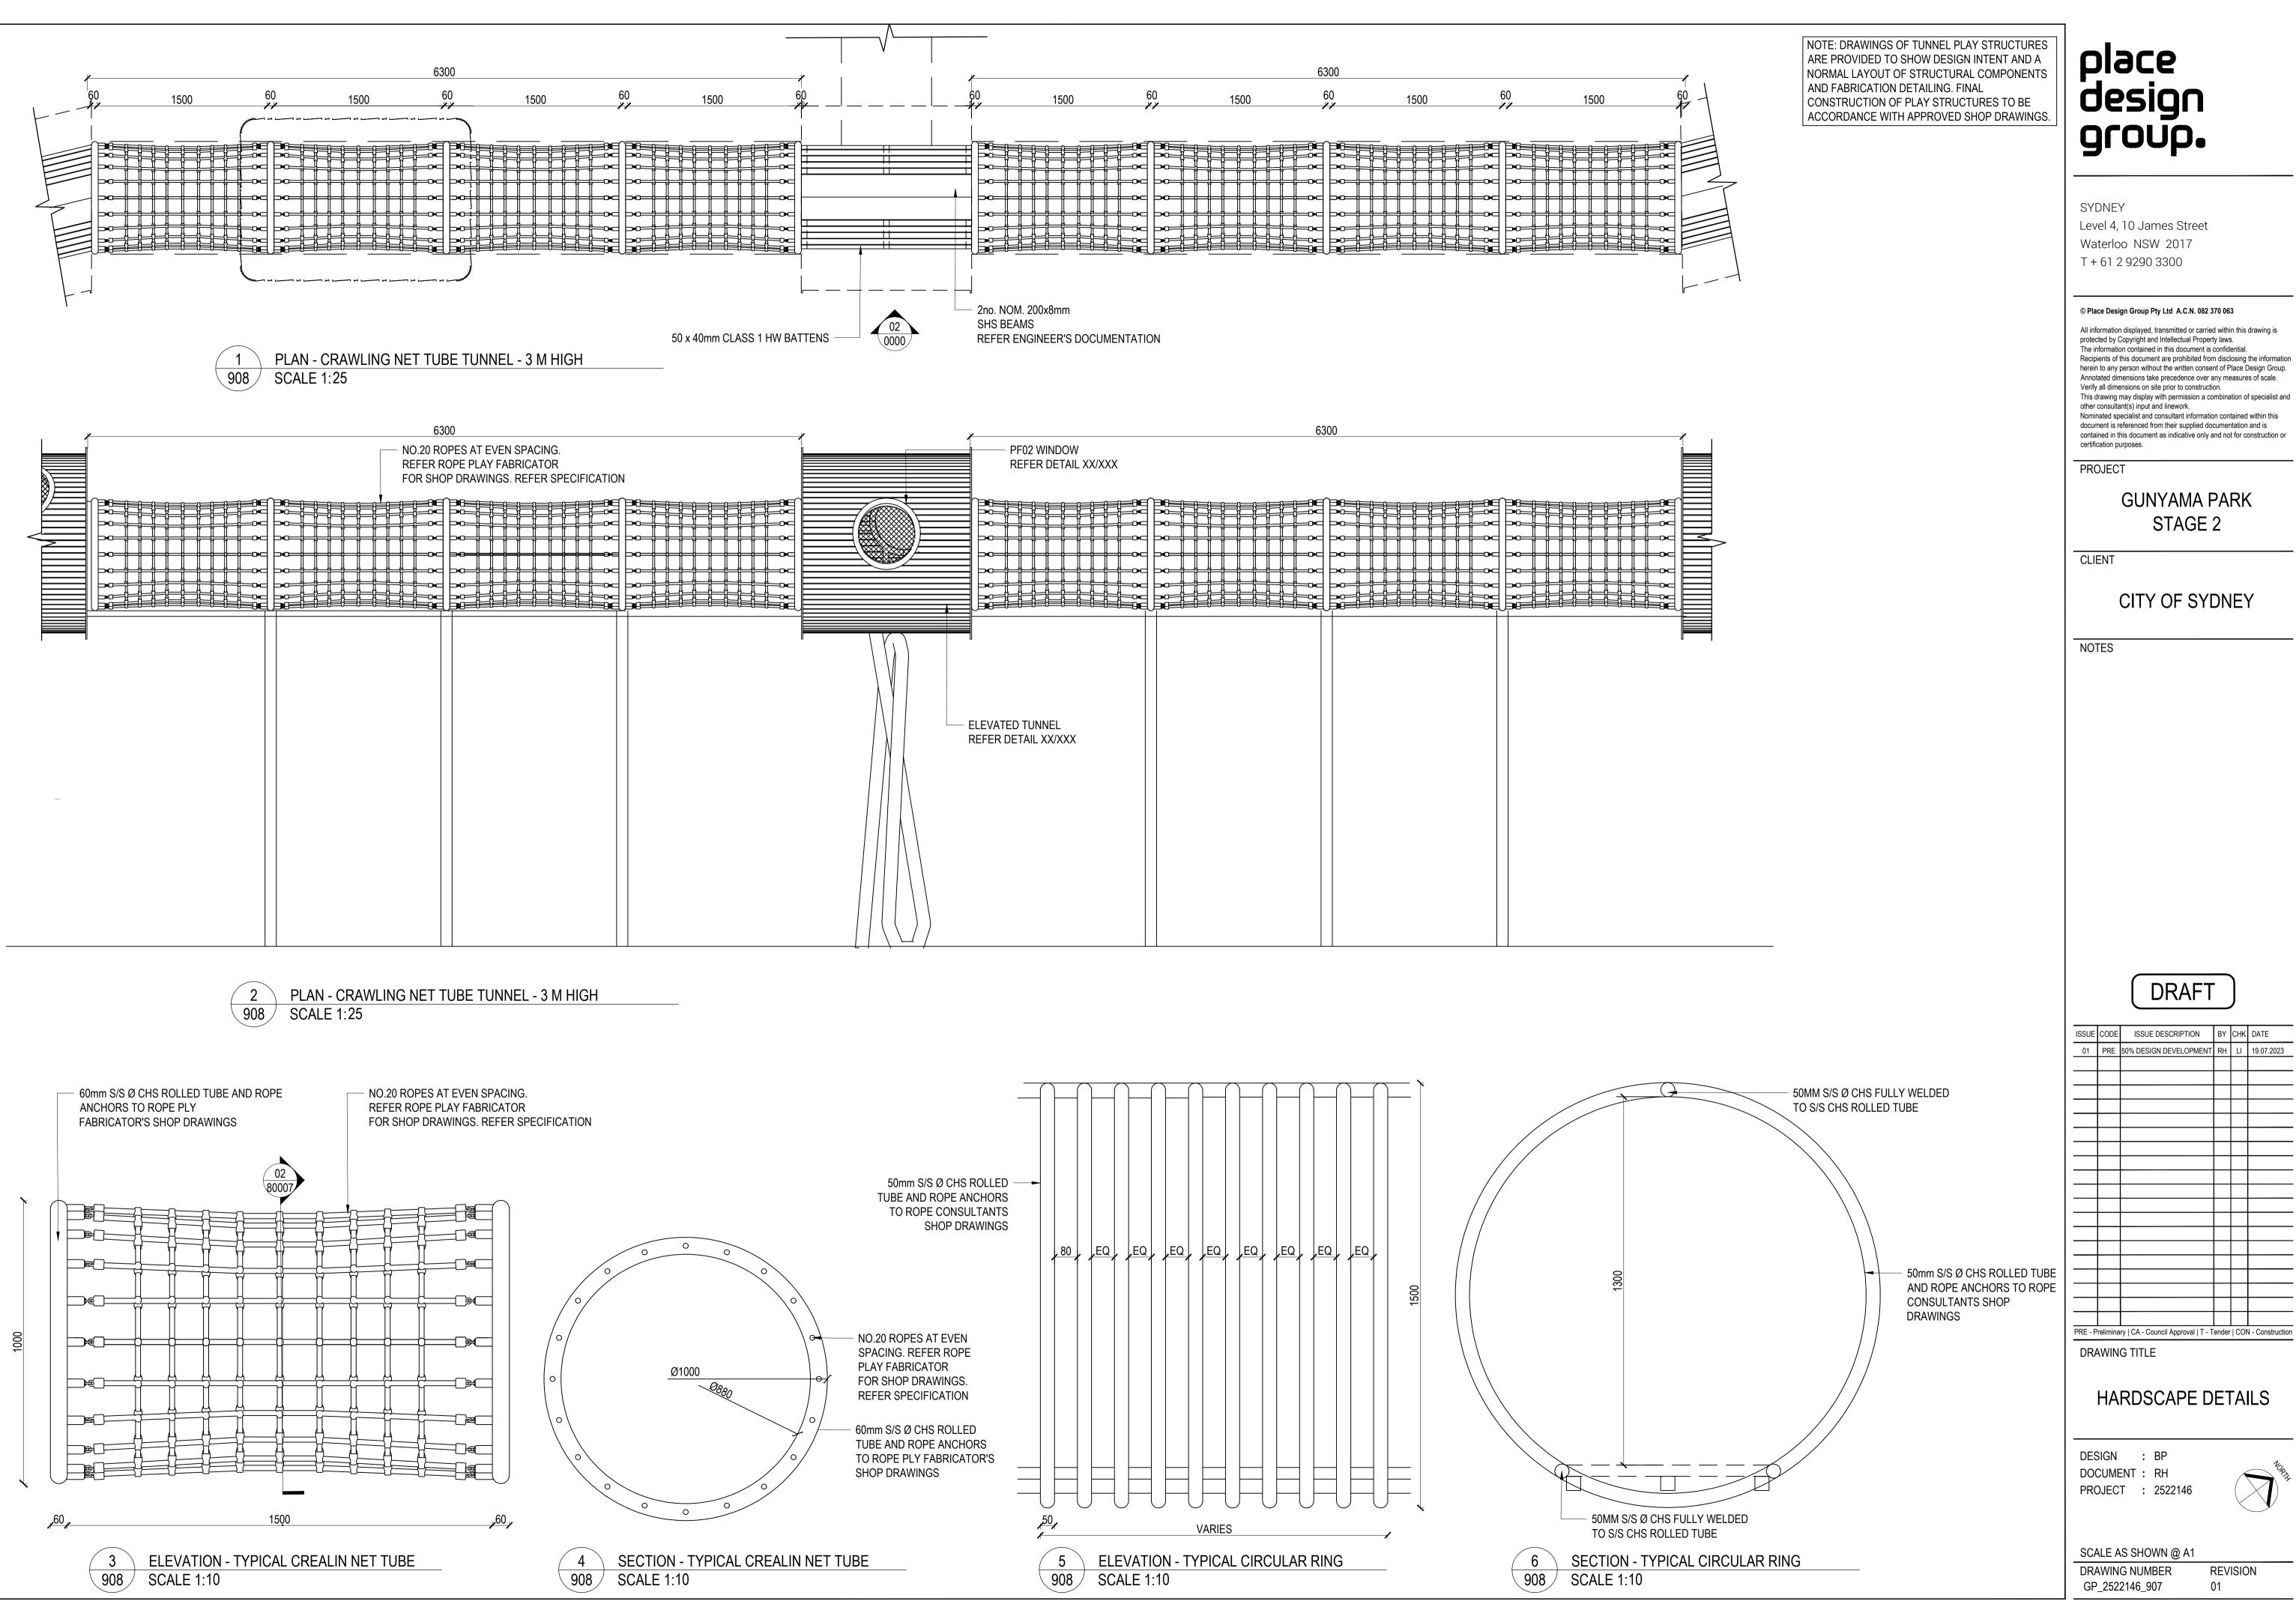
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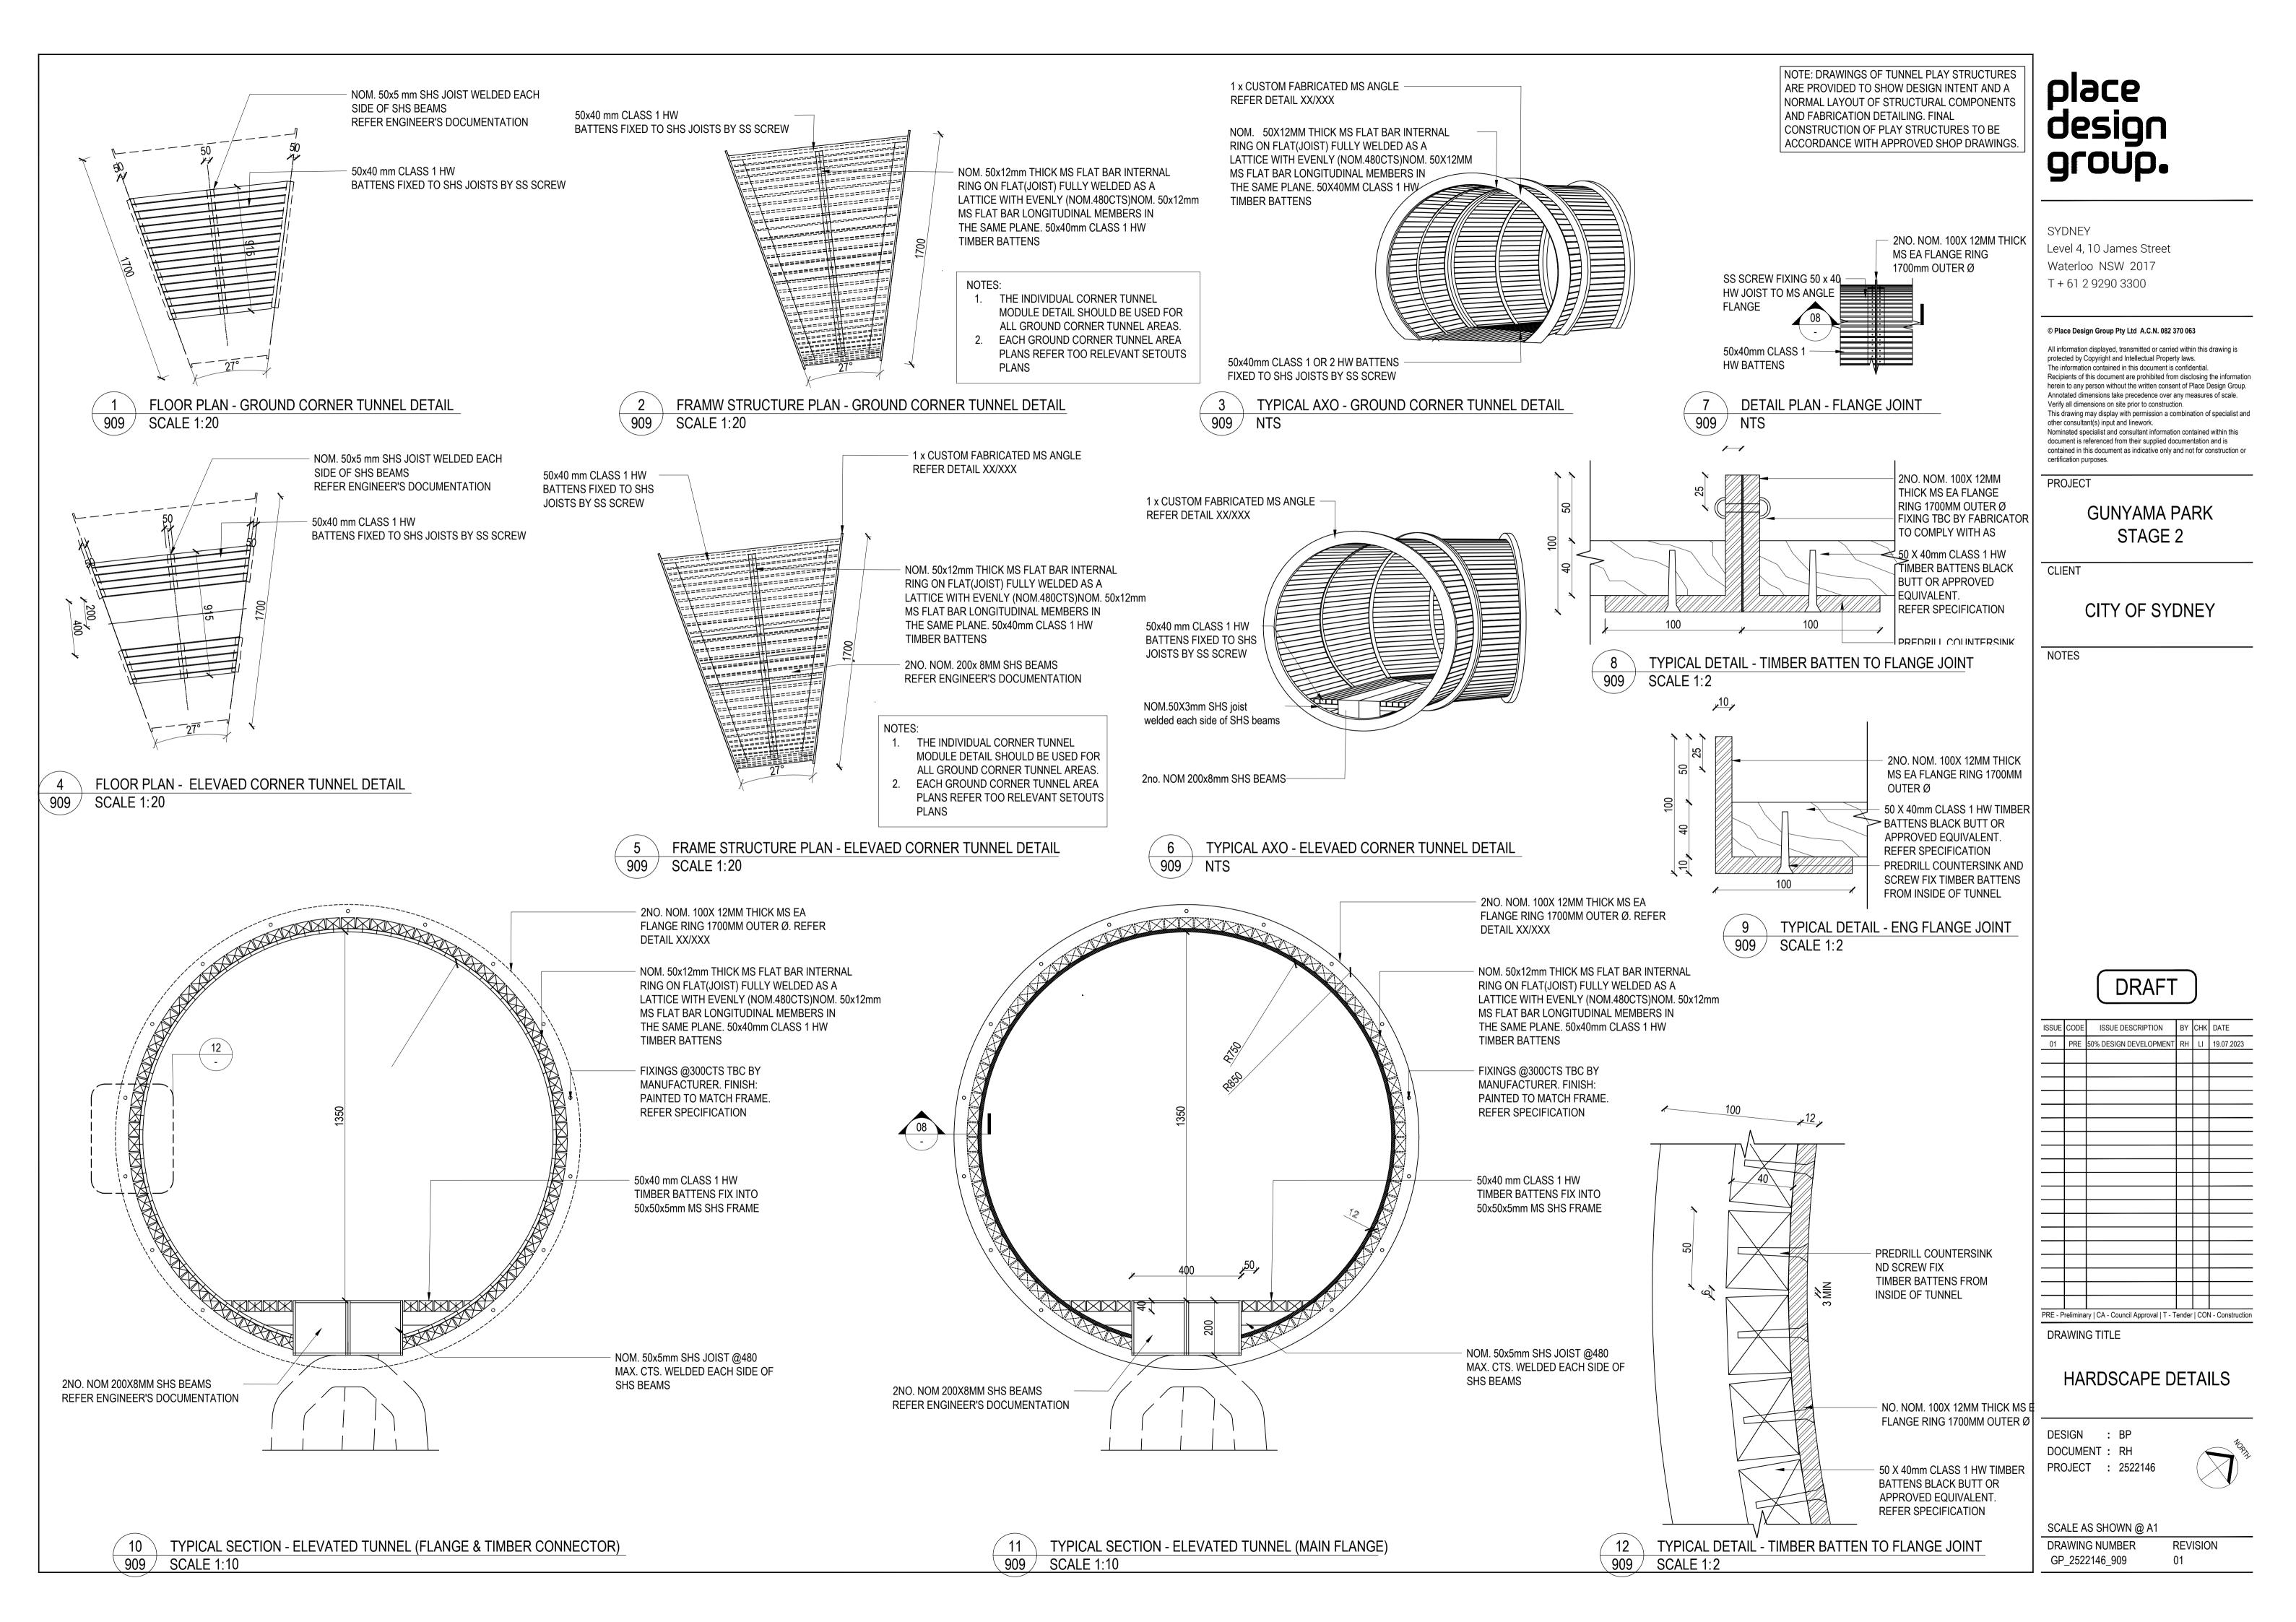



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EVISION

NORMAL LAYOUT OF STRUCTURAL COMPONENTS AND FABRICATION DETAILING. FINAL CONSTRUCTION OF PLAY STRUCTURES TO BE ACCORDANCE WITH APPROVED SHOP DRAWINGS.





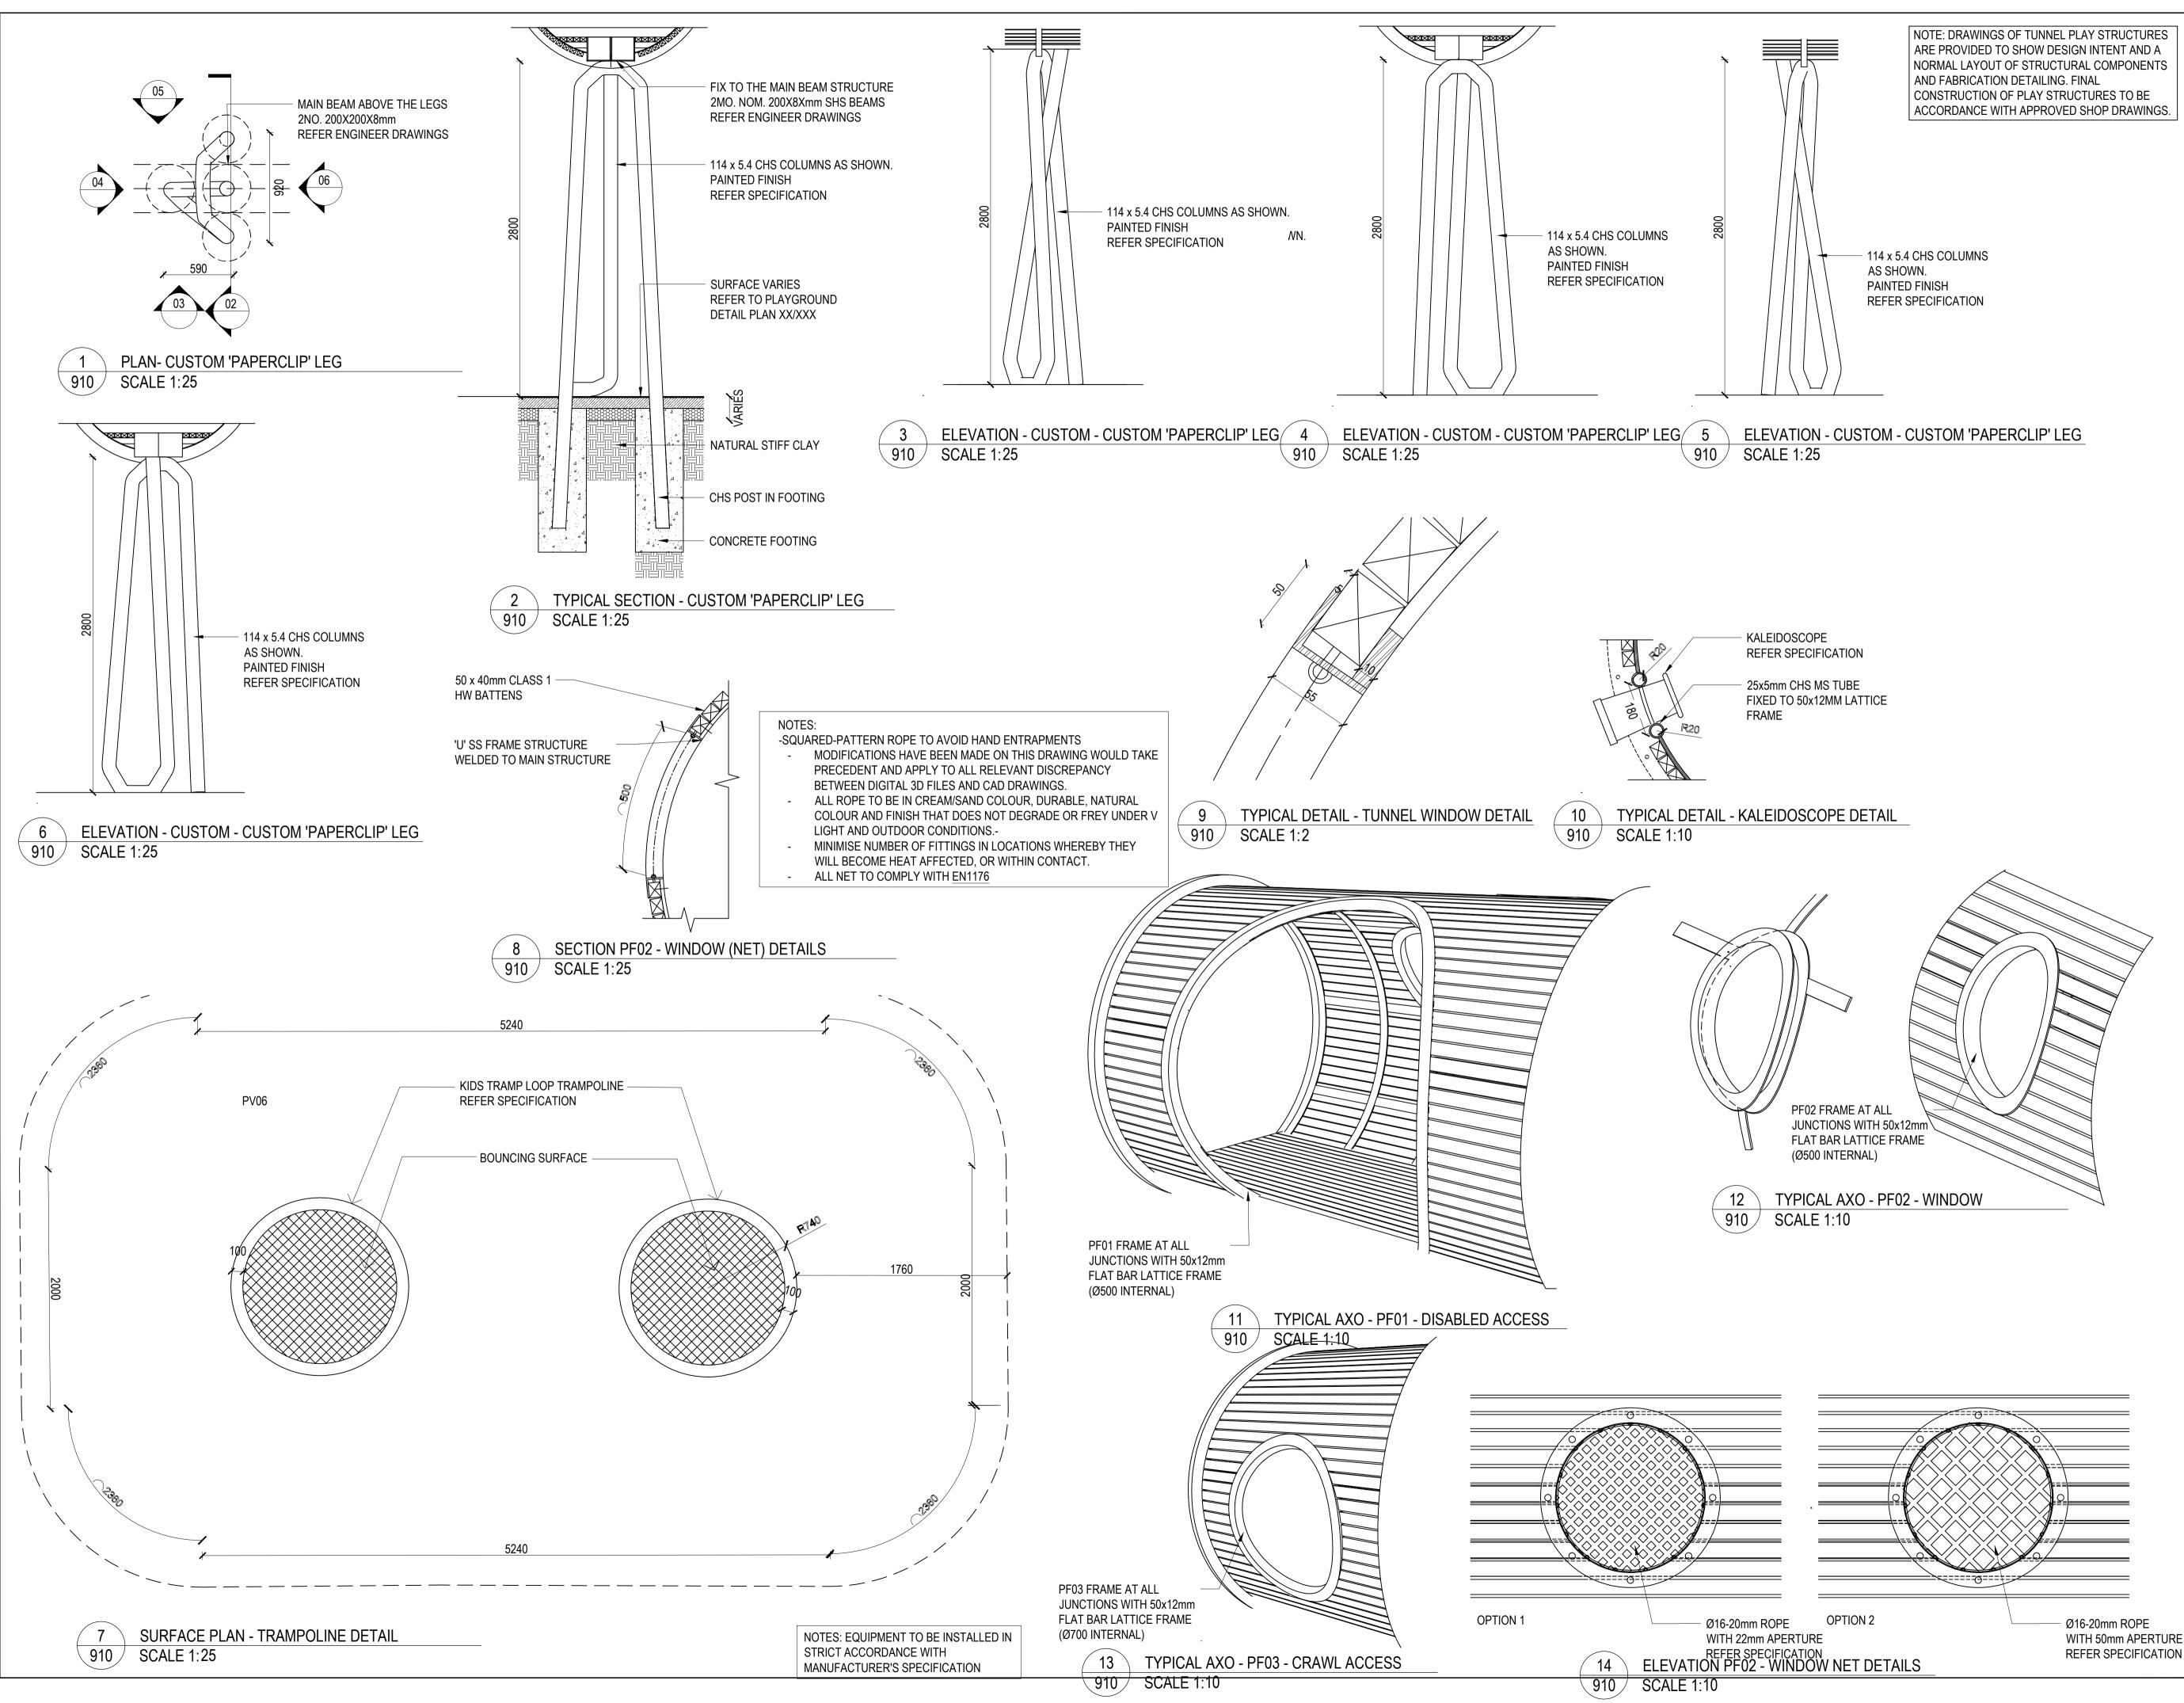

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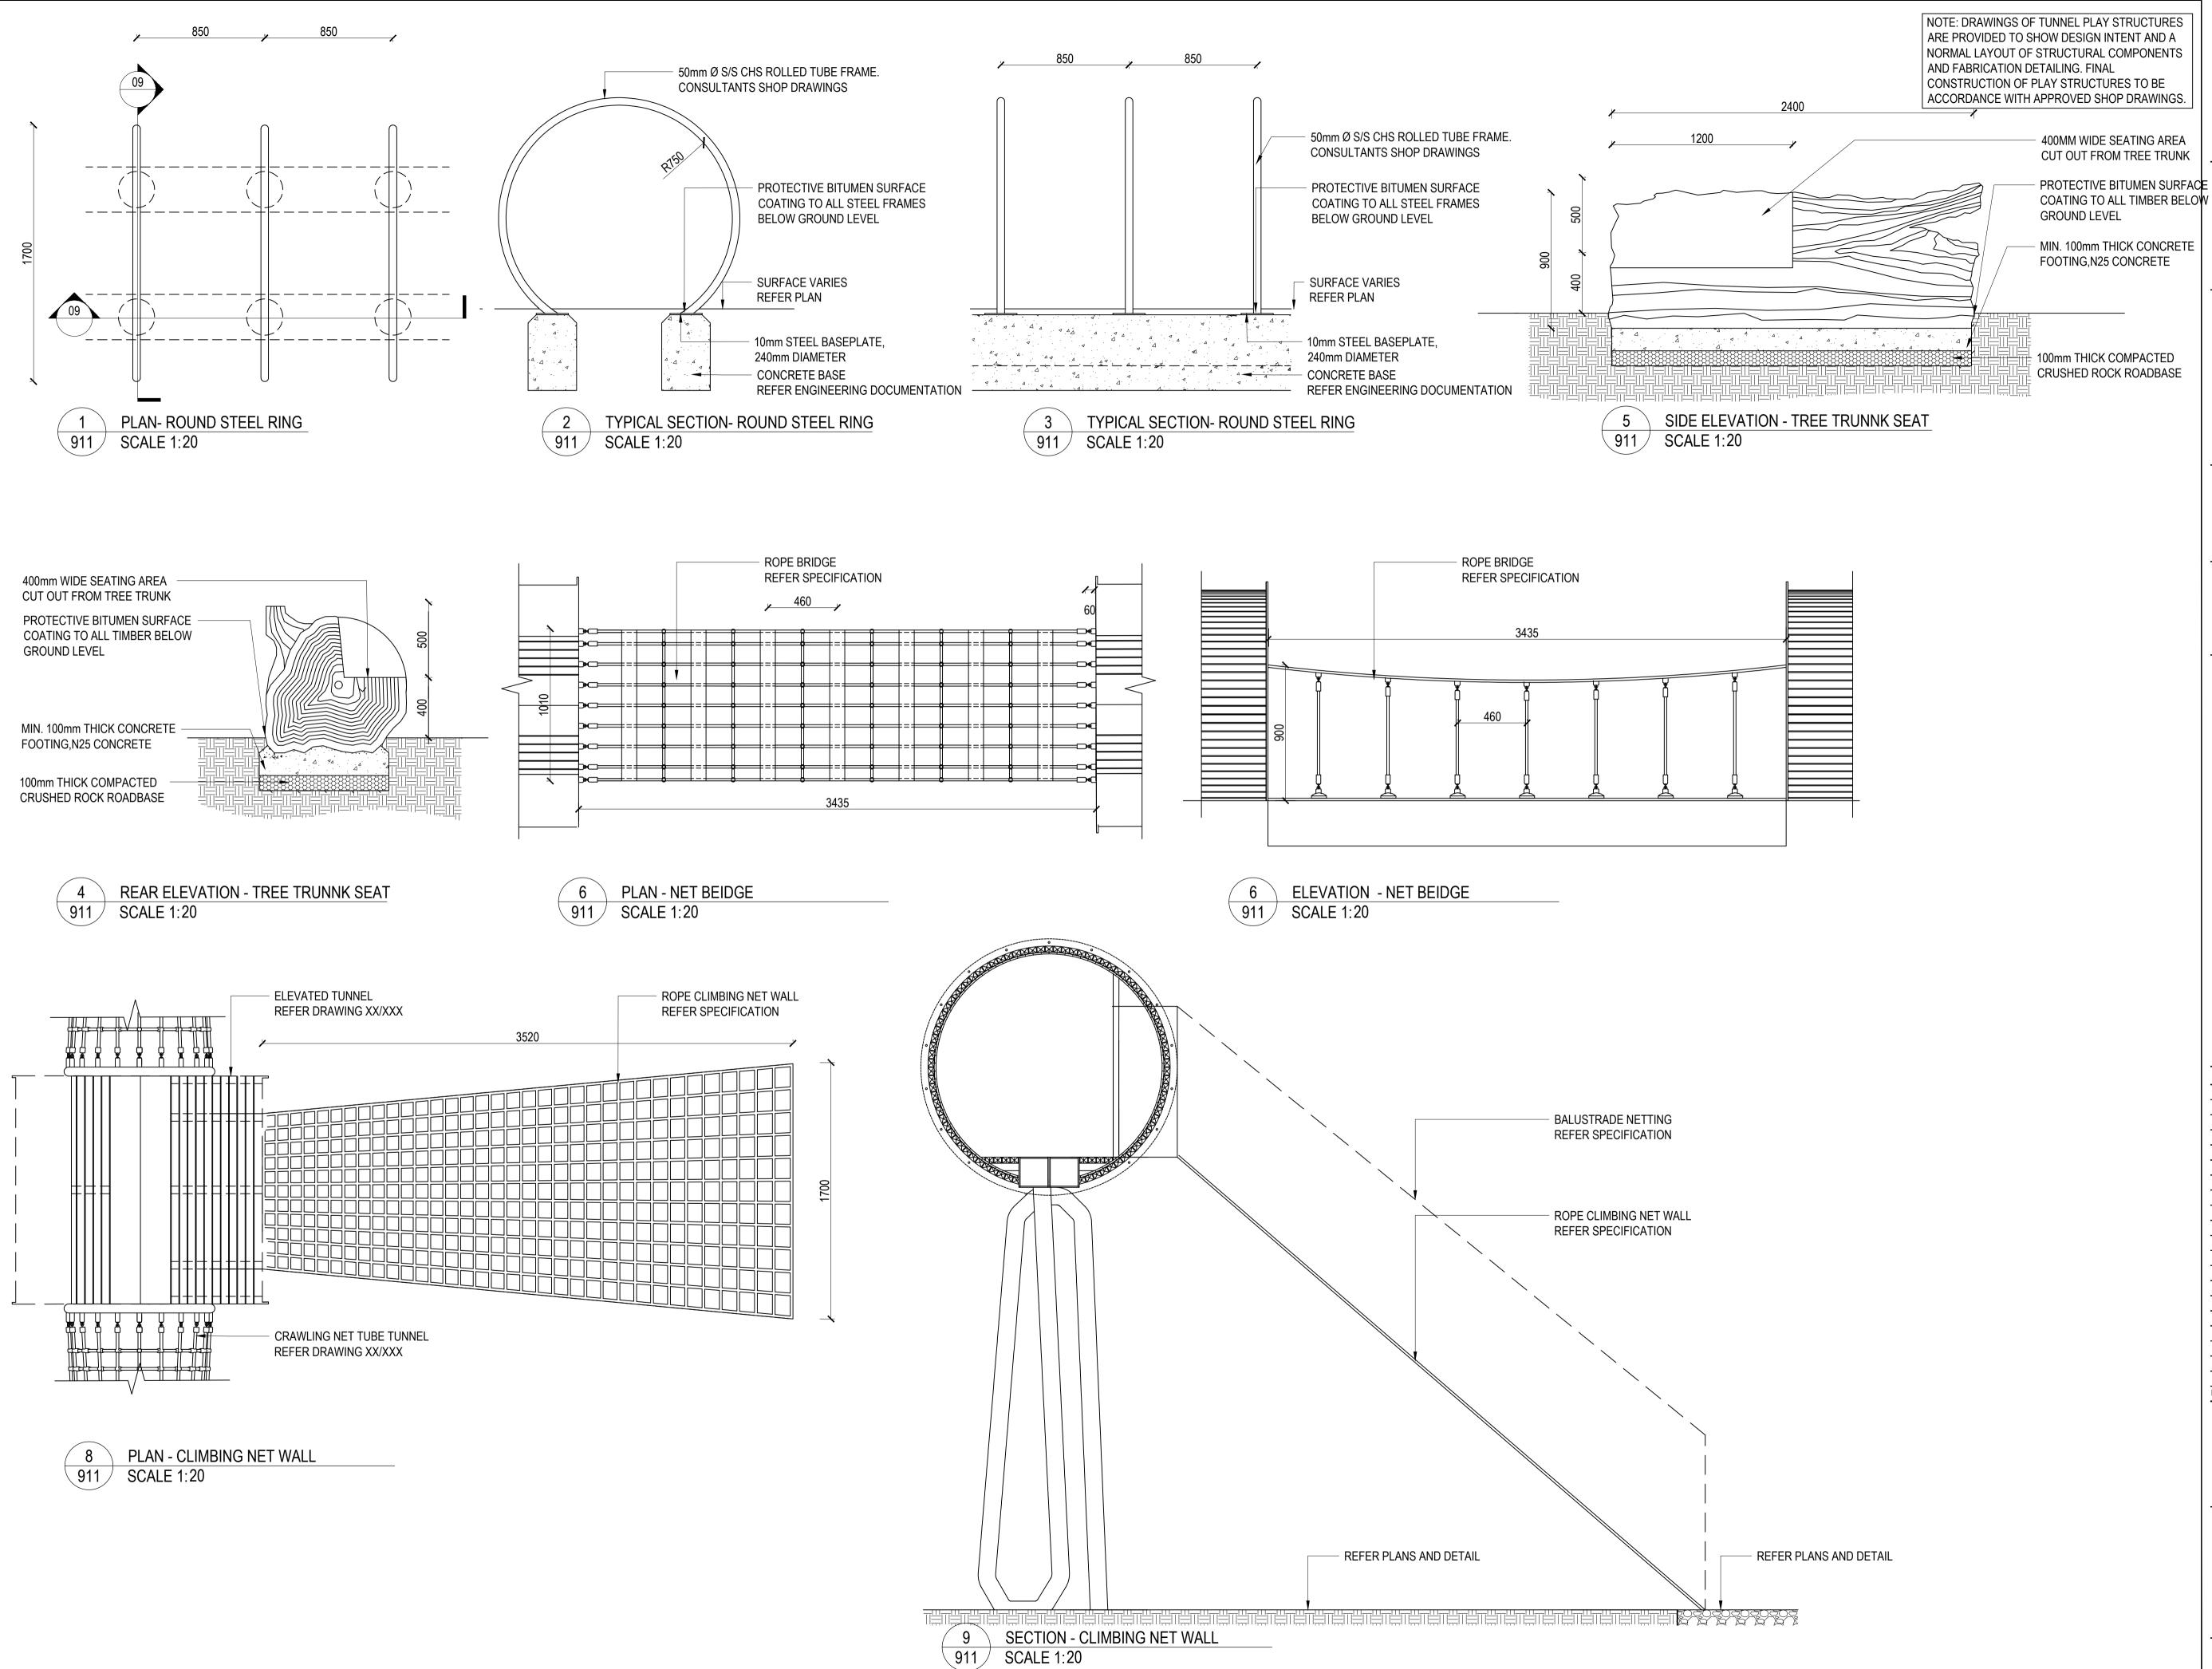
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DESIGN : BP DOCUMENT : RH PROJECT : 2522146



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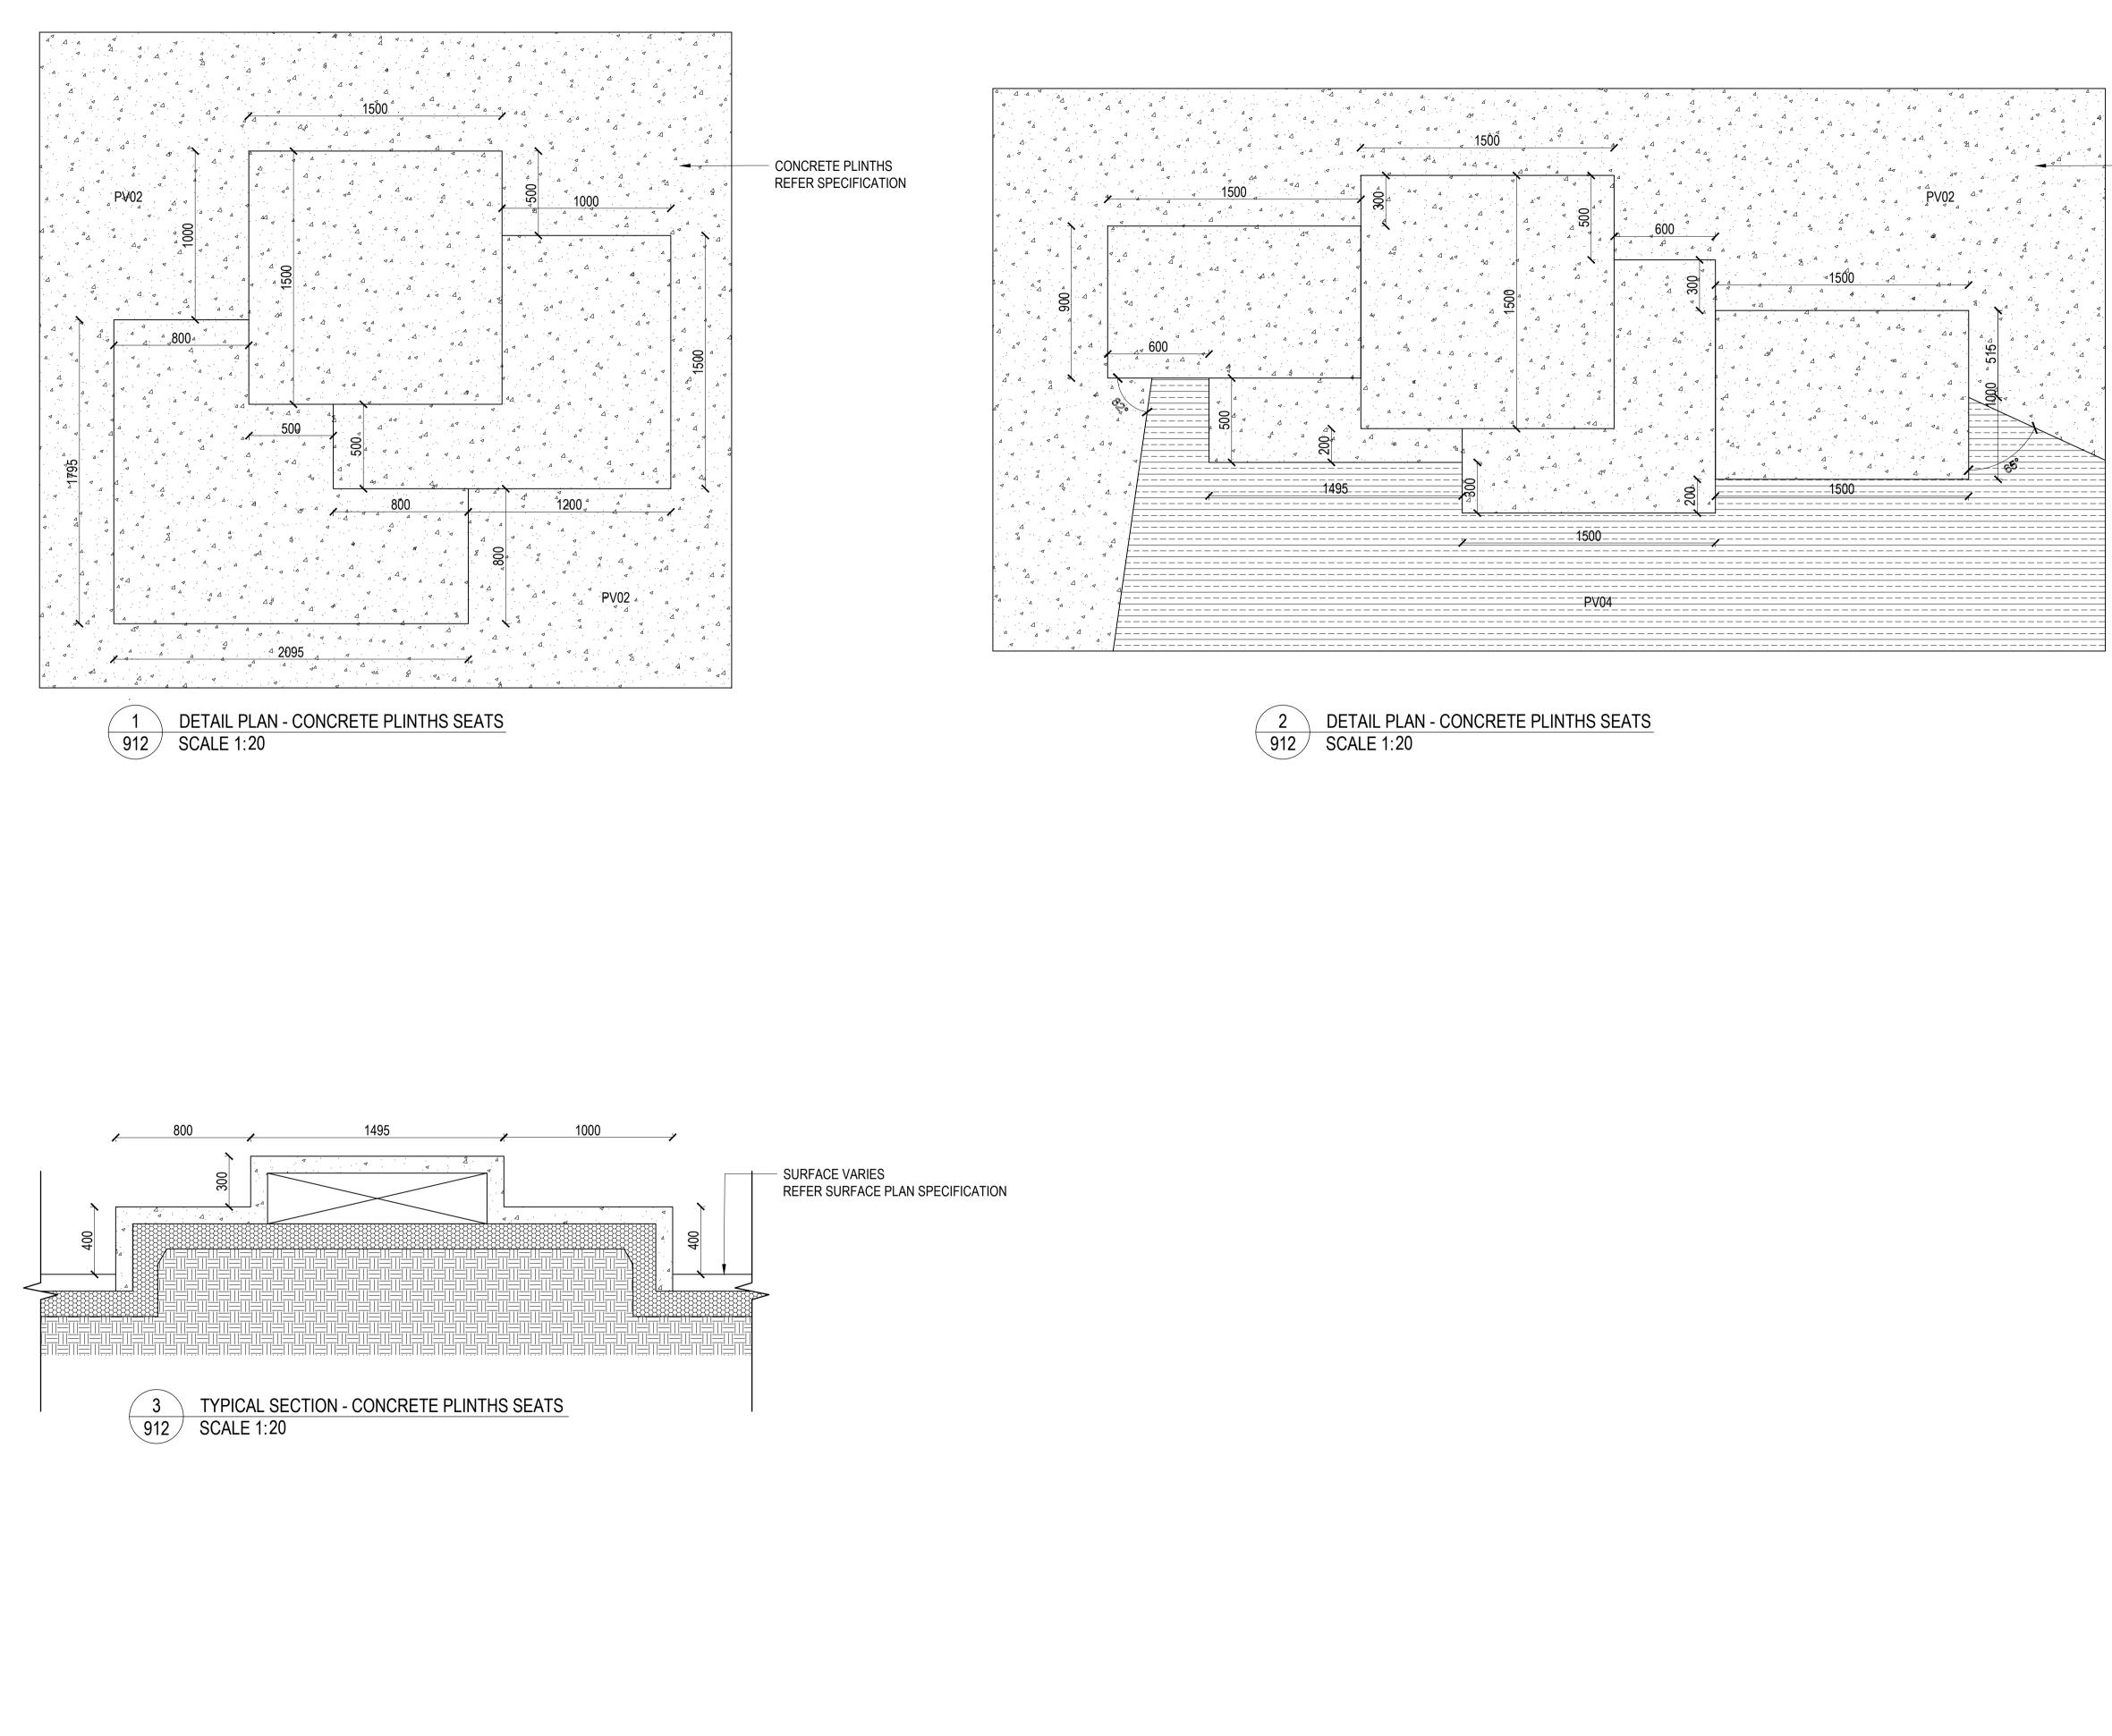
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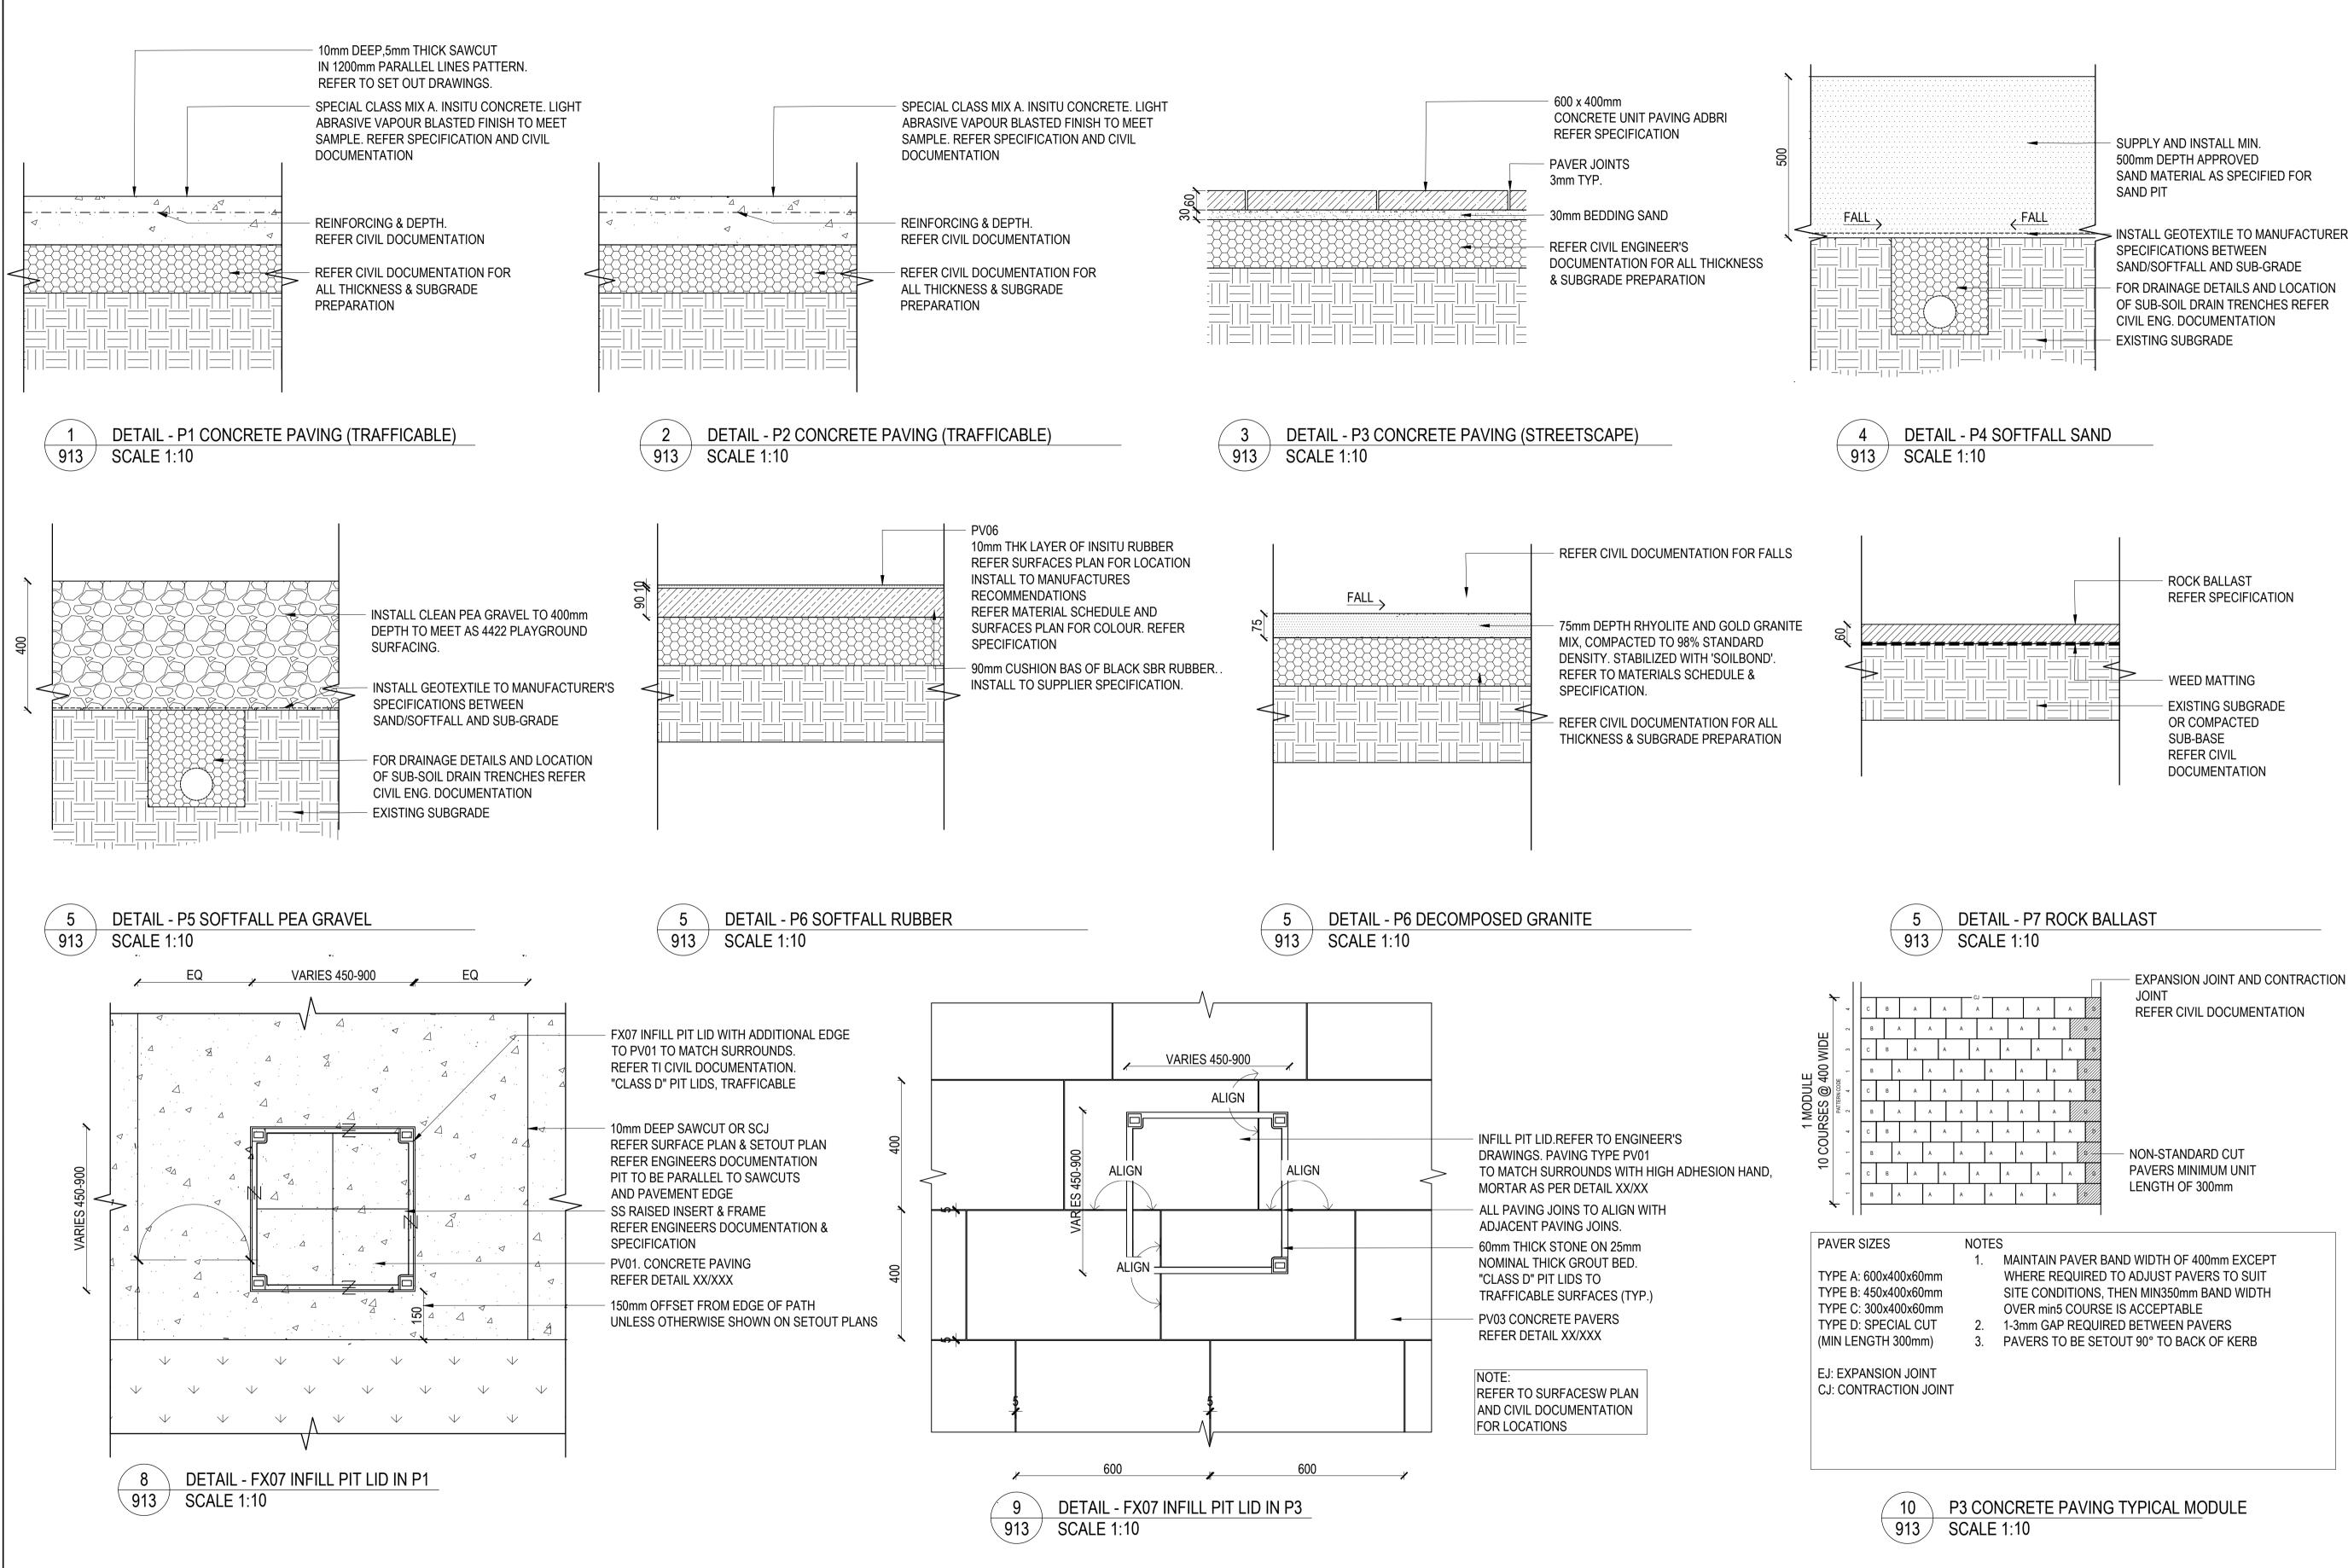
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NOTES

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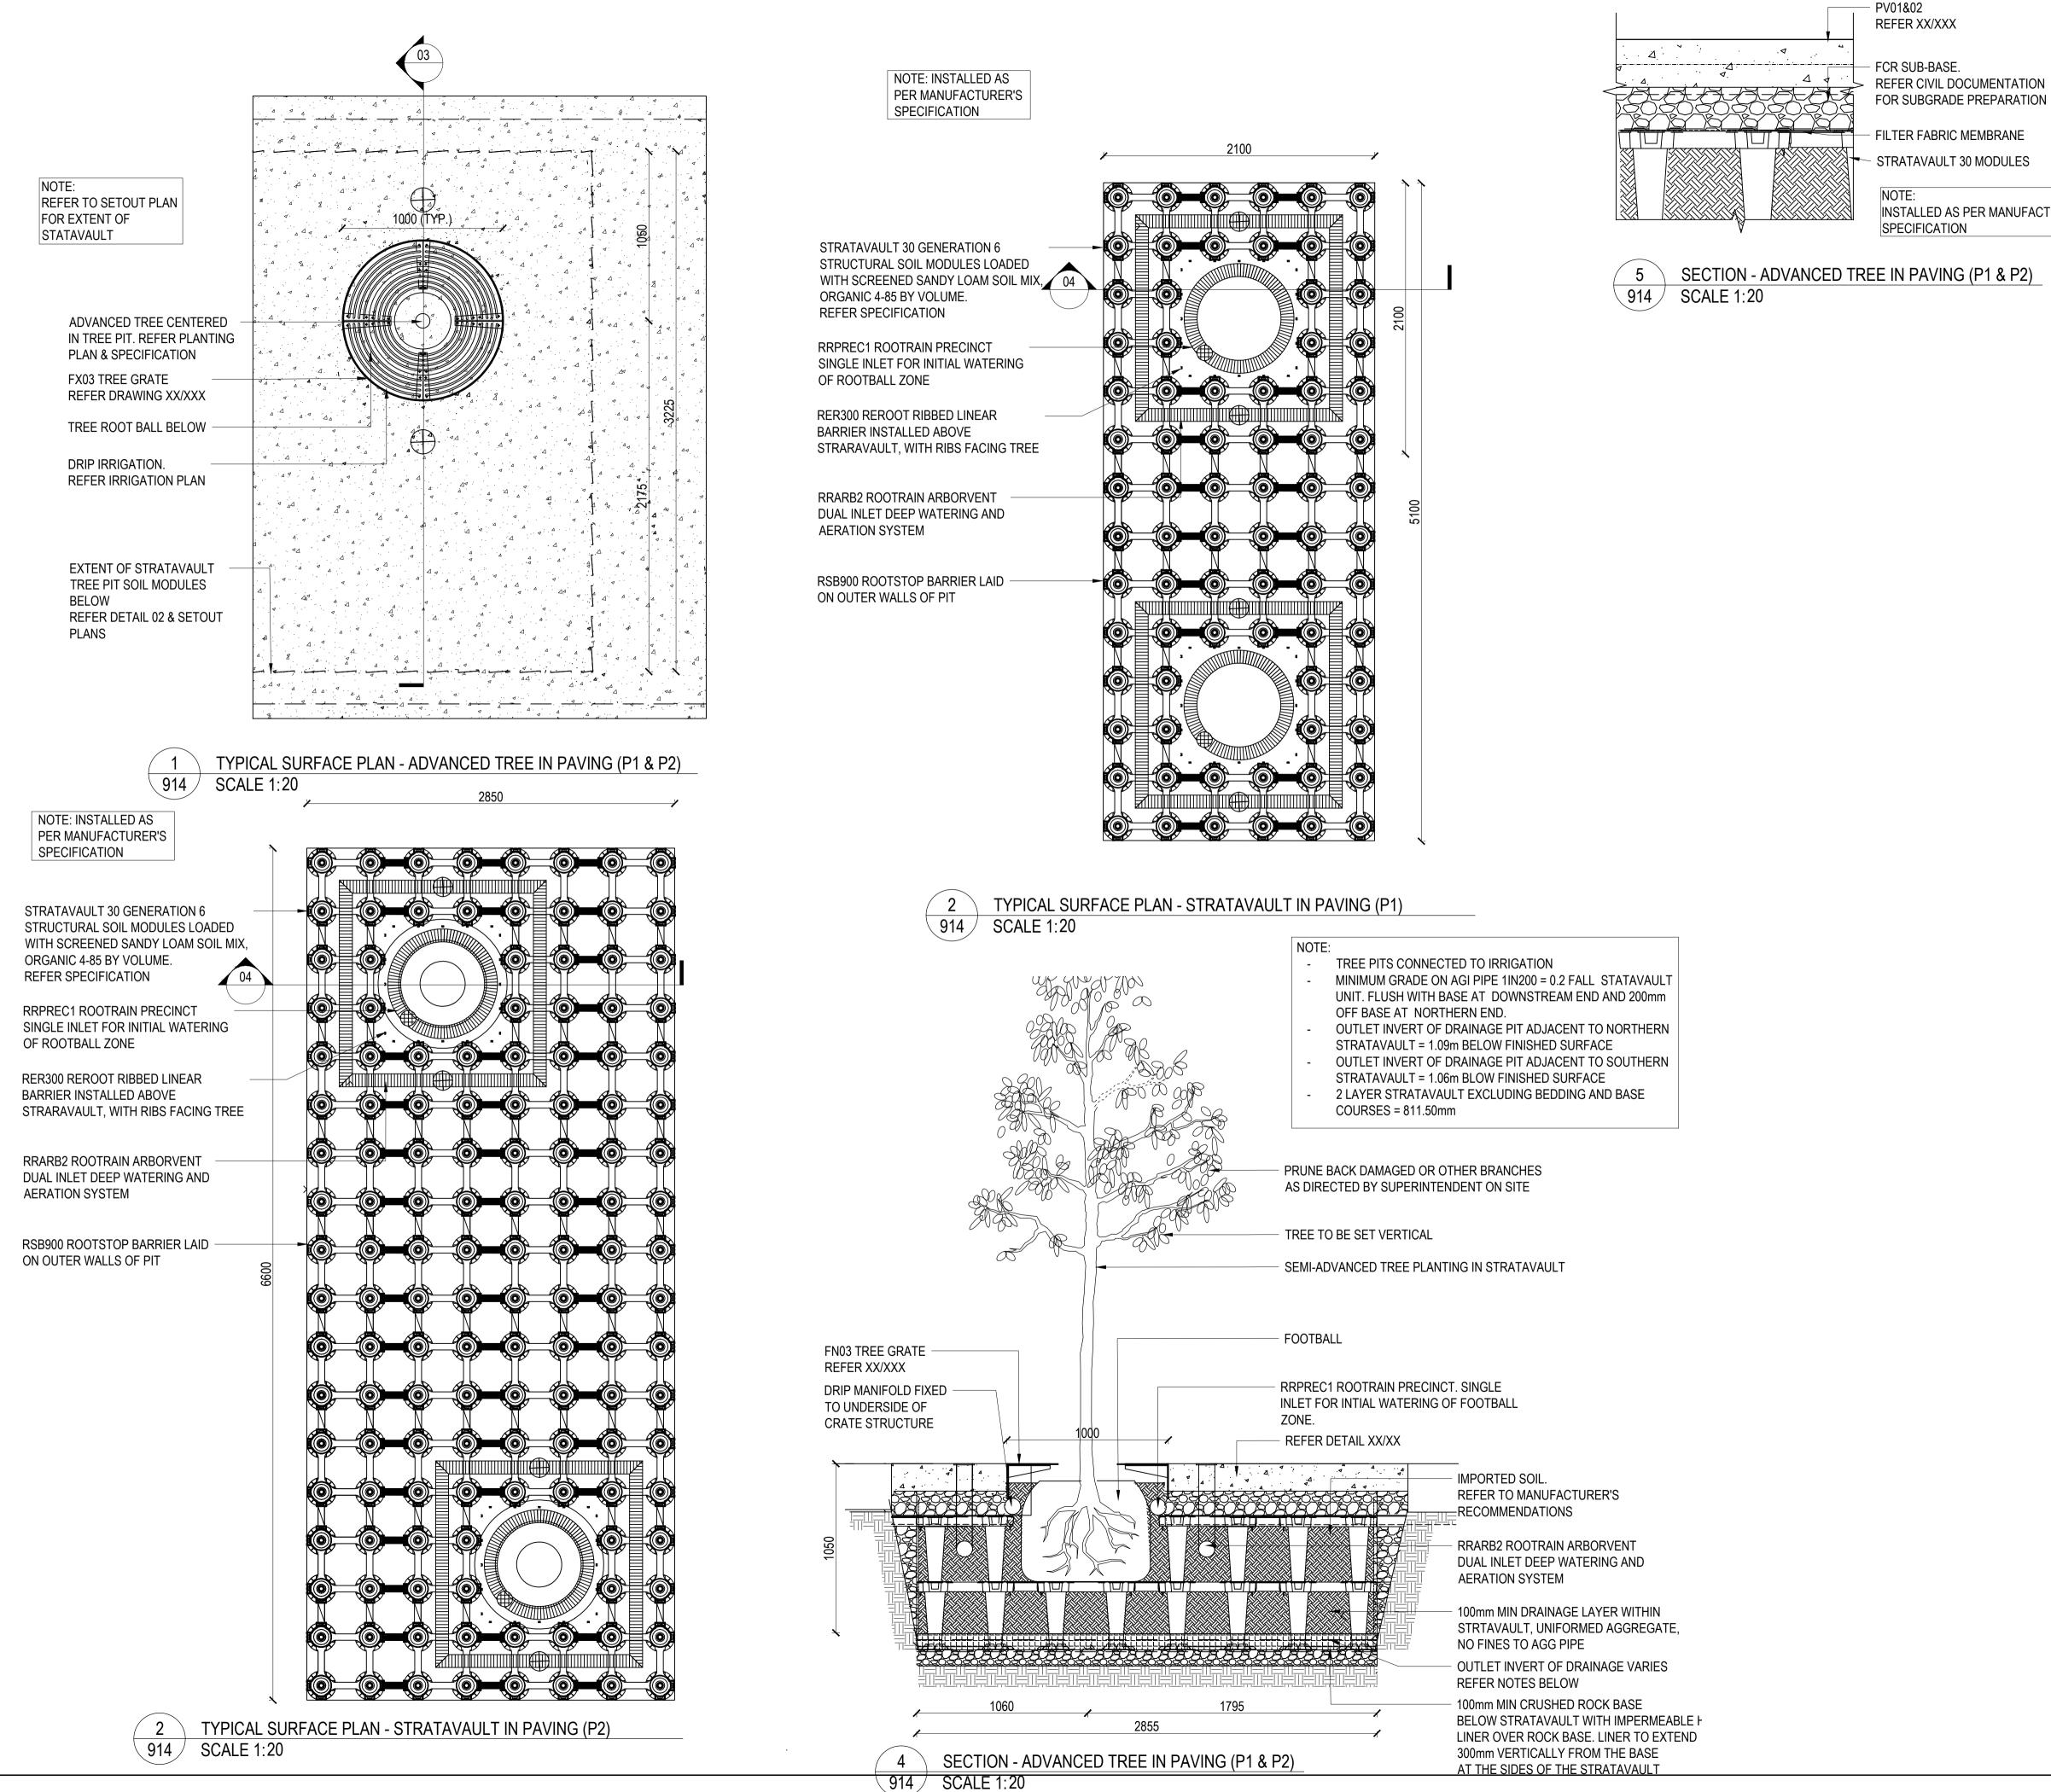
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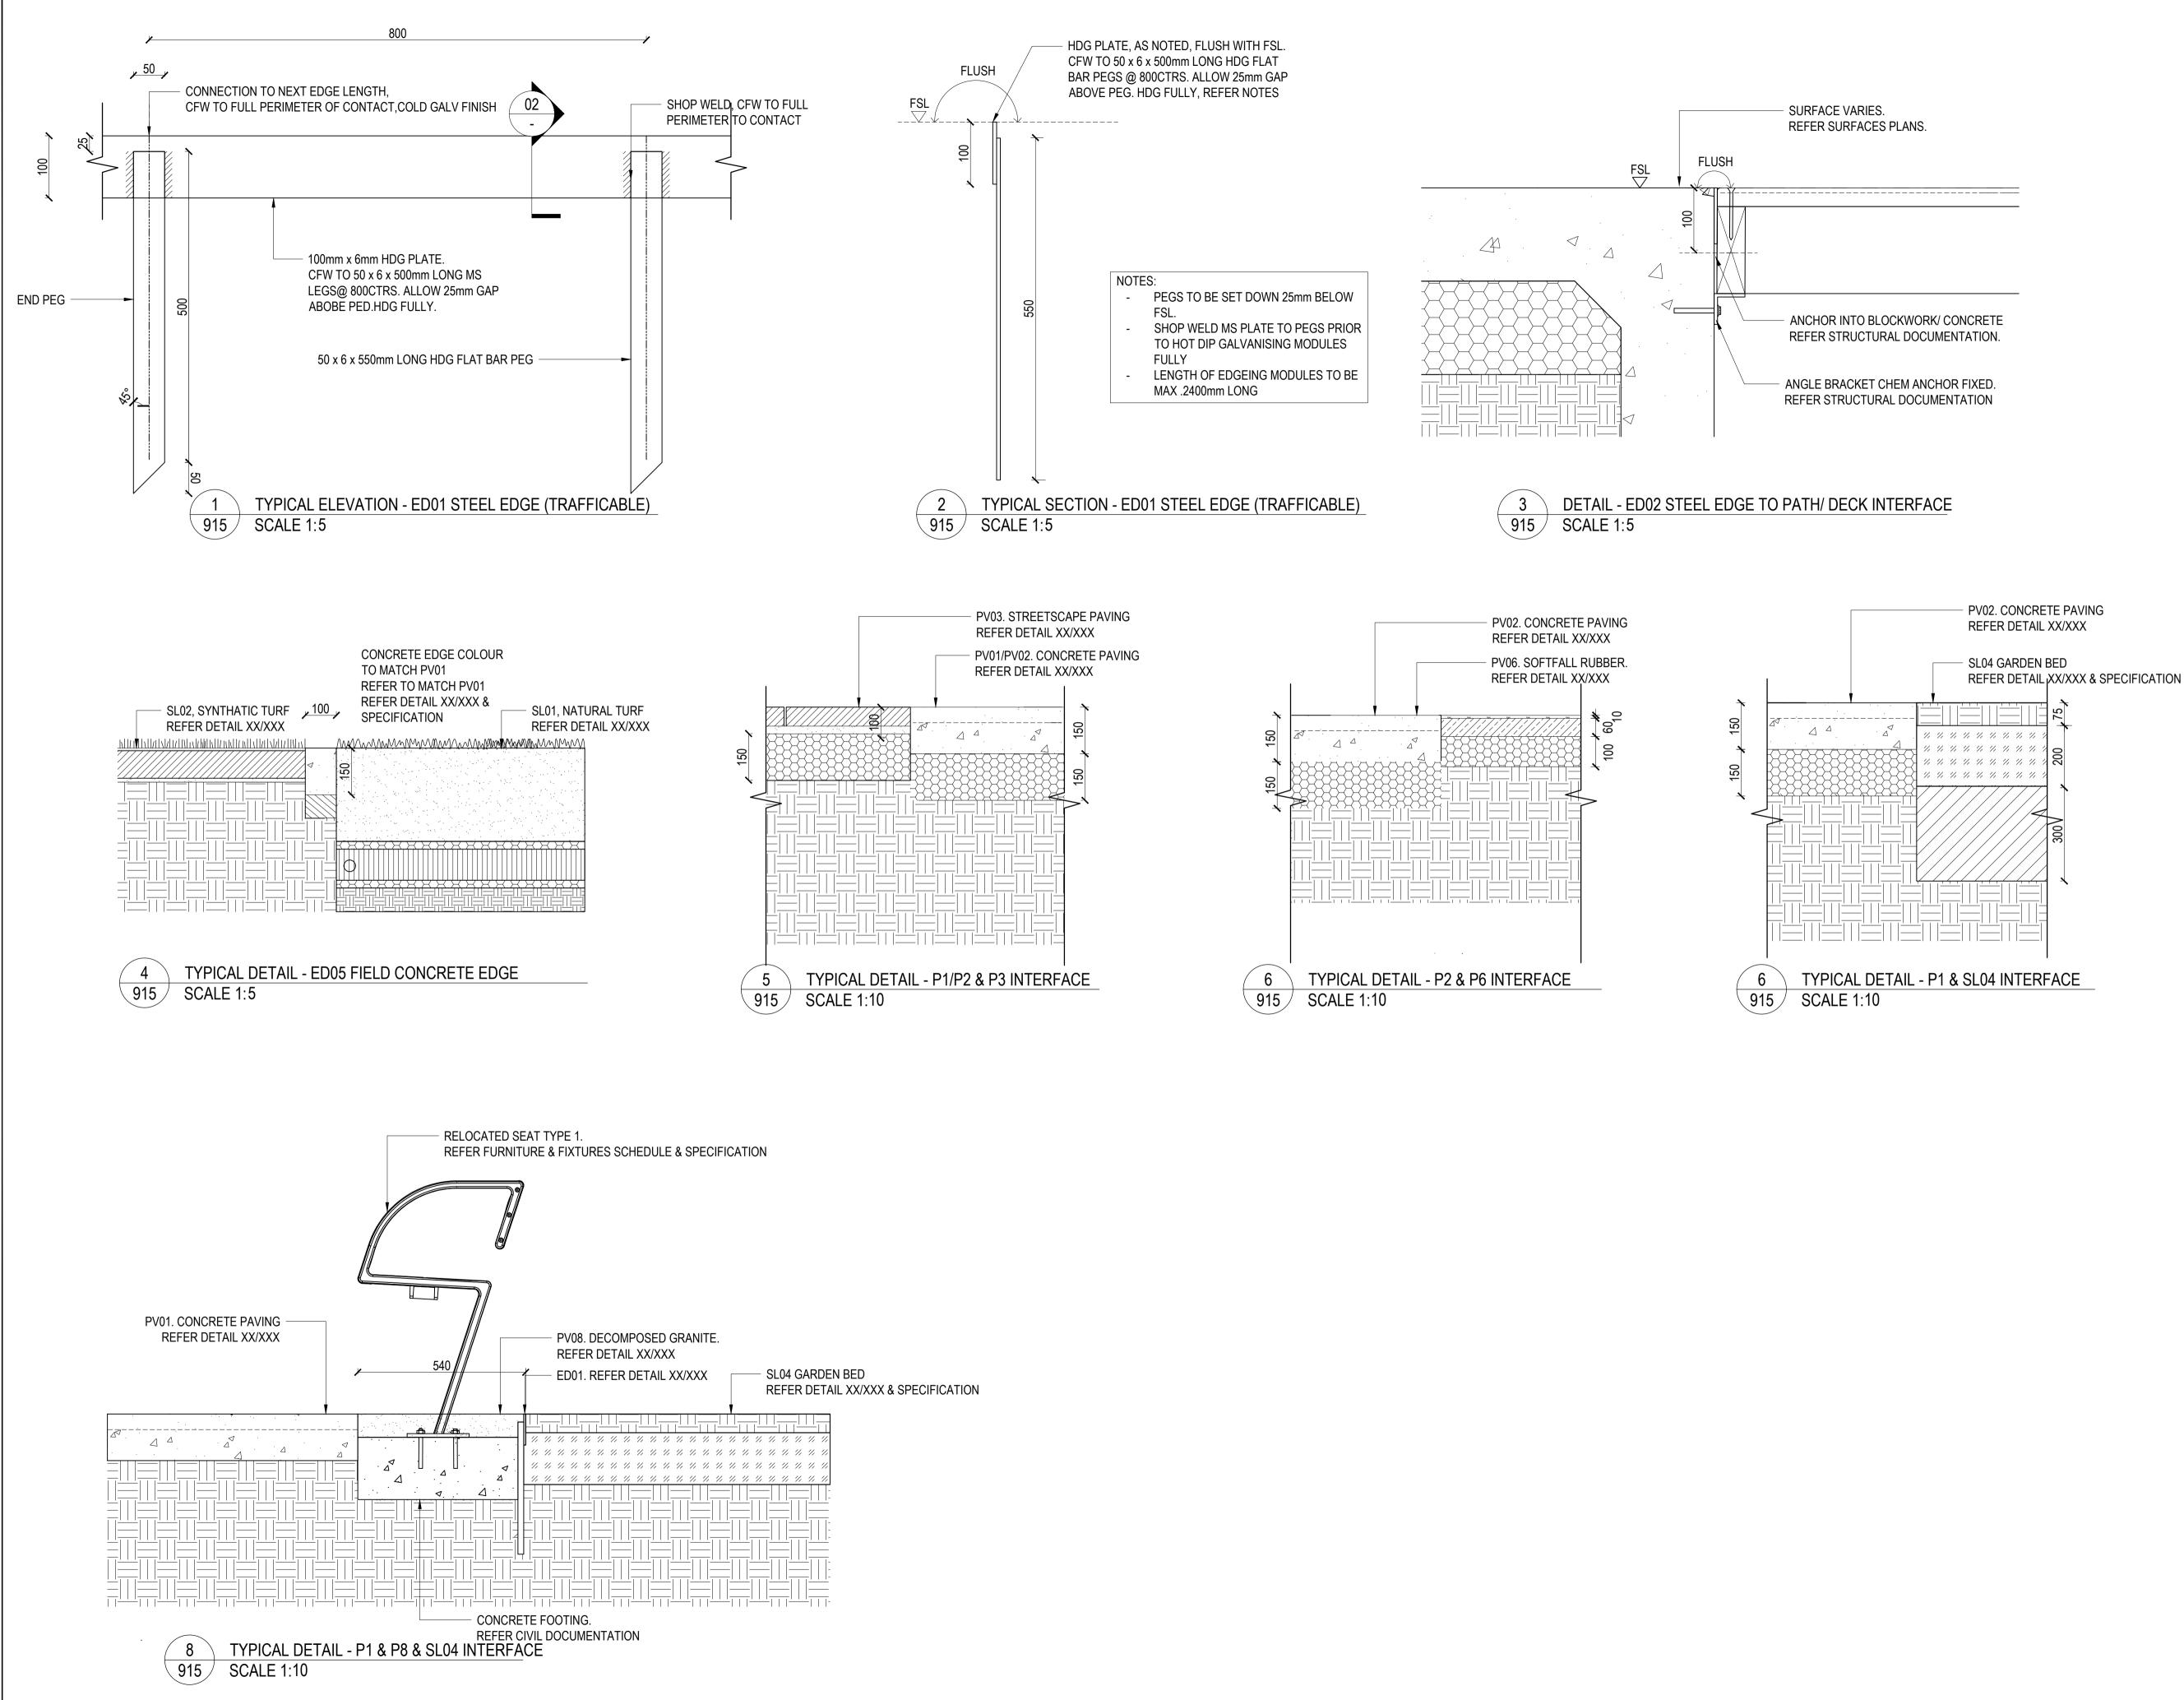
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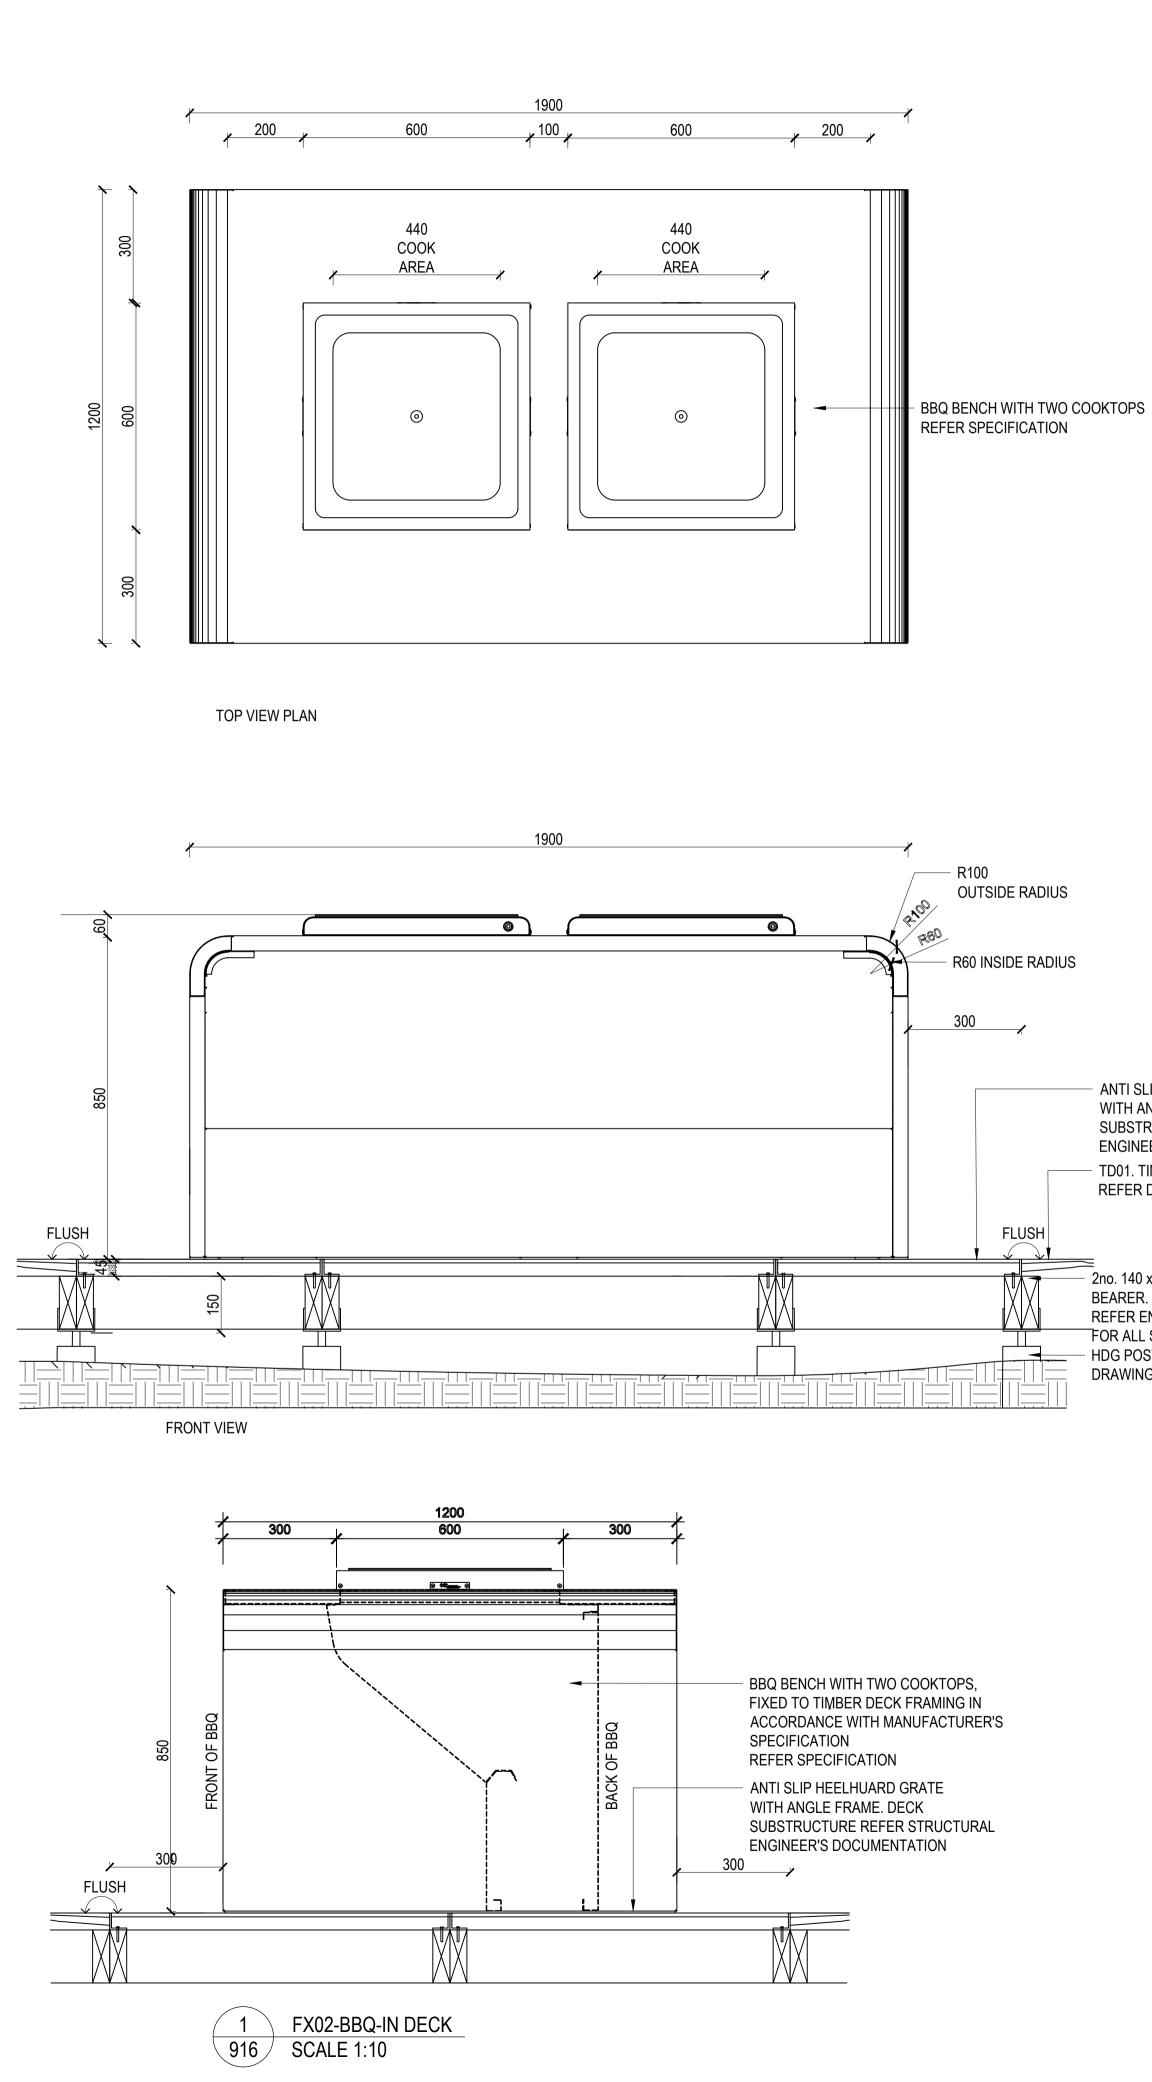
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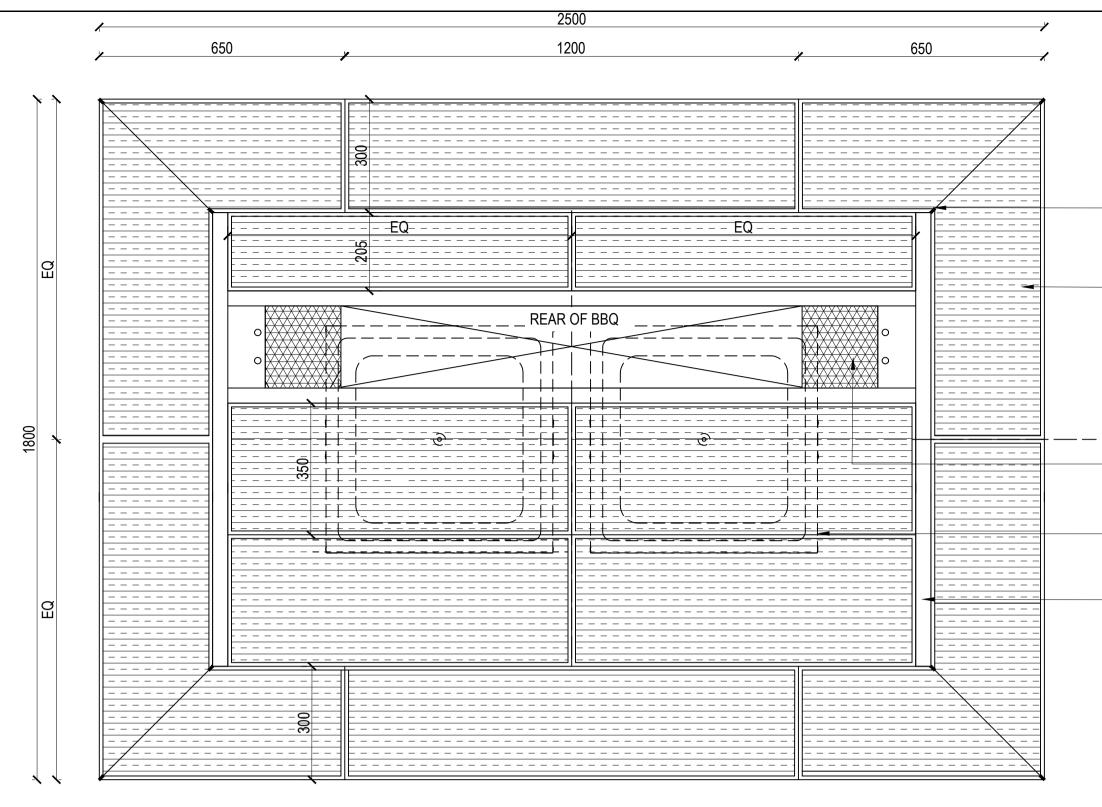
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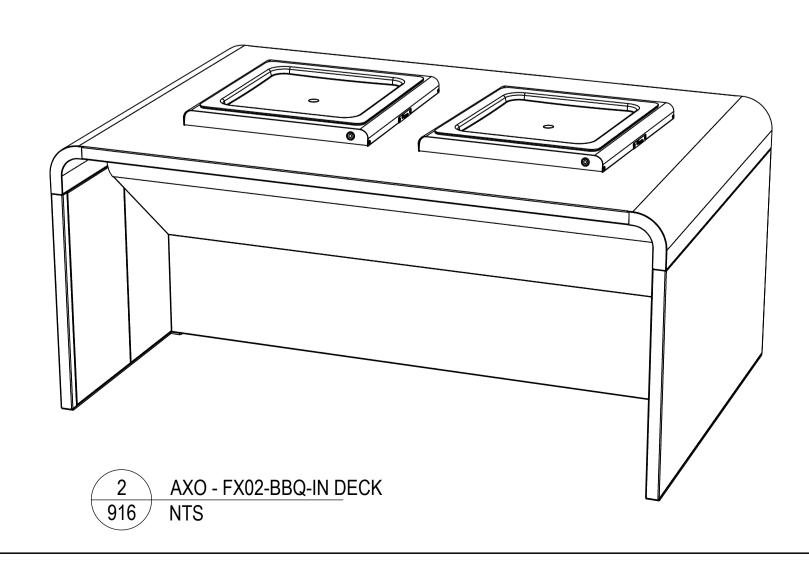


GRATING PLAN

1900 \square \square \square \square BBQ BENCH WITH TWO COOKTOPS, 6 0 FIXED TO TIMBER DECK FRAMING IN ACCORDANCE WITH MANUFACTURER'S SPECIFICATION REFER SPECIFICATION ANTI SLIP S/S HEELHUARD GRATE WITH ANGLE FRAME. DECK SUBSTRUCTURE REFER STRUCTURAL 500 ENGINEER'S DOCUMENTATION 300 FLUSH FLUSH **GRATING PLAN**

ANTI SLIP HEELHUARD GRATE WITH ANGLE FRAME. DECK SUBSTRUCTURE REFER STRUCTURAL ENGINEER'S DOCUMENTATION TD01. TIMBER DECK REFER DETAIL

- 2no. 140 x 45mm F7 TIMBER REFER ENGINEER DRAWINGS FOR ALL SUB-STRUCTURE. - HDG POST. REFER ENGINEERS DRAWINGS FOR POST DETAILS



NOTE: BBQ BENCH WITH TWO COOKTOPS, FIXED TO CONCRETE. REFER MANUFACTURE'S DETAILS AND SPECIFICATION


WELDED PANELS TOGETHER AT ALL CORNERS

ANTI SLIP S/S HEELGUARD GRATE WITH ANGLE FRAME. 45° MITRE TO ALL CORNERS. SETOUT GRATE PANELS FROM CENTRE LINE OF BBQ AS SHOWN. CONTRACTOR IS TO PROVIDE SETOUT PLAN WITH DIMENSIONS FOR APPROVAL BY LANDSCAPE ARCHITECT PRIOR TO INSTALLATION

ELECTRICAL SERVICES AREA REFER SPECIFICATION

ELECTRICAL SERVICES AREA REFER SPECIFICATION

BBQ BENCH BASE STRUCTURE REFER SPECIFICATION

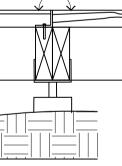

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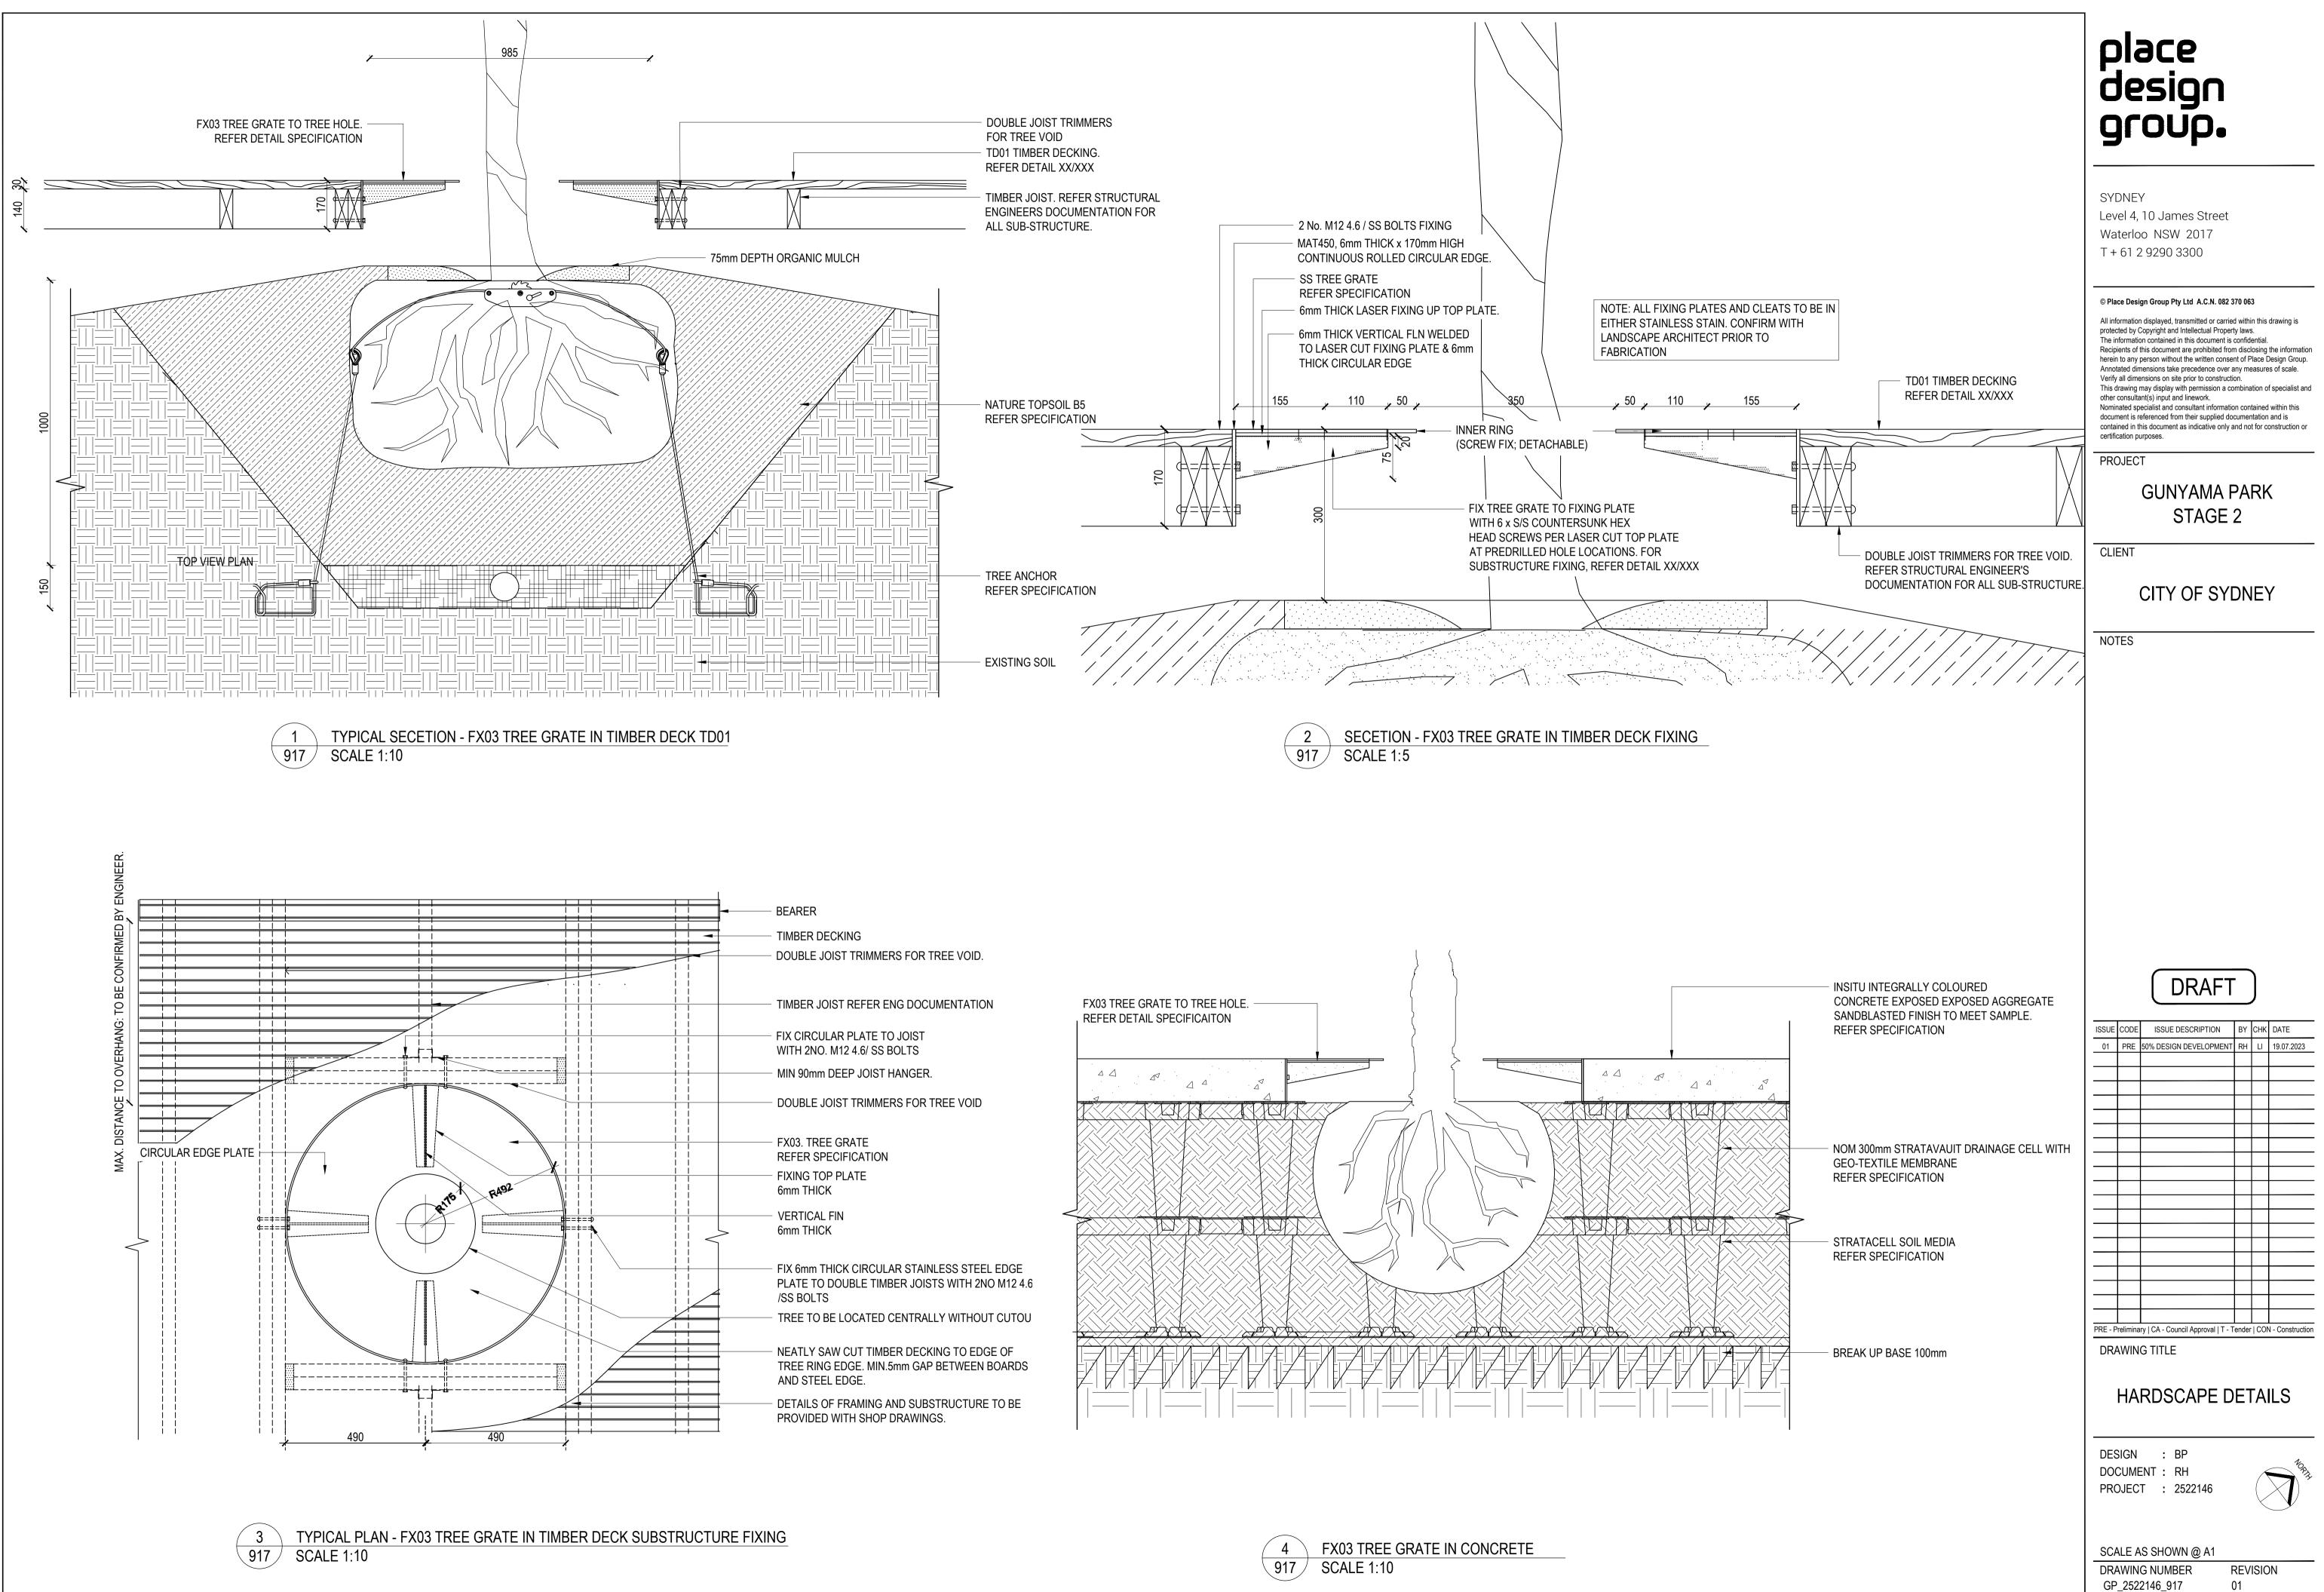
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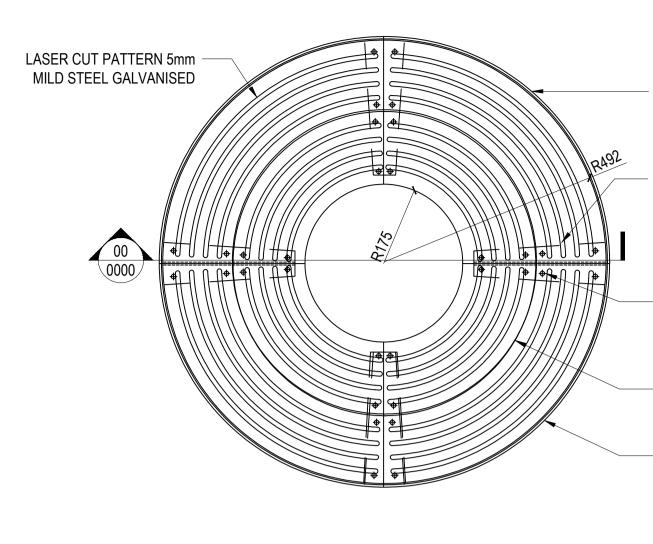
DESIGN : BP DOCUMENT : RH PROJECT : 2522146



SCALE AS SHOWN @ A1 DRAWING NUMBER GP_2522146_916

REVISION 01





FX03 TREE GRATE 1 918 / SCALE 1:5

6mm THICK x 180mm HIGH GALVANIZED STEEL CONTINUOUS ROLLED CIRCULAR EDGE.

6mm THICK CORTEN STEEL LASER CUT FIXING PLATE (UNDER) 6mm THICK VERTICAL FIN WELDED TO LASER FIXING TOP PLATE & 6mm THICK CIRCULAR EDGE.

- FIX TREE GRATE TO FIXING PLATE WITH 6 x S/S COUNTERSUNK HEX HEAD SCREWS PER LASER CUT TOP PLATE AT PREDRILLER HOLE LOCATIONS

- REMOVABLE INNER RING TO BE DETAILED BY MANUFACTURER FOR LANDSCAPE ARCHITECT'S APPROVAL

- MILD STEEL ANGLE FRAME FIXING OPTIONS: 1. BOLT DOWN FIXING 2.

- CONCRETE FIXING TIMBER DECK FIXING 3.

B492

NOTE: FIXING TO BE DETAILED BY MANUFACTURER FOR LANDSCAPE ARCHITECT'S APPROVAL

INNER RING QUARTER



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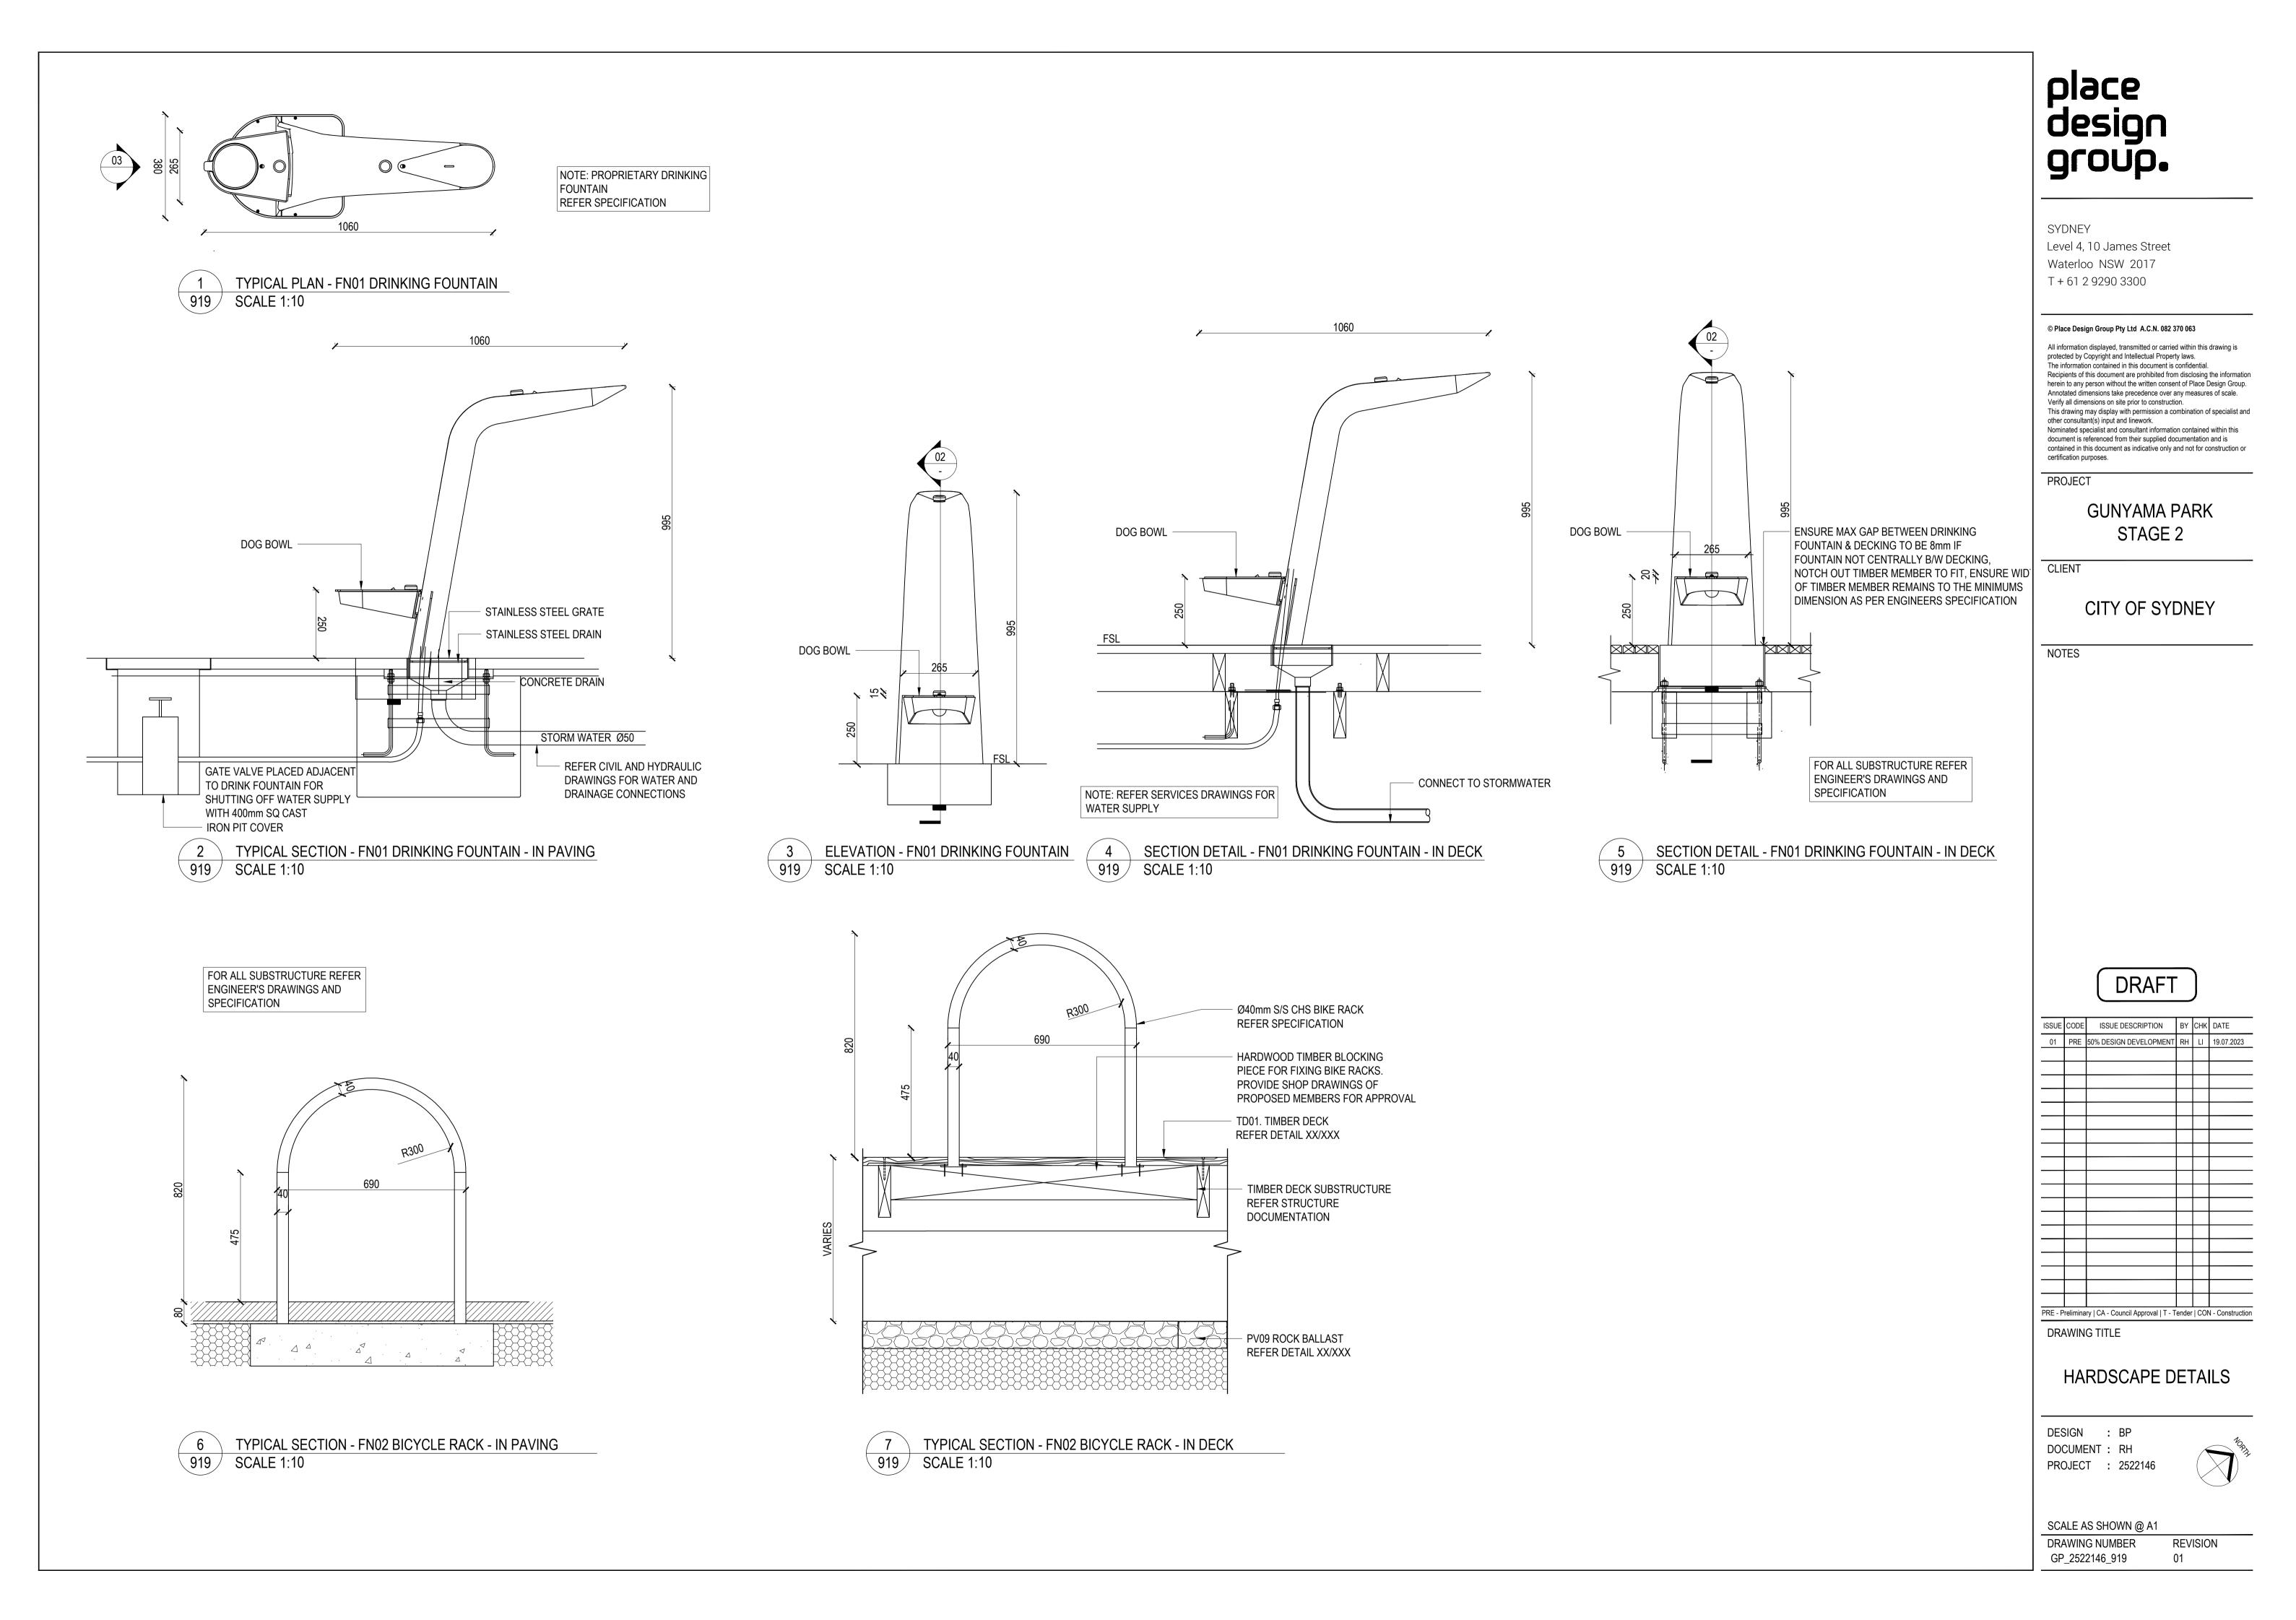
HARDSCAPE DETAILS


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PROJECT

GUNYAMA PARK STAGE 2

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NOTES

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ISSUE	CODE	ISSUE DESCRIPTION	BY	СНК	DATE
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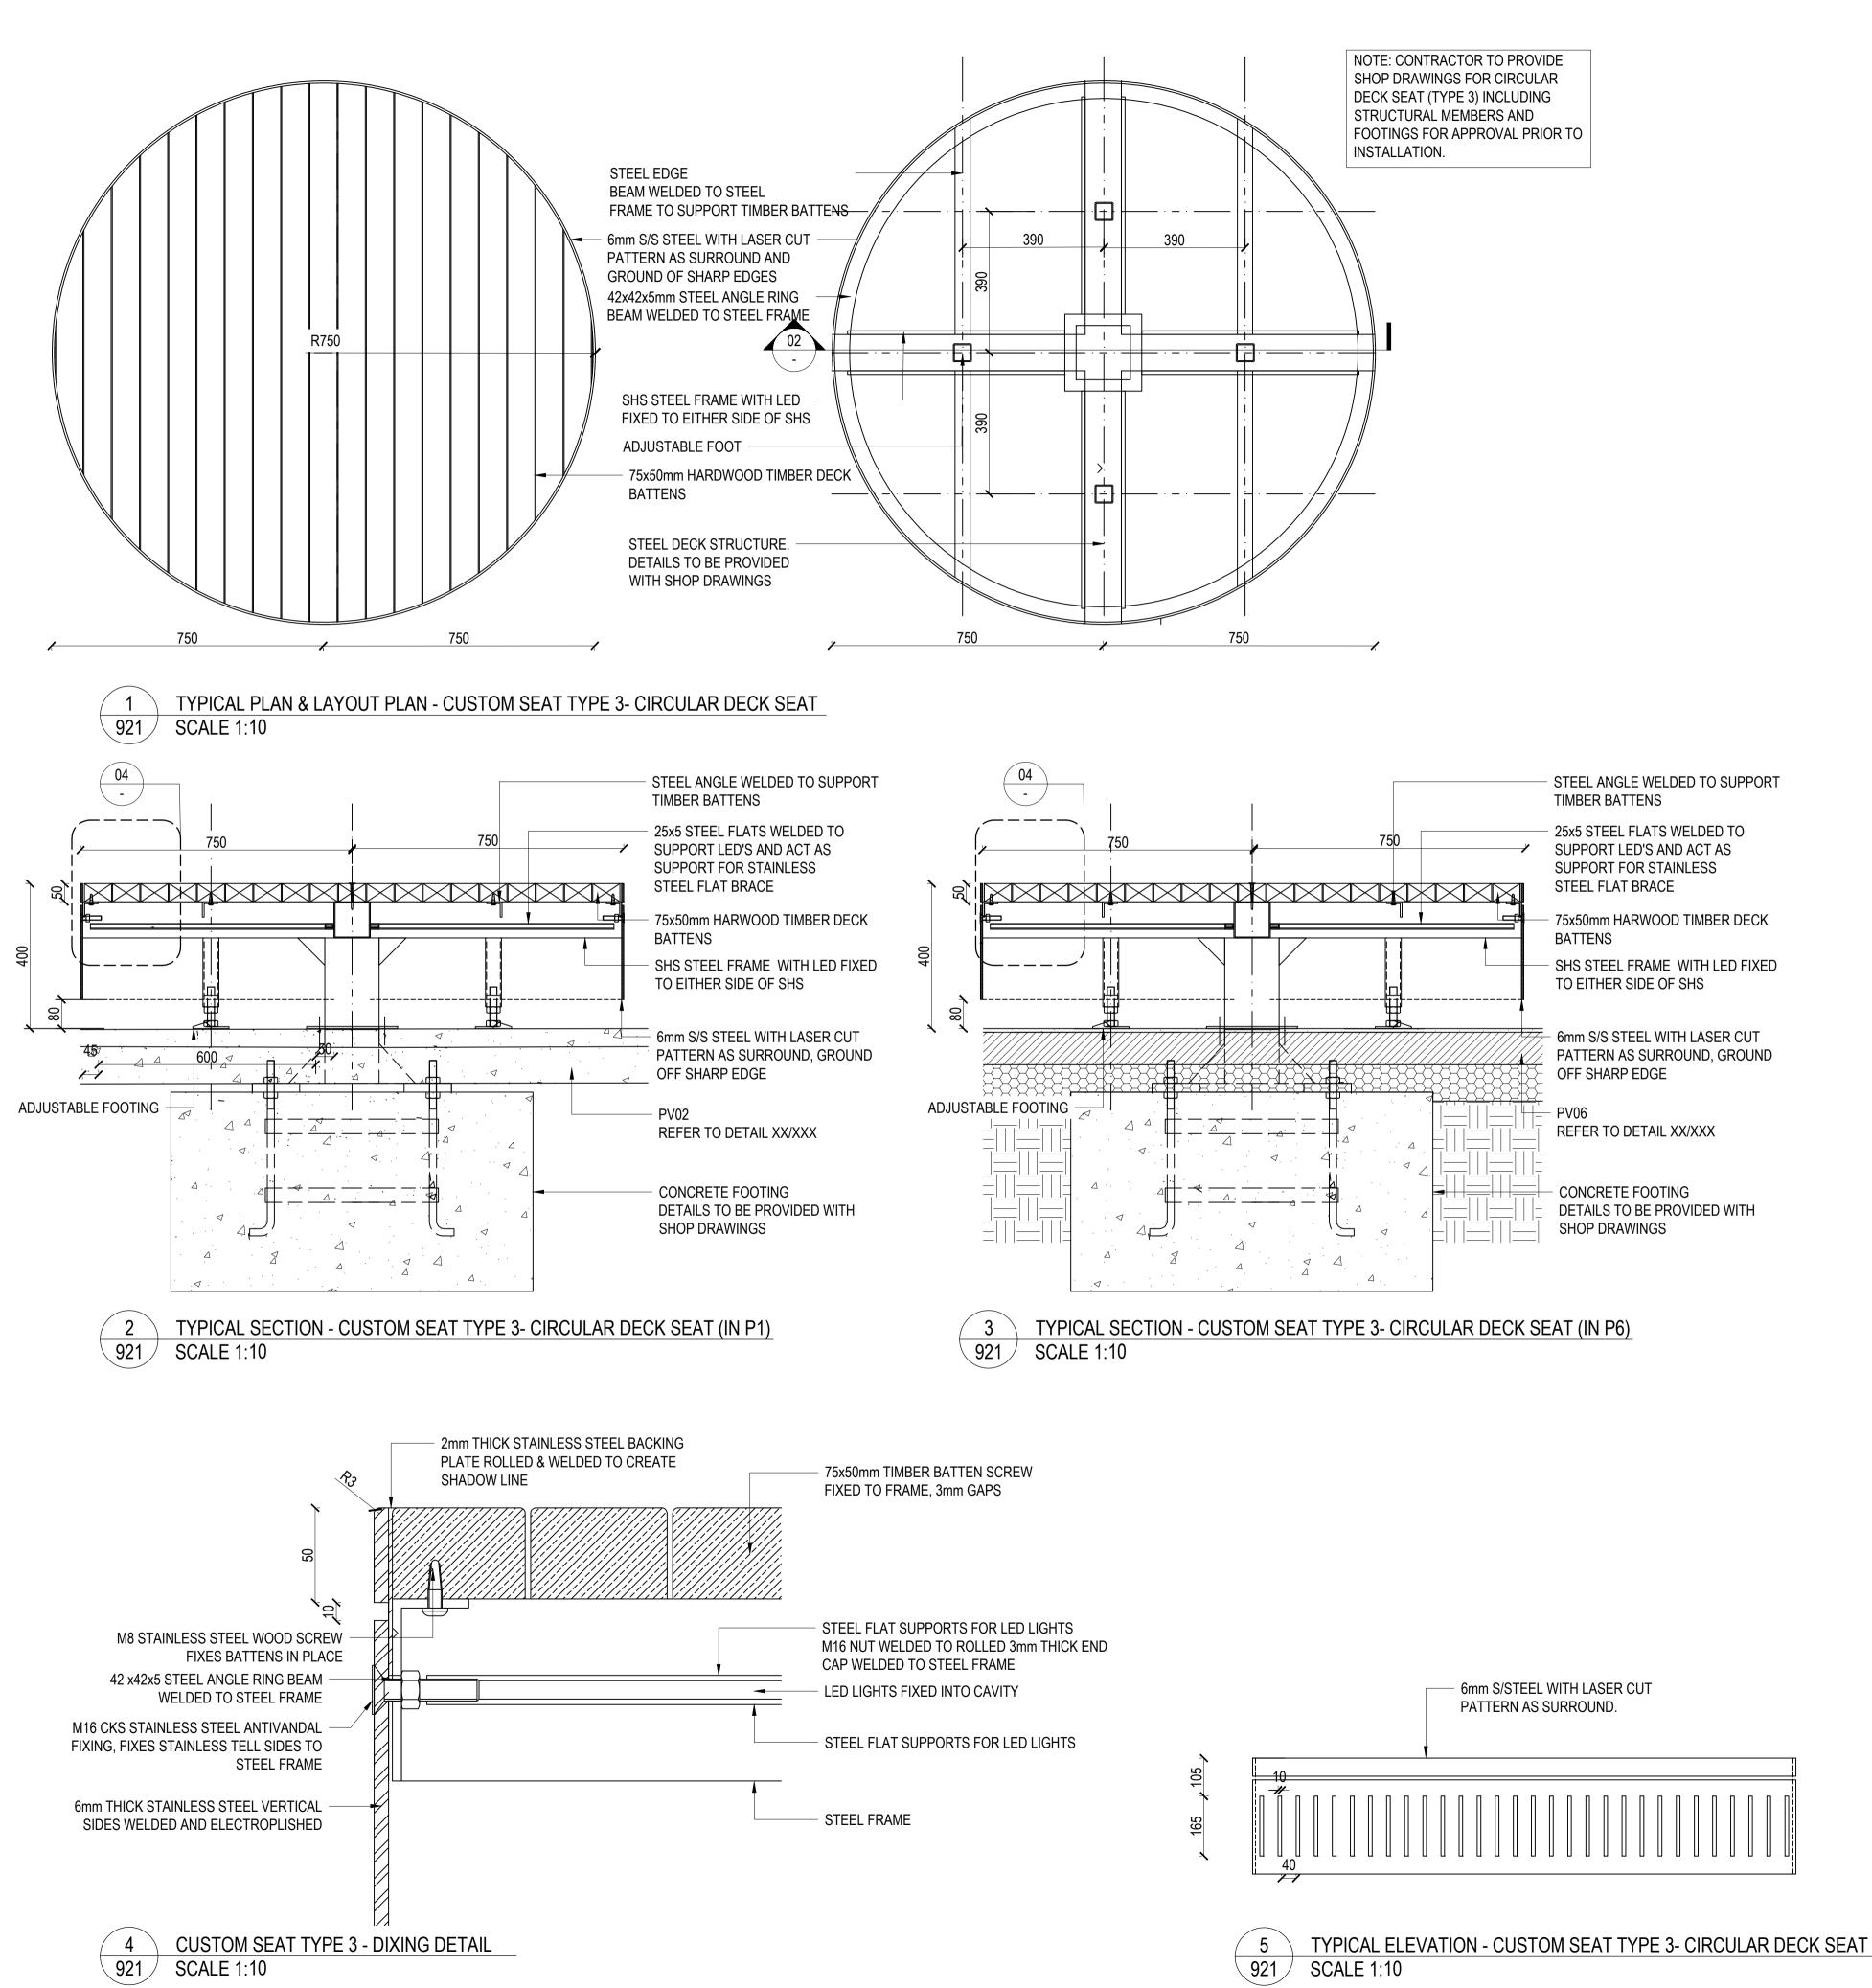
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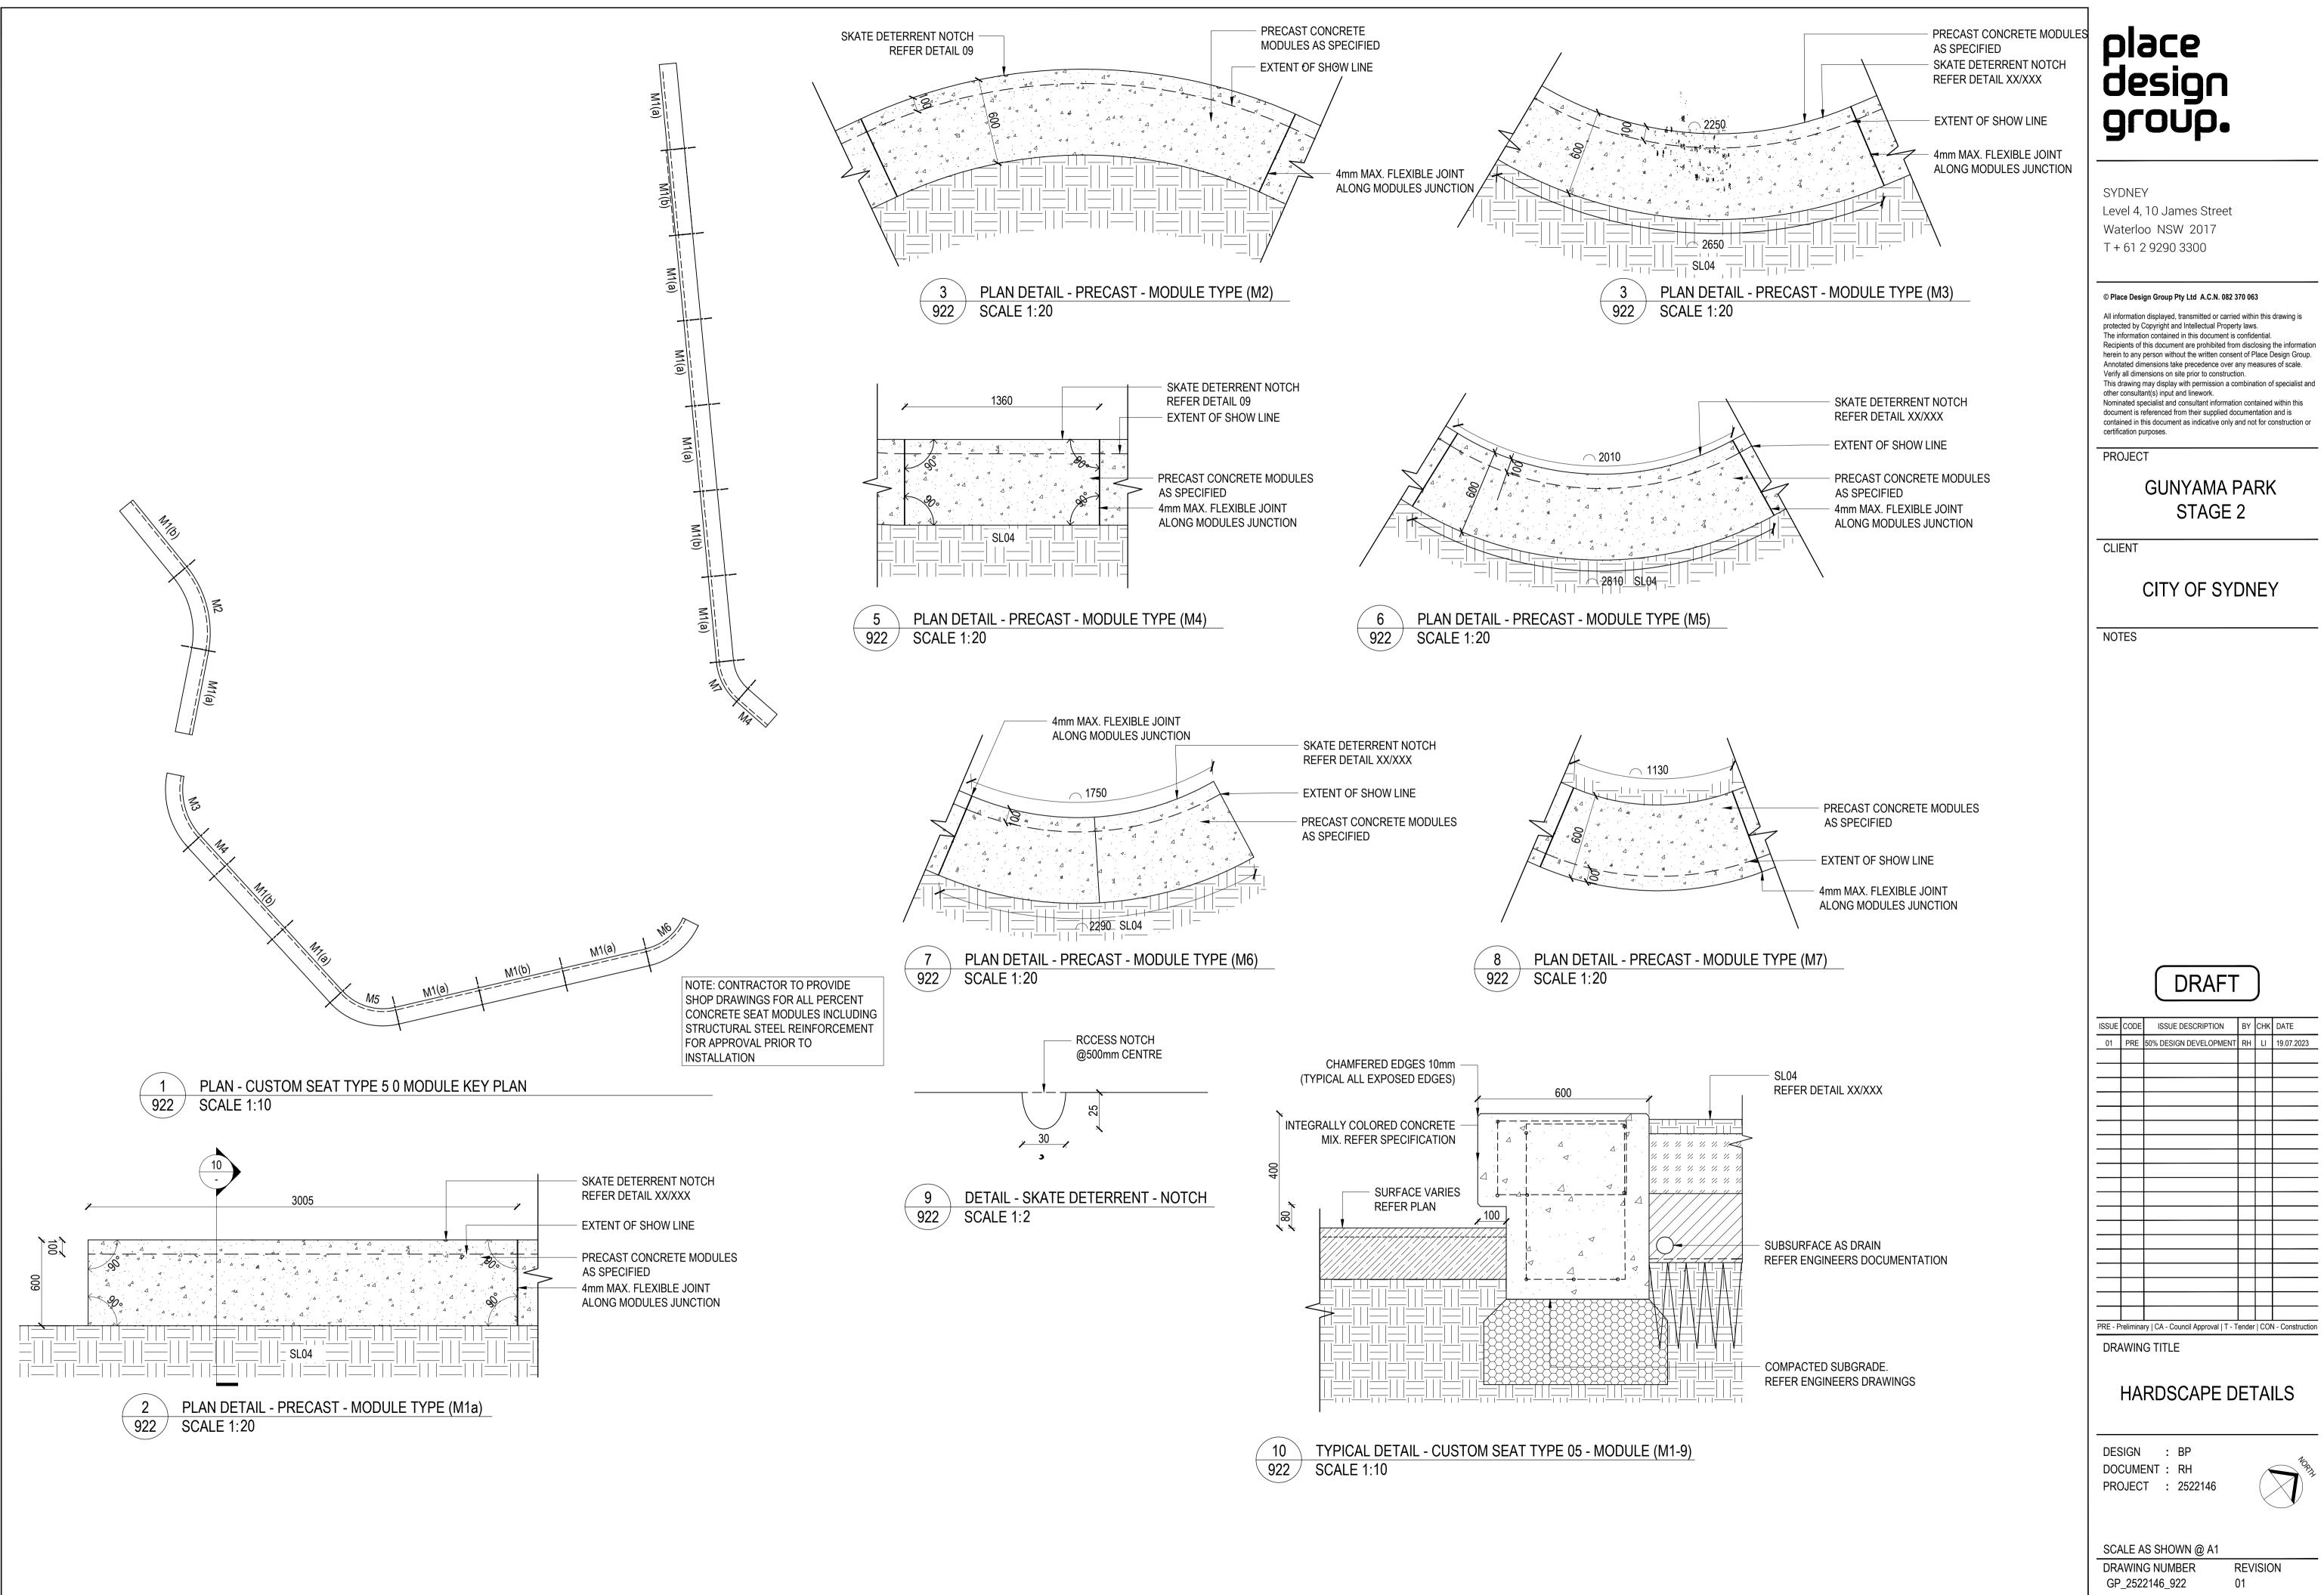
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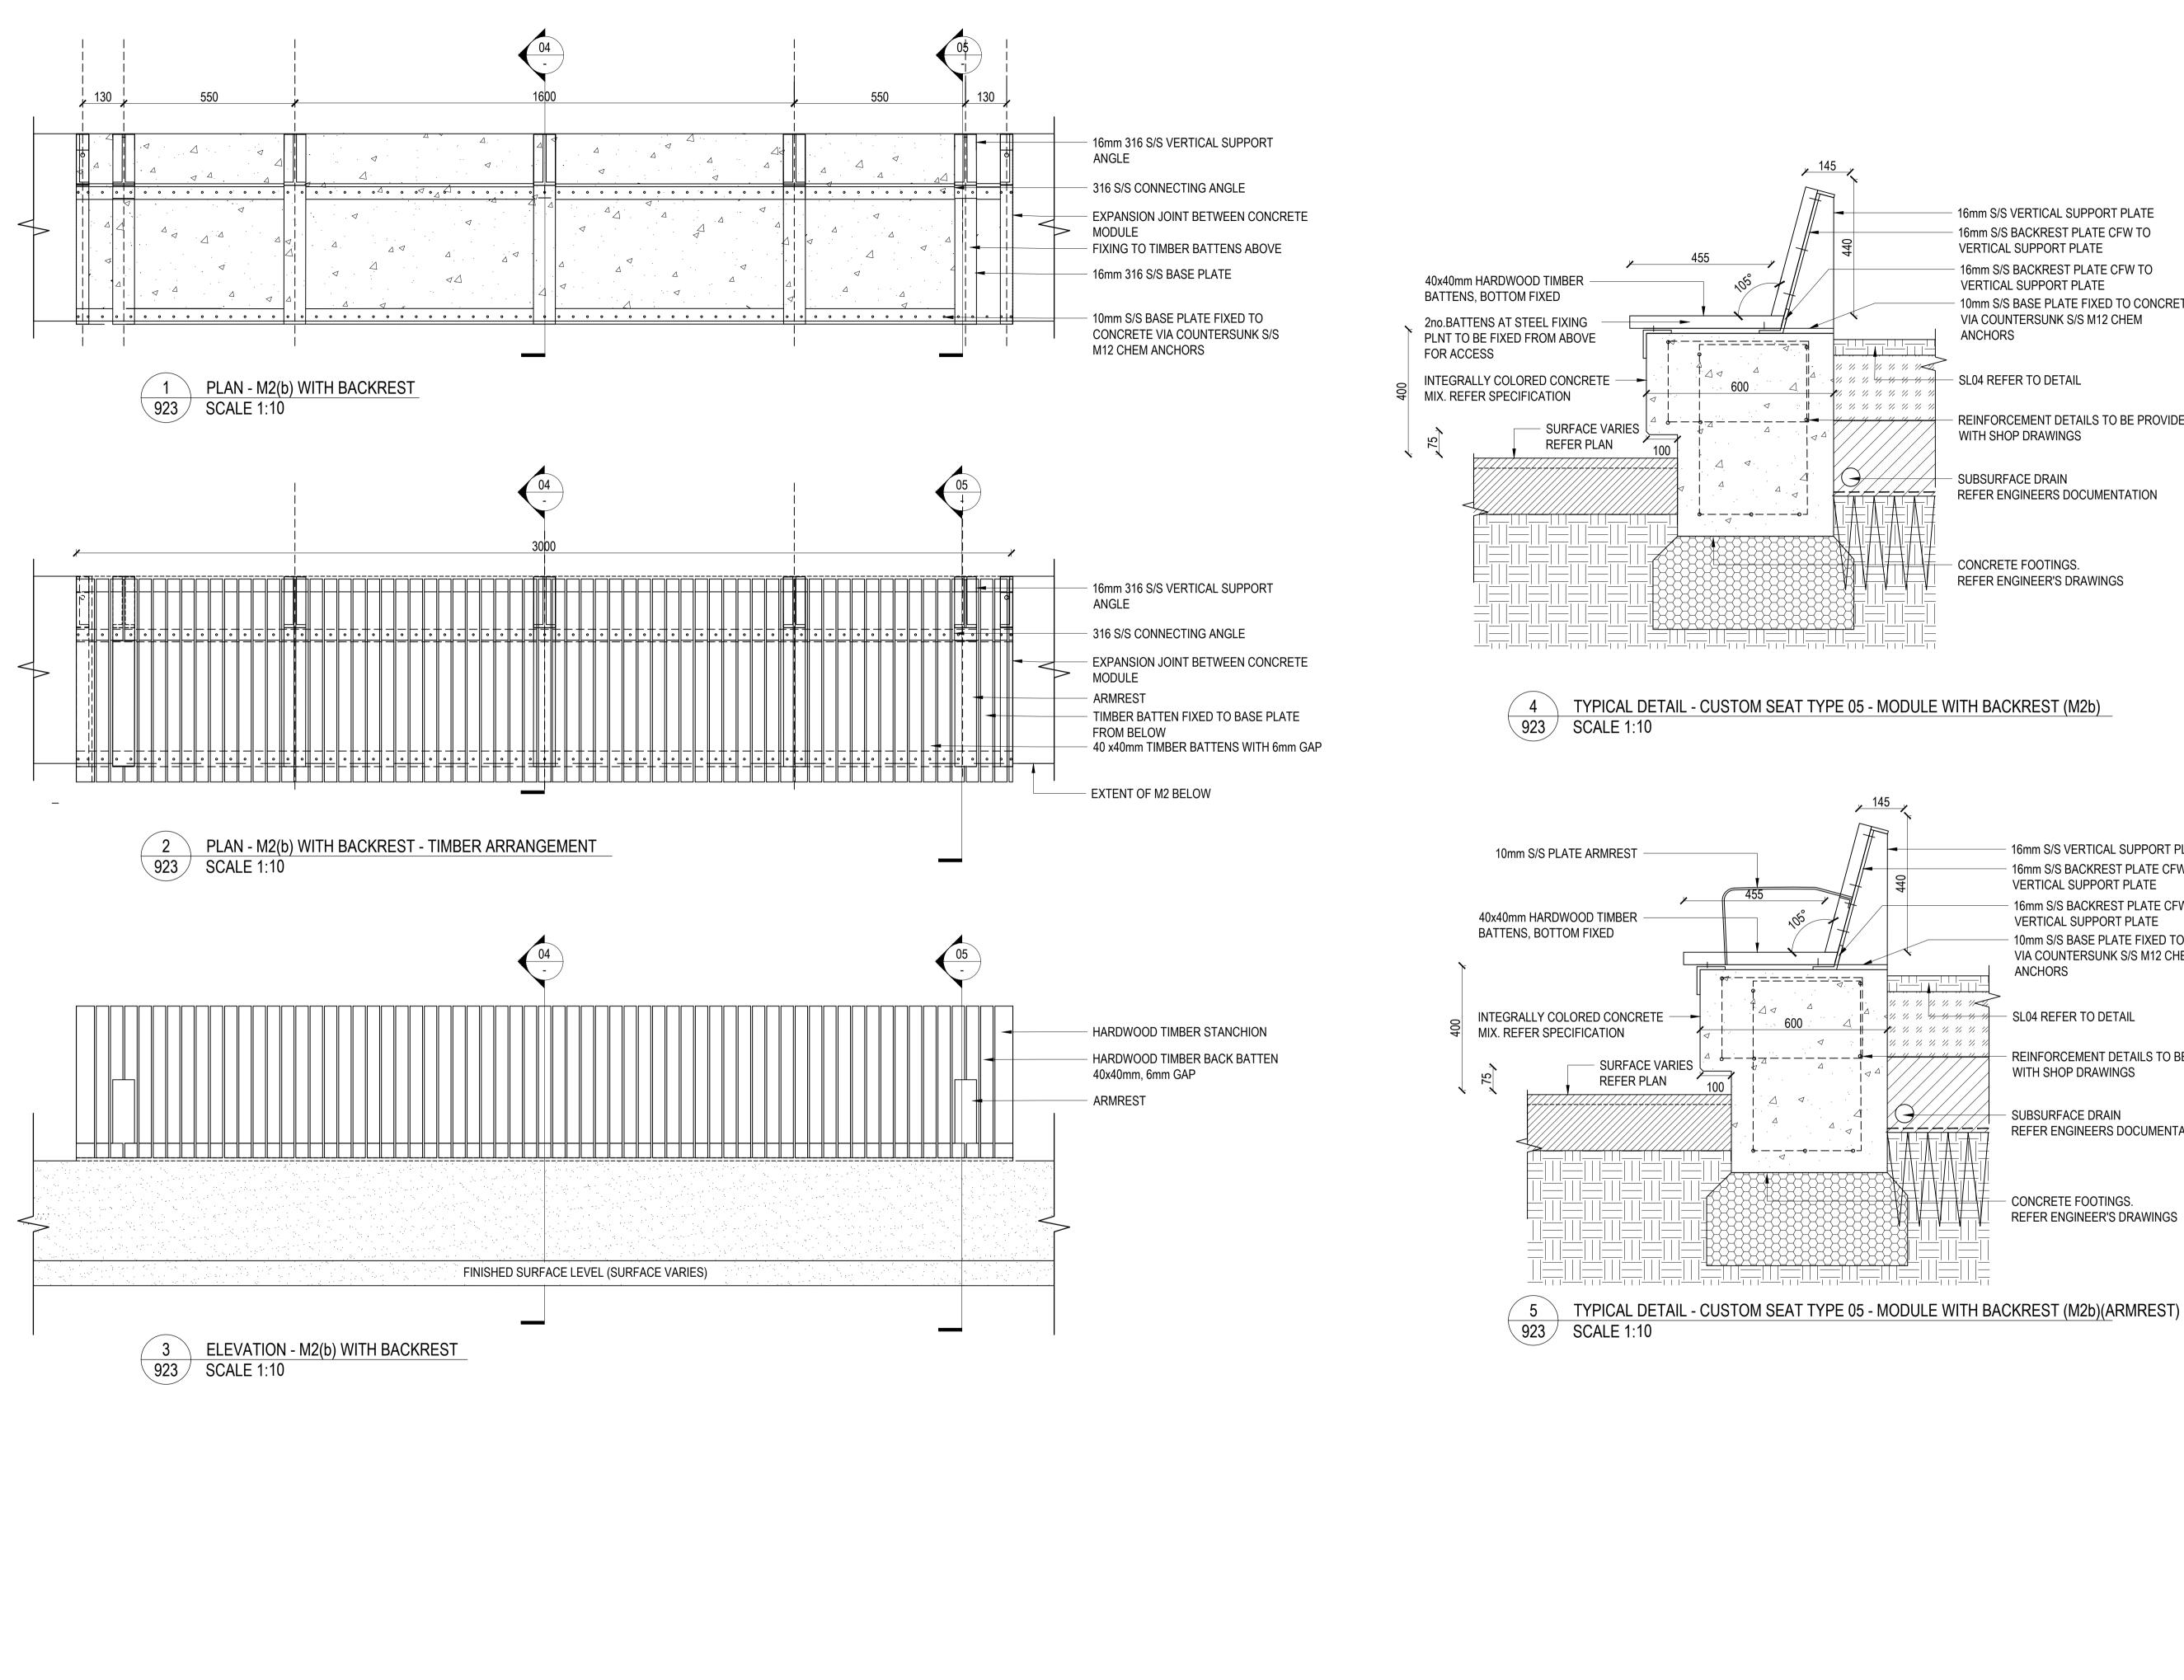
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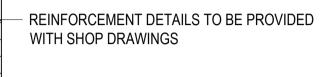




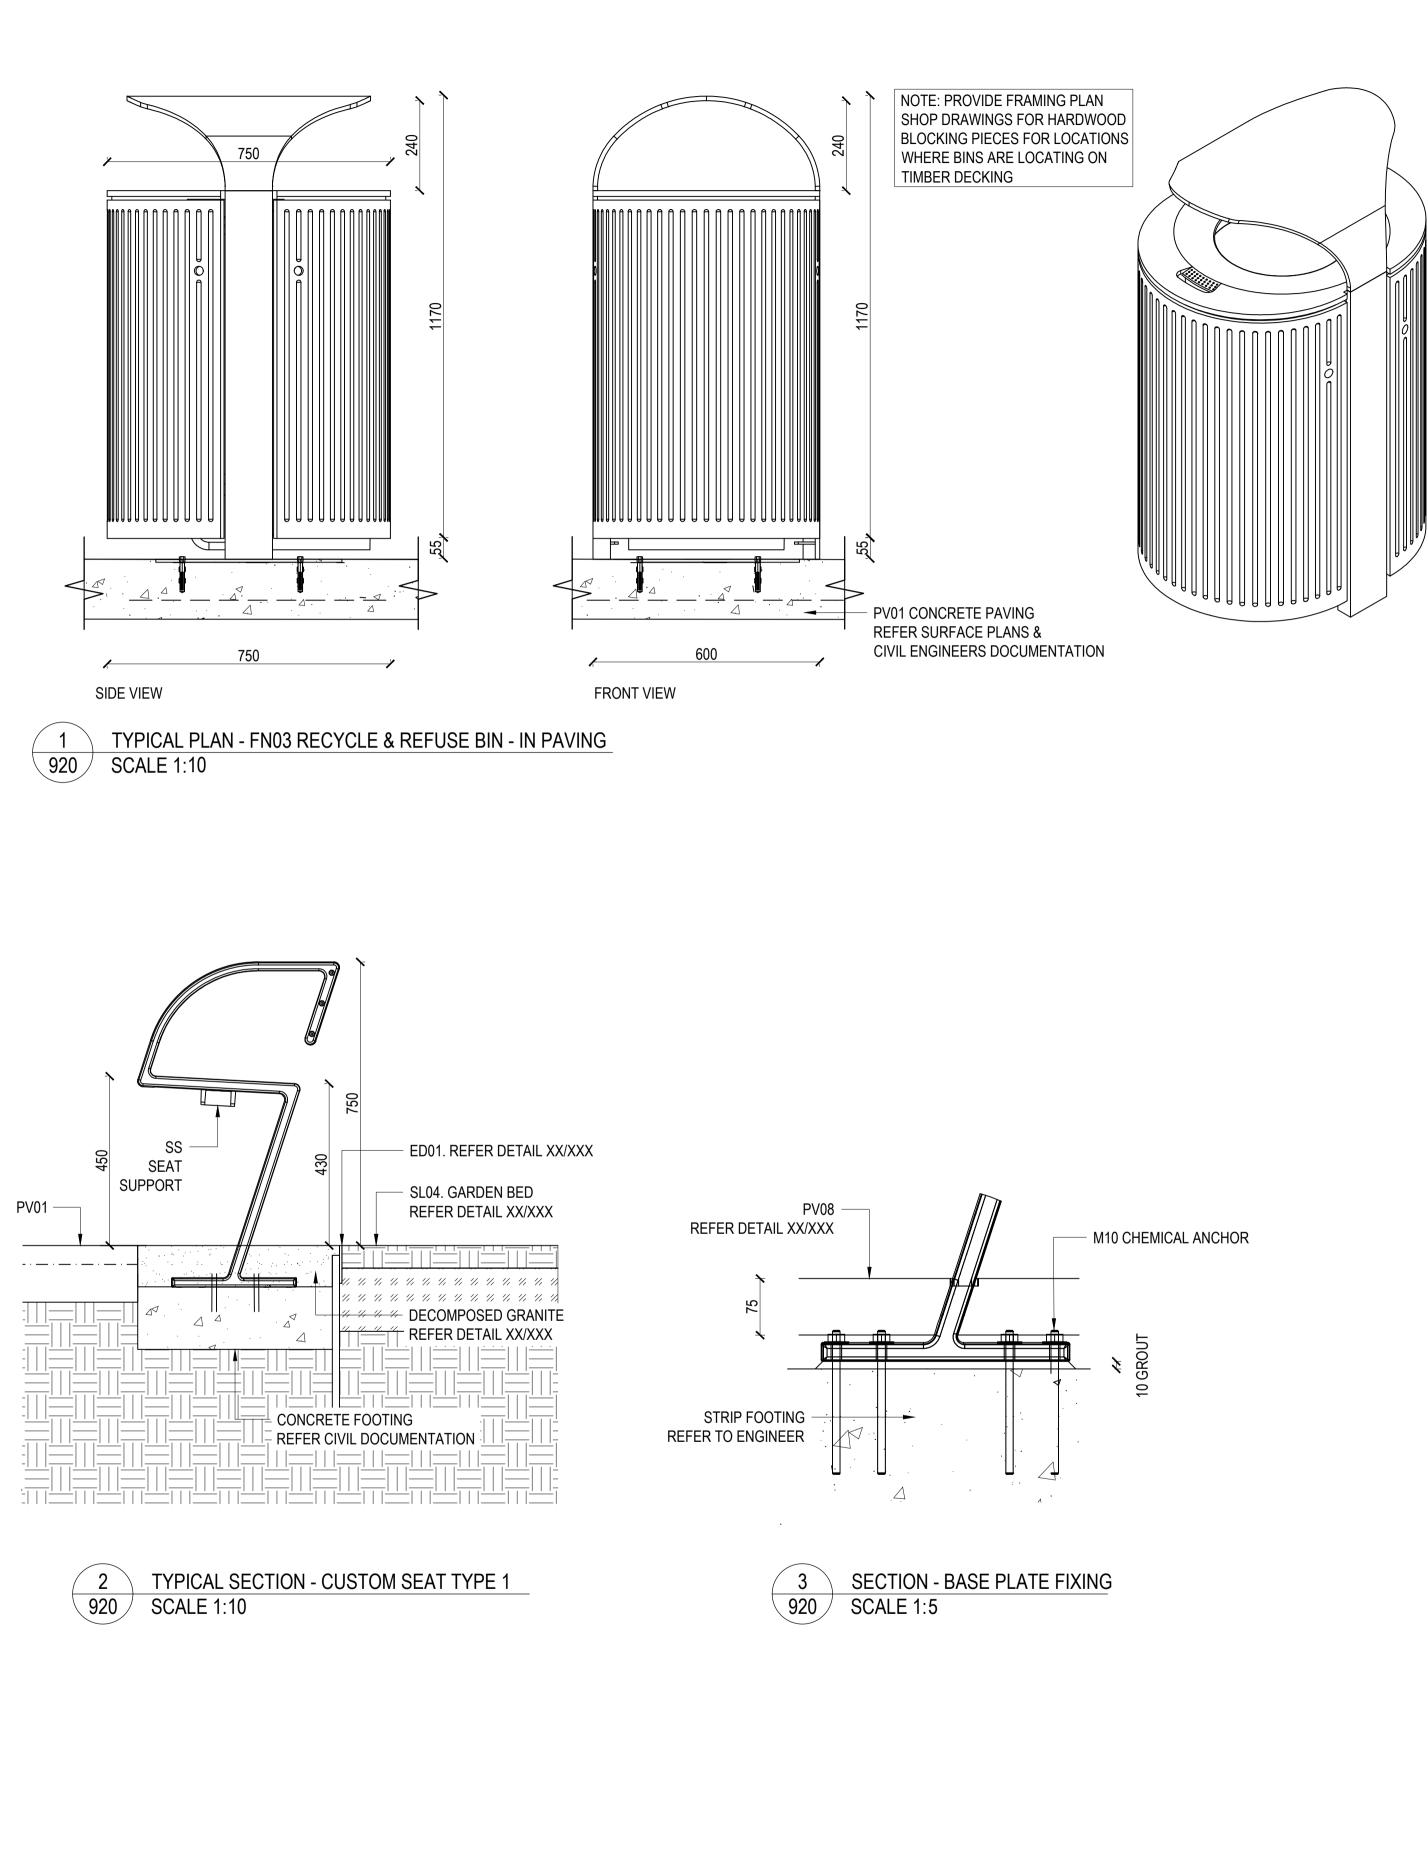

16mm S/S VERTICAL SUPPORT PLATE 16mm S/S BACKREST PLATE CFW TO VERTICAL SUPPORT PLATE 16mm S/S BACKREST PLATE CFW TO VERTICAL SUPPORT PLATE - 10mm S/S BASE PLATE FIXED TO CONCRETE VIA COUNTERSUNK S/S M12 CHEM ANCHORS

SL04 REFER TO DETAIL



SUBSURFACE DRAIN REFER ENGINEERS DOCUMENTATION

- CONCRETE FOOTINGS. REFER ENGINEER'S DRAWINGS

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16mm S/S VERTICAL SUPPORT PLATE 16mm S/S BACKREST PLATE CFW TO VERTICAL SUPPORT PLATE 16mm S/S BACKREST PLATE CFW TO VERTICAL SUPPORT PLATE 10mm S/S BASE PLATE FIXED TO CONCRETE VIA COUNTERSUNK S/S M12 CHEM ANCHORS

- SL04 REFER TO DETAIL

REINFORCEMENT DETAILS TO BE PROVIDED WITH SHOP DRAWINGS

SUBSURFACE DRAIN REFER ENGINEERS DOCUMENTATION

CONCRETE FOOTINGS. REFER ENGINEER'S DRAWINGS

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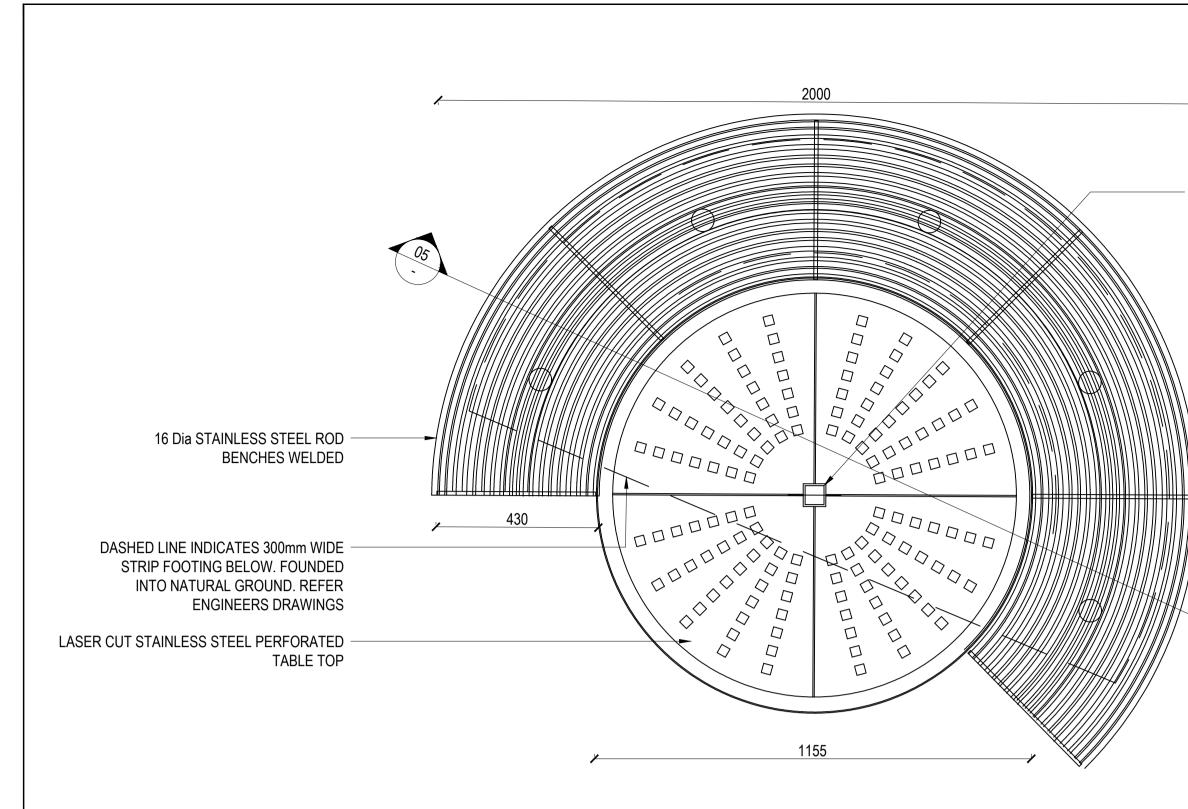
ISSUE	CODE	ISSUE DESCRIPTION	BY	СНК	DATE		
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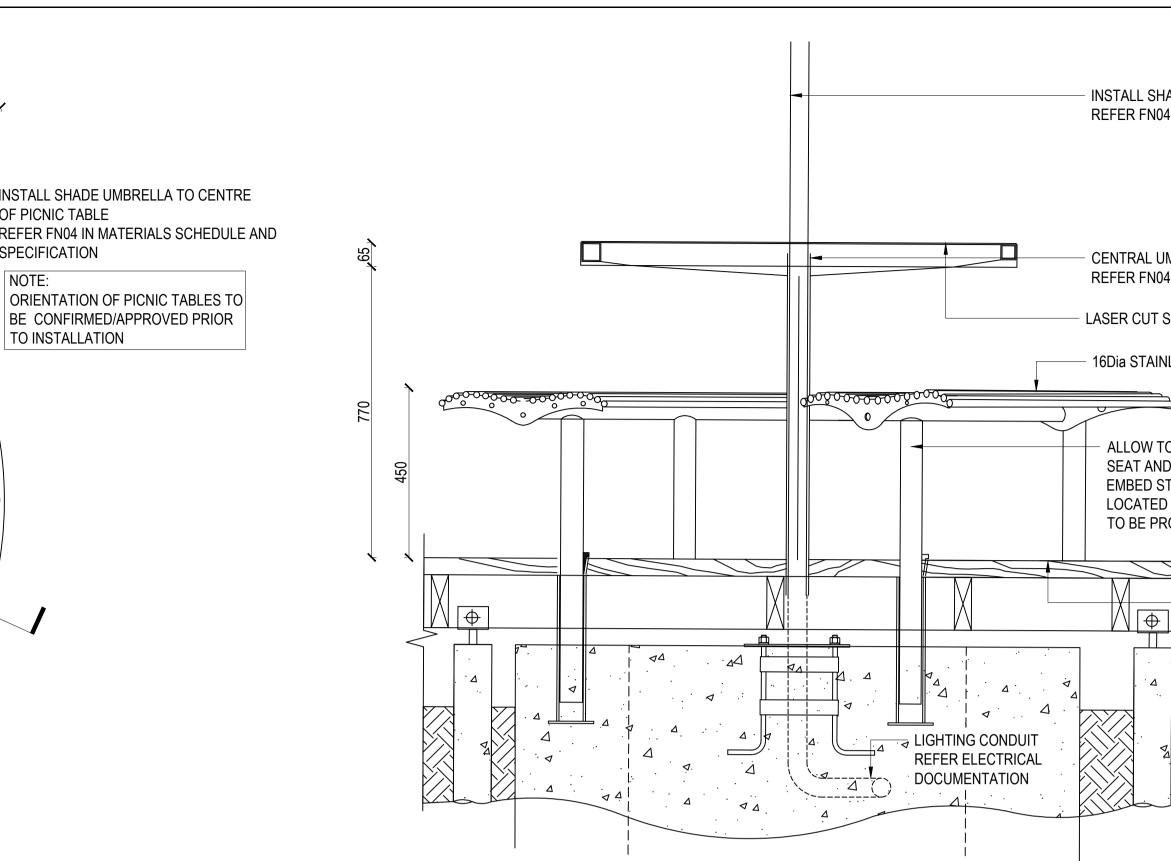


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CUSTOM SEAT TYPE 6 - PICNIC TABLE IN DECK 924 SCALE 1:10



- CUSTOM SEAT TYPE 6 PICNIC TABLE IN DECK 2 **∖924** ∕
- SCALE 1:10

- NOTE: ORIENTATION OF PICNIC TABLES TO
- SPECIFICATION
- REFER FN04 IN MATERIALS SCHEDULE AND
- OF PICNIC TABLE
- INSTALL SHADE UMBRELLA TO CENTRE


- INSTALL SHADE UMBRELLA TO CENTRE OF PICNIC TBALE REFER FN04 IN MATERIALS SCHEDULE AND SPECIFICATIONS

CENTRAL UMBRELLA FIXING. REFER FN04. SHADE UMBRELLA

LASER CUT STAINLESS STEEL TABLE TOP

16Dia STAINLESS STEEL ROD BENCHES WELDED

ALLOW TO PROVIDE ADDITIONAL LENGTH IN SEAT AND TABLE POSTS TO ADEQUATELY EMBED STRUCTURES IN CONCRETE FOOTING LOCATED BELOW DECK STRUCTURE. DETAILS TO BE PROVIDED WITH SHOP DRAWINGS

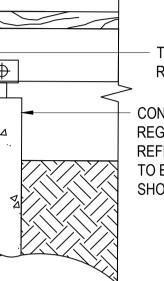

- TD01. TIMBER DECK REFER DETAIL XX/XXX

CONCRETE FOOTING REGBOLTS AND SOCKETS REFER MANUFACTURES DRAWINGS. TO BE APPROVED BY ENGINEER. SHOP DRAWINGS TO BE PROVIDED

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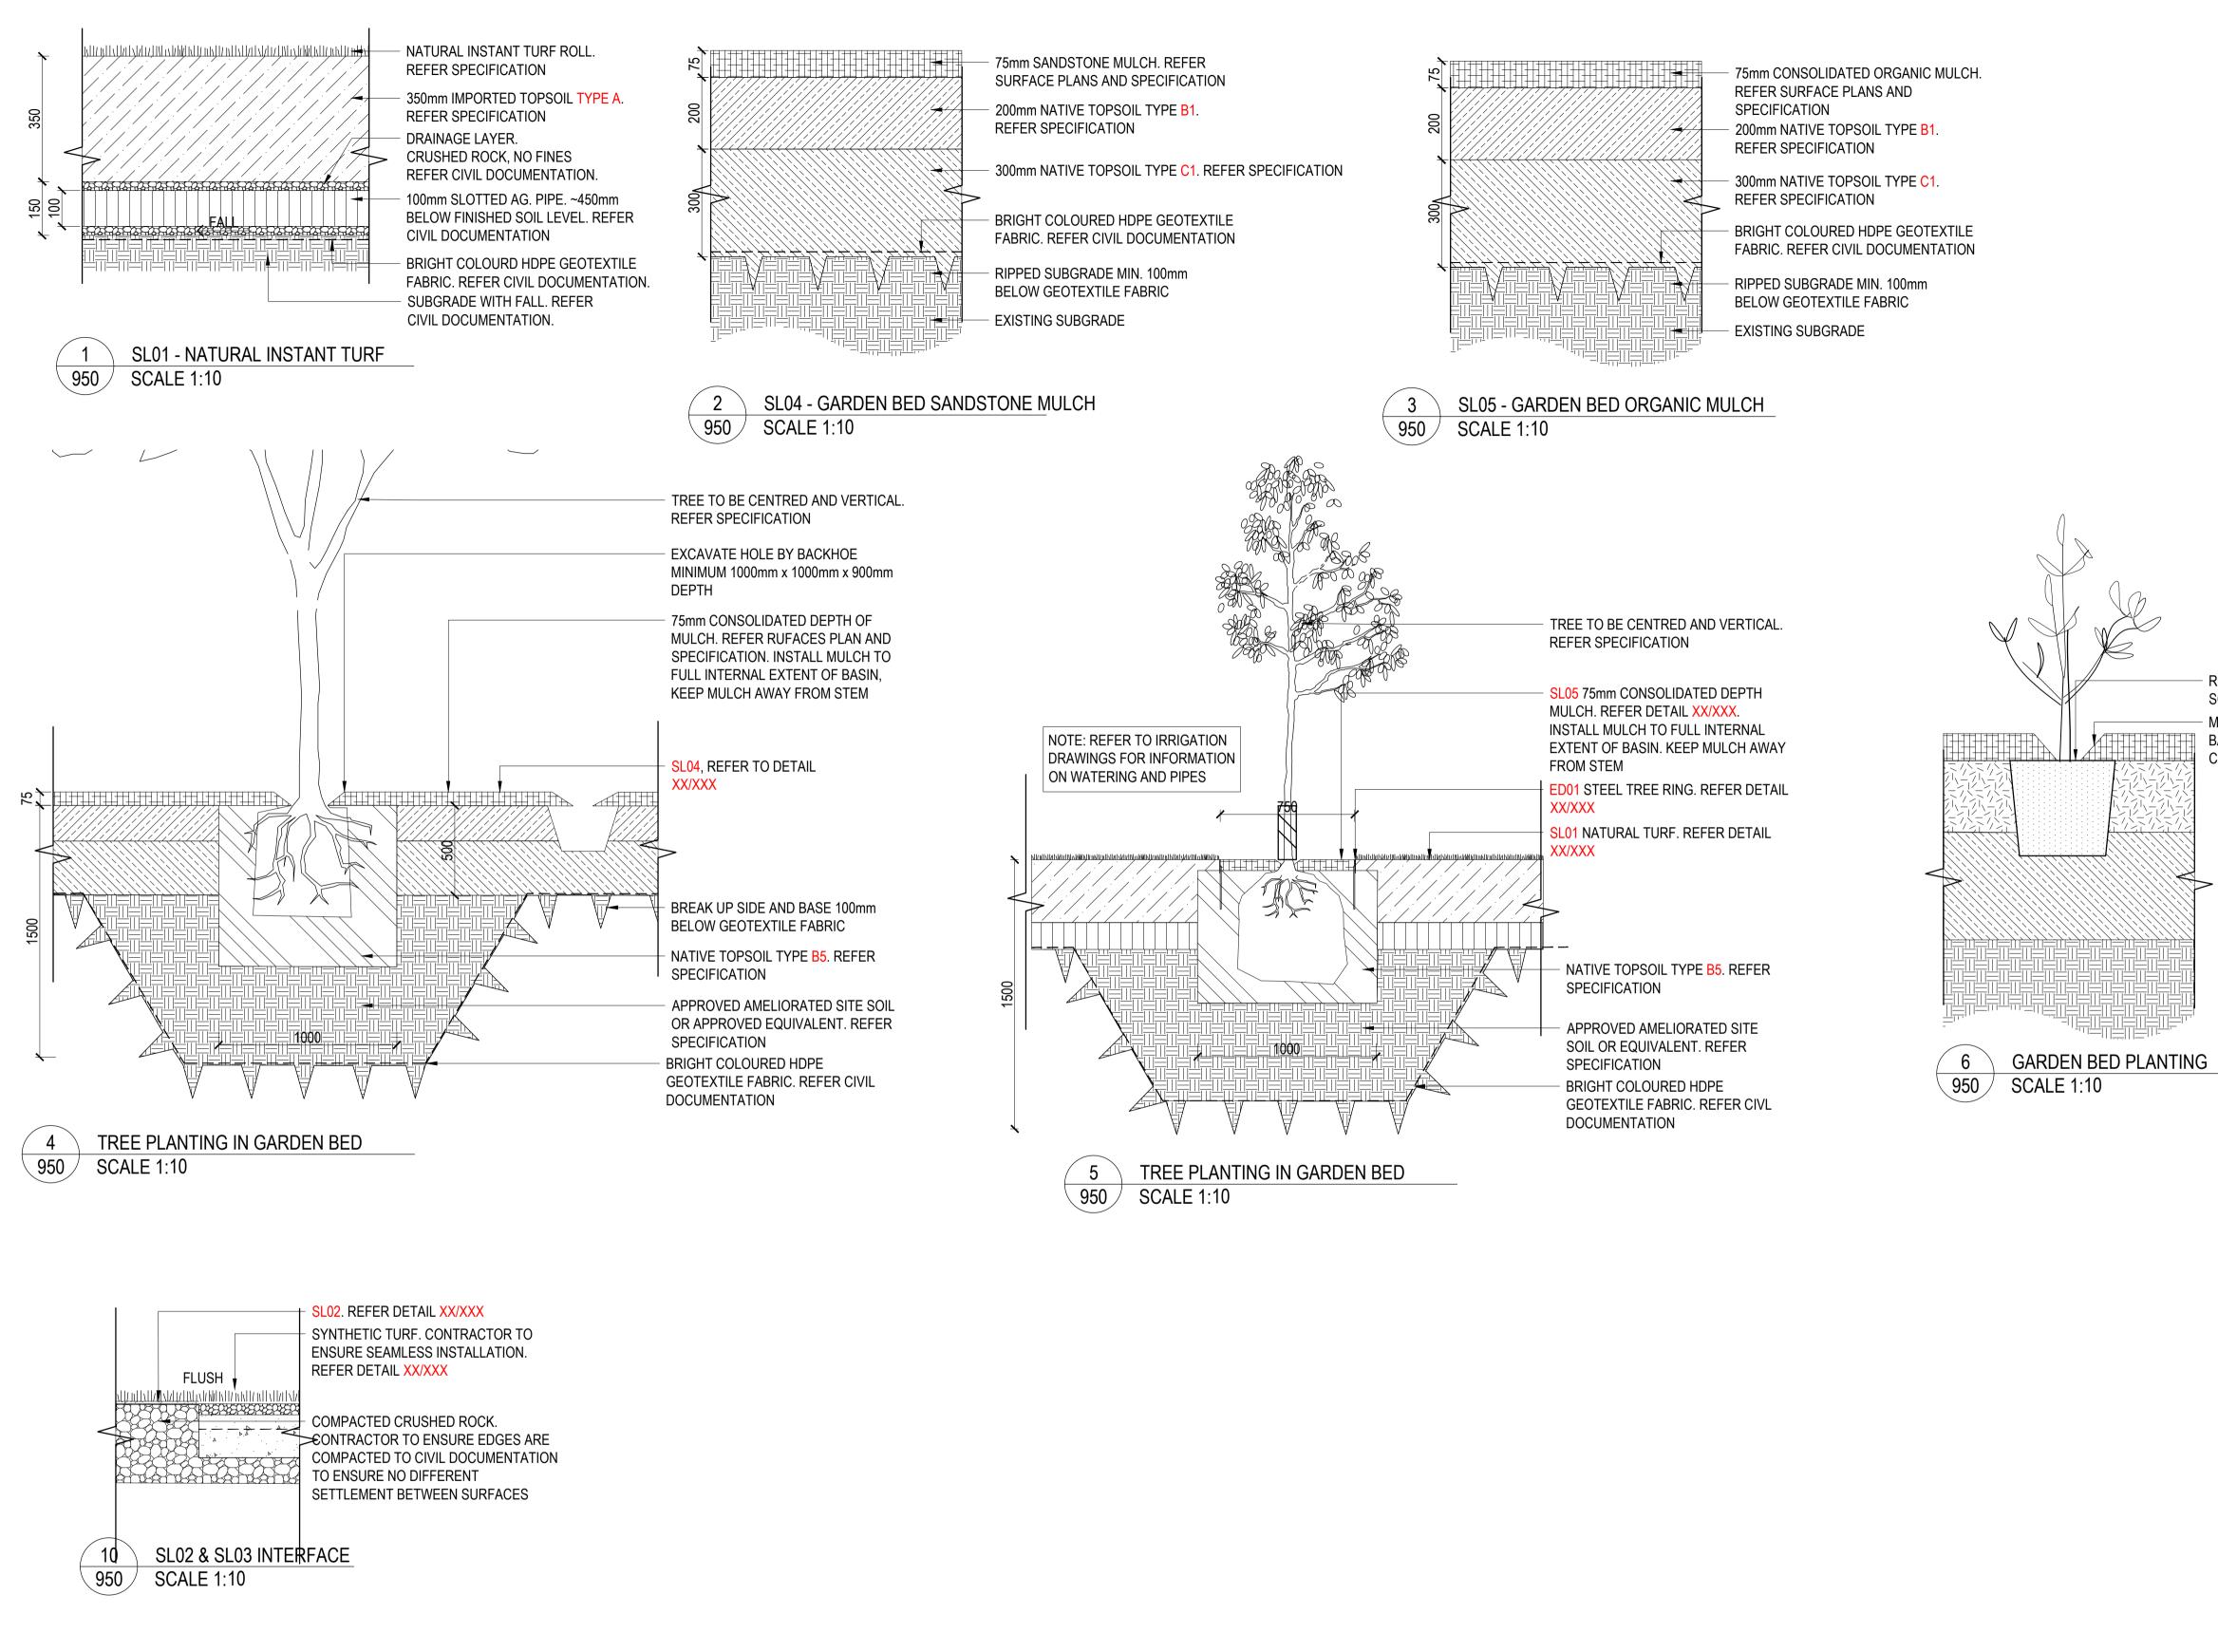
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ROOTBALL TO BE LEVEL WITH TOP OF SOIL

 MULCH MUST NOT BE PLACED AGAINST BASE OF STEM OR PLANT FAILURE COULD OCCUR

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SOFTSCAPE DETAILS



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