

## TYPICAL ELECTRICAL & COMMS CONDUIT ARRANGEMENT FOOTPATH & GARDEN AREA

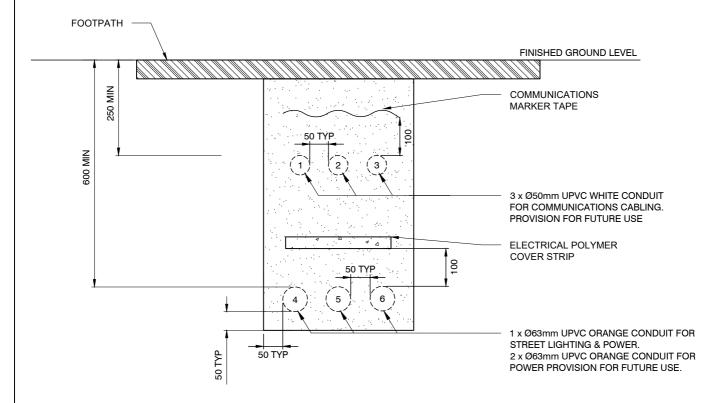


## TYPICAL ELECTRICAL & COMMS CONDUIT ARRANGEMENT (ROAD)

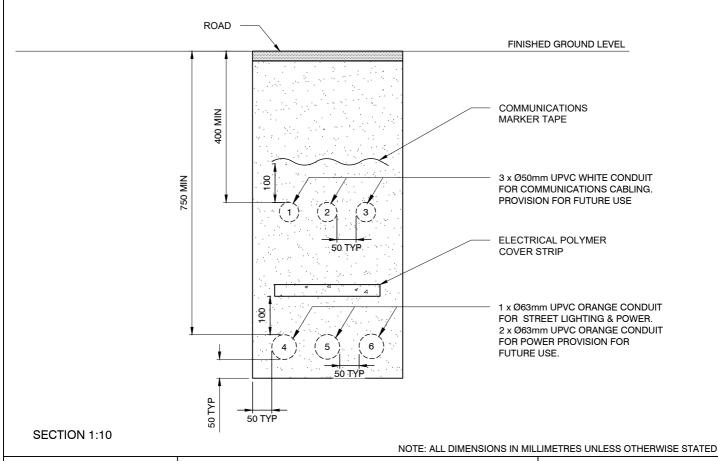

CITY OF SYDNEY **(4)** 


GENERAL
CONDUITS IN FOOTWAY AND CARRIAGEWAY

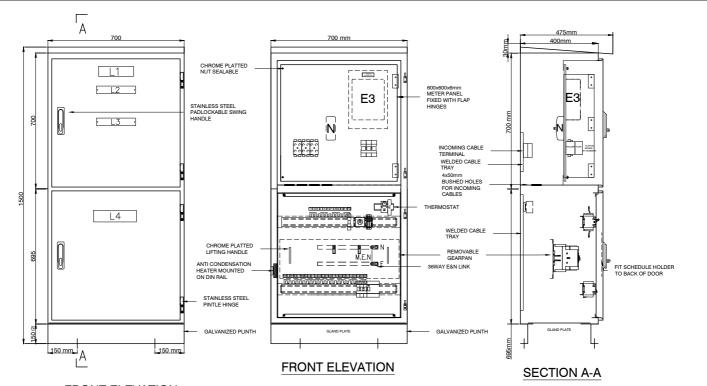

## FRONT ELEVATION (WITH DOORS FITTED)


## (WITH DOORS REMOVED)

| MINOR EQUIPMENT SCHEDULE    |                               |                           |                        |     |  |  |  |
|-----------------------------|-------------------------------|---------------------------|------------------------|-----|--|--|--|
| ITEMS                       | DESCRIPTION                   | REFERENCE                 | PART NO.               | QTY |  |  |  |
| SERVICE FUSES               | IPD SERIES 7 SERVICE FUSE BA  | CK CONNECTION + FUSE LINK | #S71002BBWAI+RHLF100   | 3   |  |  |  |
| THREE PHASE METER           | SUPPLIED AND FITTED BY OTHE   | ERS                       |                        | 1   |  |  |  |
| SERVICE METER NEUTRAL LINK  | NETEC SEALABLE LINKS 3x35 8   | 2x16mm                    | #AN100S-535-B          | 1   |  |  |  |
| MAIN SWITCH CIRCUIT BREAKER |                               |                           |                        | 1   |  |  |  |
| 3P 12-WAY COMB BUSBAR       | 3P 12-WAY 100A COMB BUSBAF    | R WITH ENDCAP             | #SN-A9XPH312           | 1   |  |  |  |
| 3P 24-WAY COMB BUSBAR       | 3P 12-WAY 100A COMB BUSBAF    | R WITH ENDCAP             | #SN-A9XPH324           | 1   |  |  |  |
| 36 WAY BRASS LINKS          | 36 WAY N&E BRIBAR LINKS       |                           | #DB-BRASSLINK-36       | 2   |  |  |  |
| ANTI CONDENSATION HEATER    | IPD - 15W ANTICONDENSATION    | HEATER                    | #RACP-15               | 1   |  |  |  |
| THERMOSTAT                  | IPD - 100 - 250V AC 1NC THERM | OSTAT                     | #TRT-10A230V-NC        | 1   |  |  |  |
| A-O-M SWITCH                | TELUX DIN RAIL MOUNTED 20A    | NON-LOCABLE 2P SWITCH     | #M10HEU1-SMA           | 1   |  |  |  |
| TERMINAL                    | TERMINAL 2.5MM GREY           |                           | #ACC-TERM-GREY-2.5     | 3   |  |  |  |
| SS316 PADLOCKABLE HANDLE    | SWING HANDLE PADLOCKABLE      | - SS316                   | #GEN-HANDLE -SH-PL-316 | 2   |  |  |  |
| MCB                         | 1P 16A 6kA MCB C - CURVE      |                           | #SN-A9F44106           | 1   |  |  |  |
| RCBO                        | 3P 25A 6kA RCBO 30mA C Curv   | е                         | #SN-A9F44350           | 1   |  |  |  |
| RCBO                        | 2P 20A 6kA RCBO 30mA C-CUR    | VE                        |                        | 1   |  |  |  |

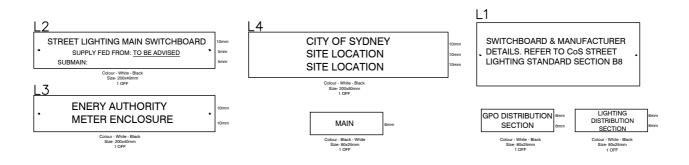

## NOTES:

- 1. TO BE READ IN CONJUNCTION WITH DRAWING 5.1.4
- 2. 75 mm GALVANIZED CHANNEL PLINTH MAY BE USED WITH CONCRETE / ASHPHALT FOOTWAY
- 3. CONCRETE PLINTH SHALL BE USED INSTEAD OF GALVANISED PLINTH IF LONGITUDINAL / CROSS FALL EXCEEDS 5%
- 4. ALL DIMENSIONS IN MILLIMETRES UNLESS OTHERWISE STATED

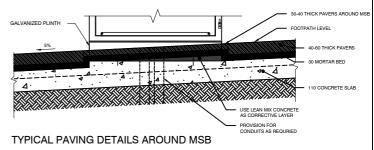




GENERAL
THREE PHASE SWITCHBOARD DETAILS &
SCHEMATICS (SHEET 1)


Rev E
Date 01.0
Approved S A


LIGHTING
E Dwg No.
S A 5.1.3

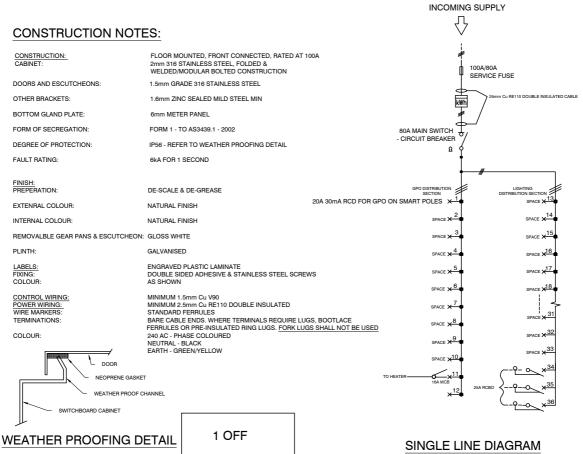

NOTES:

MAIN ISOLATOR TO BE LOCATED IN THE **ENERGY AUTHORITY SECTION. BUS COMB** TO BE FIXED SECURELY TO THE BUSBAR.

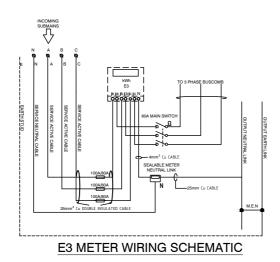

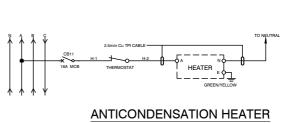

SCHEMATIC DIAGRAM


#### NOTES:

- TO BE READ IN CONJUNCTION WITH DRAWING 5.1.3
- ALL DIMENSIONS IN MILLIMETRES UNLESS OTHERWISE STATED.



**GENERAL** THREE PHASE SWITCHBOARD DETAILS & SCHEMATICS (SHEET 2)


LIGHTING Rev Ε Dwg No. 01.07.25 Date 5.1.4 Approved SA

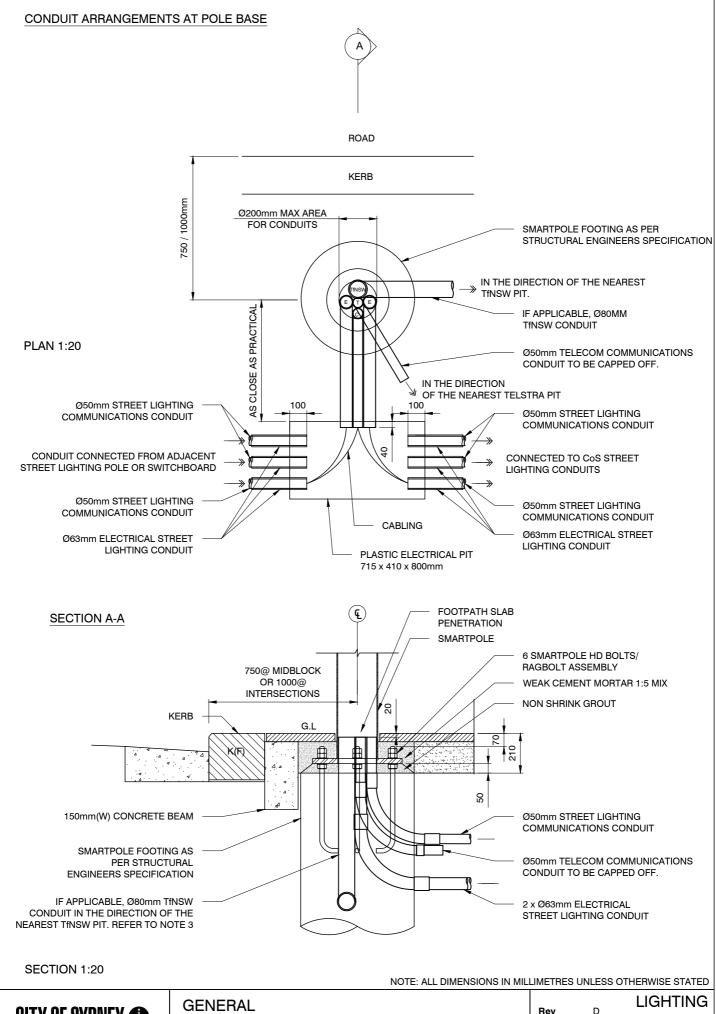

CITY OF SYDNEY **(** 


GENERAL
CONDUITS ARRANGEMENT AT POLE BASE

Rev D
Date 01.12.19 Dwg No.
Approved PS 5.1.5

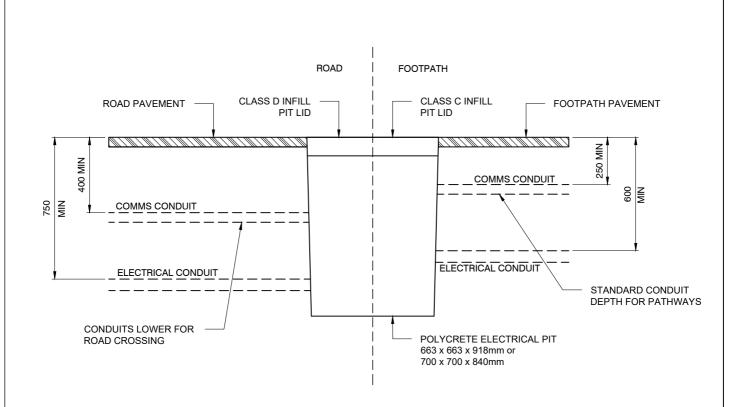

## ELECTRICAL PIT ARRANGEMENT FOR ROAD / FOOTPATH

**SCALE 1:20** 

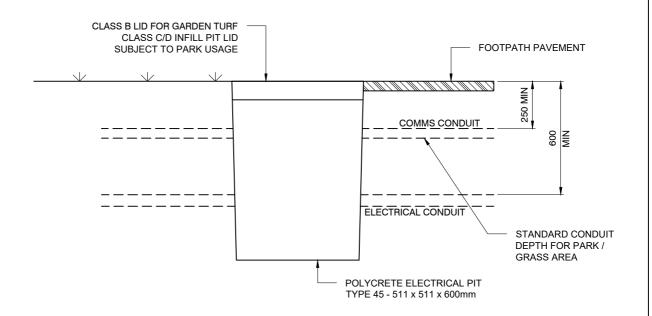


### **ELECTRICAL PIT ARRANGEMENT FOR PARKS**


**SCALE 1:20** 

- NOTES:
  1. PIT LID IS TO HAVE A 75mm DIAMETER STAINLESS STELL DISC ENGRAVED "Cos-Electrical" SET FLUSH WITH LID SURFACE USING EPOXY ADHESIVE. THIS DISC SHOULD BE SLIP RESISTANT.
  2. REFER TO THE MANUFACTURER INSTALLATION INSTRUCTION FOR COMPLETE DETAILS
  3. ALL DIMENSIONS IN MILLIMETRES UNLESS OTHERWISE STATED

CITY OF SYDNEY

LIGHTING **GENERAL** Rev Dwg No. 01.07.25 Date GENERAL LIGHTING PIT ARRANGEMENT 5.1.6 Approved SA

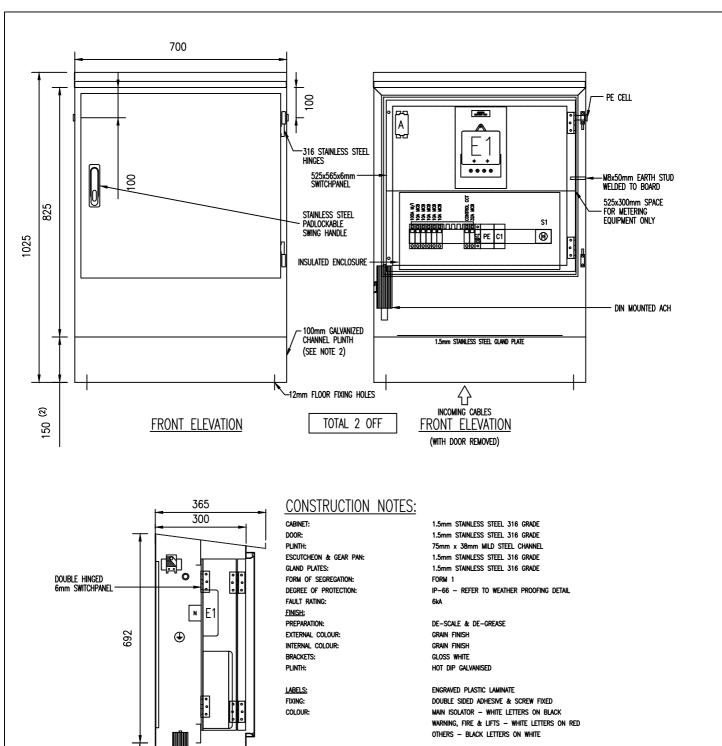

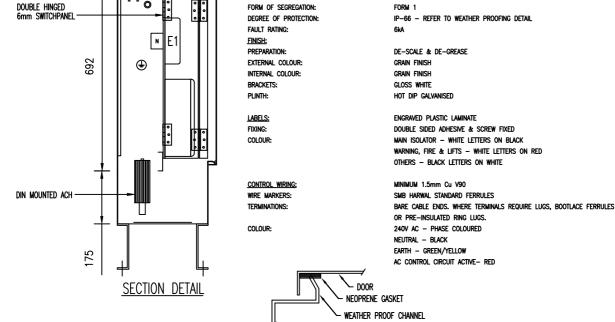

NOTES:

WEATHER PROOFING DETAIL

SWITCHBOARD CABINET


- 1. TO BE READ IN CONJUNCTION WITH DRAWING 5.1.8
- 2. 75 mm GALVANIZED CHANNEL PLINTH MAY BE USED WITH CONCRETE / ASHPHALT PAVING
- 3. ALL DIMENSIONS IN MILLIMETRES UNLESS OTHERWISE STATED.


# CITY OF SYDNEY

**GENERAL** SINGLE PHASE SWITCHBOARD DETAILS & SCHEMATICS (SHEET 1)

LIGHTING Rev Dwg No. 01.07.25 Date 5.1.7 Approved SA

| EQUIPMENT SCHEDULE        |  |                          |     |       |  |  |
|---------------------------|--|--------------------------|-----|-------|--|--|
| ITEMS                     | ITEMS INFORMATION  |                          |     | TOTAL |  |  |
|                           | DESCRIPTION  | PART NUMBER              | QTY | TOTAL |  |  |
| SERVICE FUSE              | IPD SERIES 7 SERVICE FUSE                                  | ACC-FUS-C1002BBWAI       | 1   | 2     |  |  |
|                           | FITTED WITH FUSE LINK                                      | ACC-FUS-LRHLF-100        | 1   | 2     |  |  |
| SINGLE PHASE METER        | SUPPLIED AND FITTED BY OTHERS                              |                          | 1   | 2     |  |  |
| SEALABLE NEUTRAL LINK     | NETEC SEALABLE LINK 100A                                   | AN100S-535-B             | 1   | 2     |  |  |
| DOOR SWING HANDLE         | STAINLESS STEEL PADLOCKABLE SWING HANDLE                   | GEN-HANDLE-SH-PL-316     | 1   | 2     |  |  |
| INSULATED ENCLOSURE       | CLIPSAL 24 MODULE SURFACE MOUNTING INSULATED ENCLOSURE     | SN-4CF24FD               | 1   | 2     |  |  |
| 1P 12-WAY COMB BUSBAR     | SCHNEIDER 1P 12-WAY 80A COMB BUSBAR                        | SN-BUSCOMB12P            | 1   | 2     |  |  |
| 1P 100A ISOLATOR          | SCHNEIDER 1P 100A ISOLATOR                                 | SN-A9S66191              | 1   | 2     |  |  |
| 1P 32A MCB                | SCHNEIDER 1P 32A MCB 6kA C-CURVE                           | SN-A9F44132              | 1   | 2     |  |  |
| 1P 10A MCB                | SCHNEIDER 1P 10A MCB 6kA C-CURVE (GLEBE ST SW =7 & JOH     | NES ST SW=2) SN-A9F44110 | -   | 9     |  |  |
| LIGHT SENSITVE SWITCH     | SCHNEIDER IC200 LIGHT SENSITIVE SWITCH COMPLETE WITH PRE-V | VIRED PE CELL SN-15284   | 1   | 2     |  |  |
| 4P CONTACTOR [C1]         | SCHNEIDER 4P 25A N/O CONTACTOR 240V AC COIL                | SN-A9C20834              | 1   | 2     |  |  |
| SELECTOR SWITCH [S1]      | TELUX SURFACE MOUNT CHANGEOVER SWITCH ENGRAVED AUTO-OF     | F-MAN BA-M10HSMAU1       | 1   | 2     |  |  |
| SURGE DIVERTER            | LDU GKSDL SINGLE PHASE SINGLE MODE 50KA SURGE DIVERTER     | LD-GKSDL1-50-275         | 1   | 2     |  |  |
| ANTI-CONDENSATION HEATERS | IPD- 240VAC 100W HEATER                                    | IP-RACM-100              | 1   | 2     |  |  |
| THERMOSTAT                | IPD - THERMOSTAT 1 N/C 10A 230VAC                          | IP-TRT-10A230-NC         | 1   | 2     |  |  |

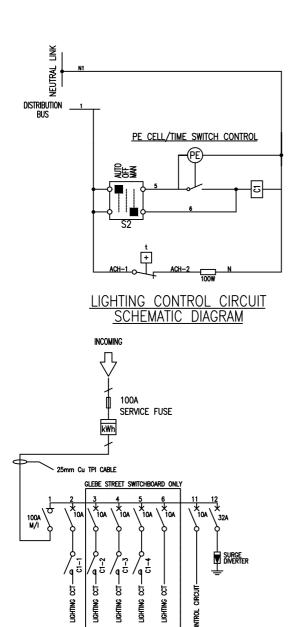

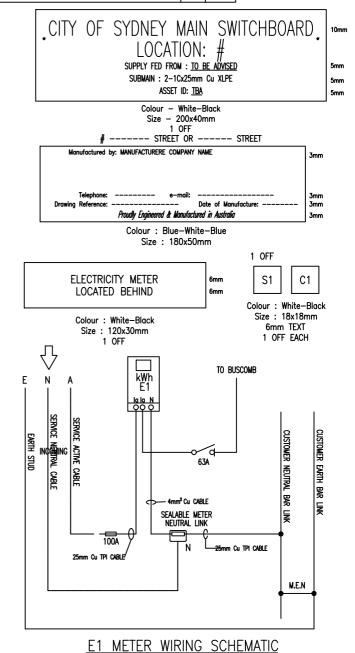

#### NOTES:

- 1. TO BE READ IN CONJUNCTION WITH DRAWING 5.1.7
- 2. ALL DIMENSIONS IN MILLIMETRES UNLESS OTHERWISE STATED.

SINGLE LINE DIAGRAM



GENERAL
SINGLE PHASE SWITCHBOARD DETAILS &
SCHEMATICS (SHEET 2)

| LIGHTING | Rev | D | Dwg No. | Date | 01.12.19 | Dwg No. | Dwg N

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**Approved** 

5.1.8